




OVERALL SITE PLAN

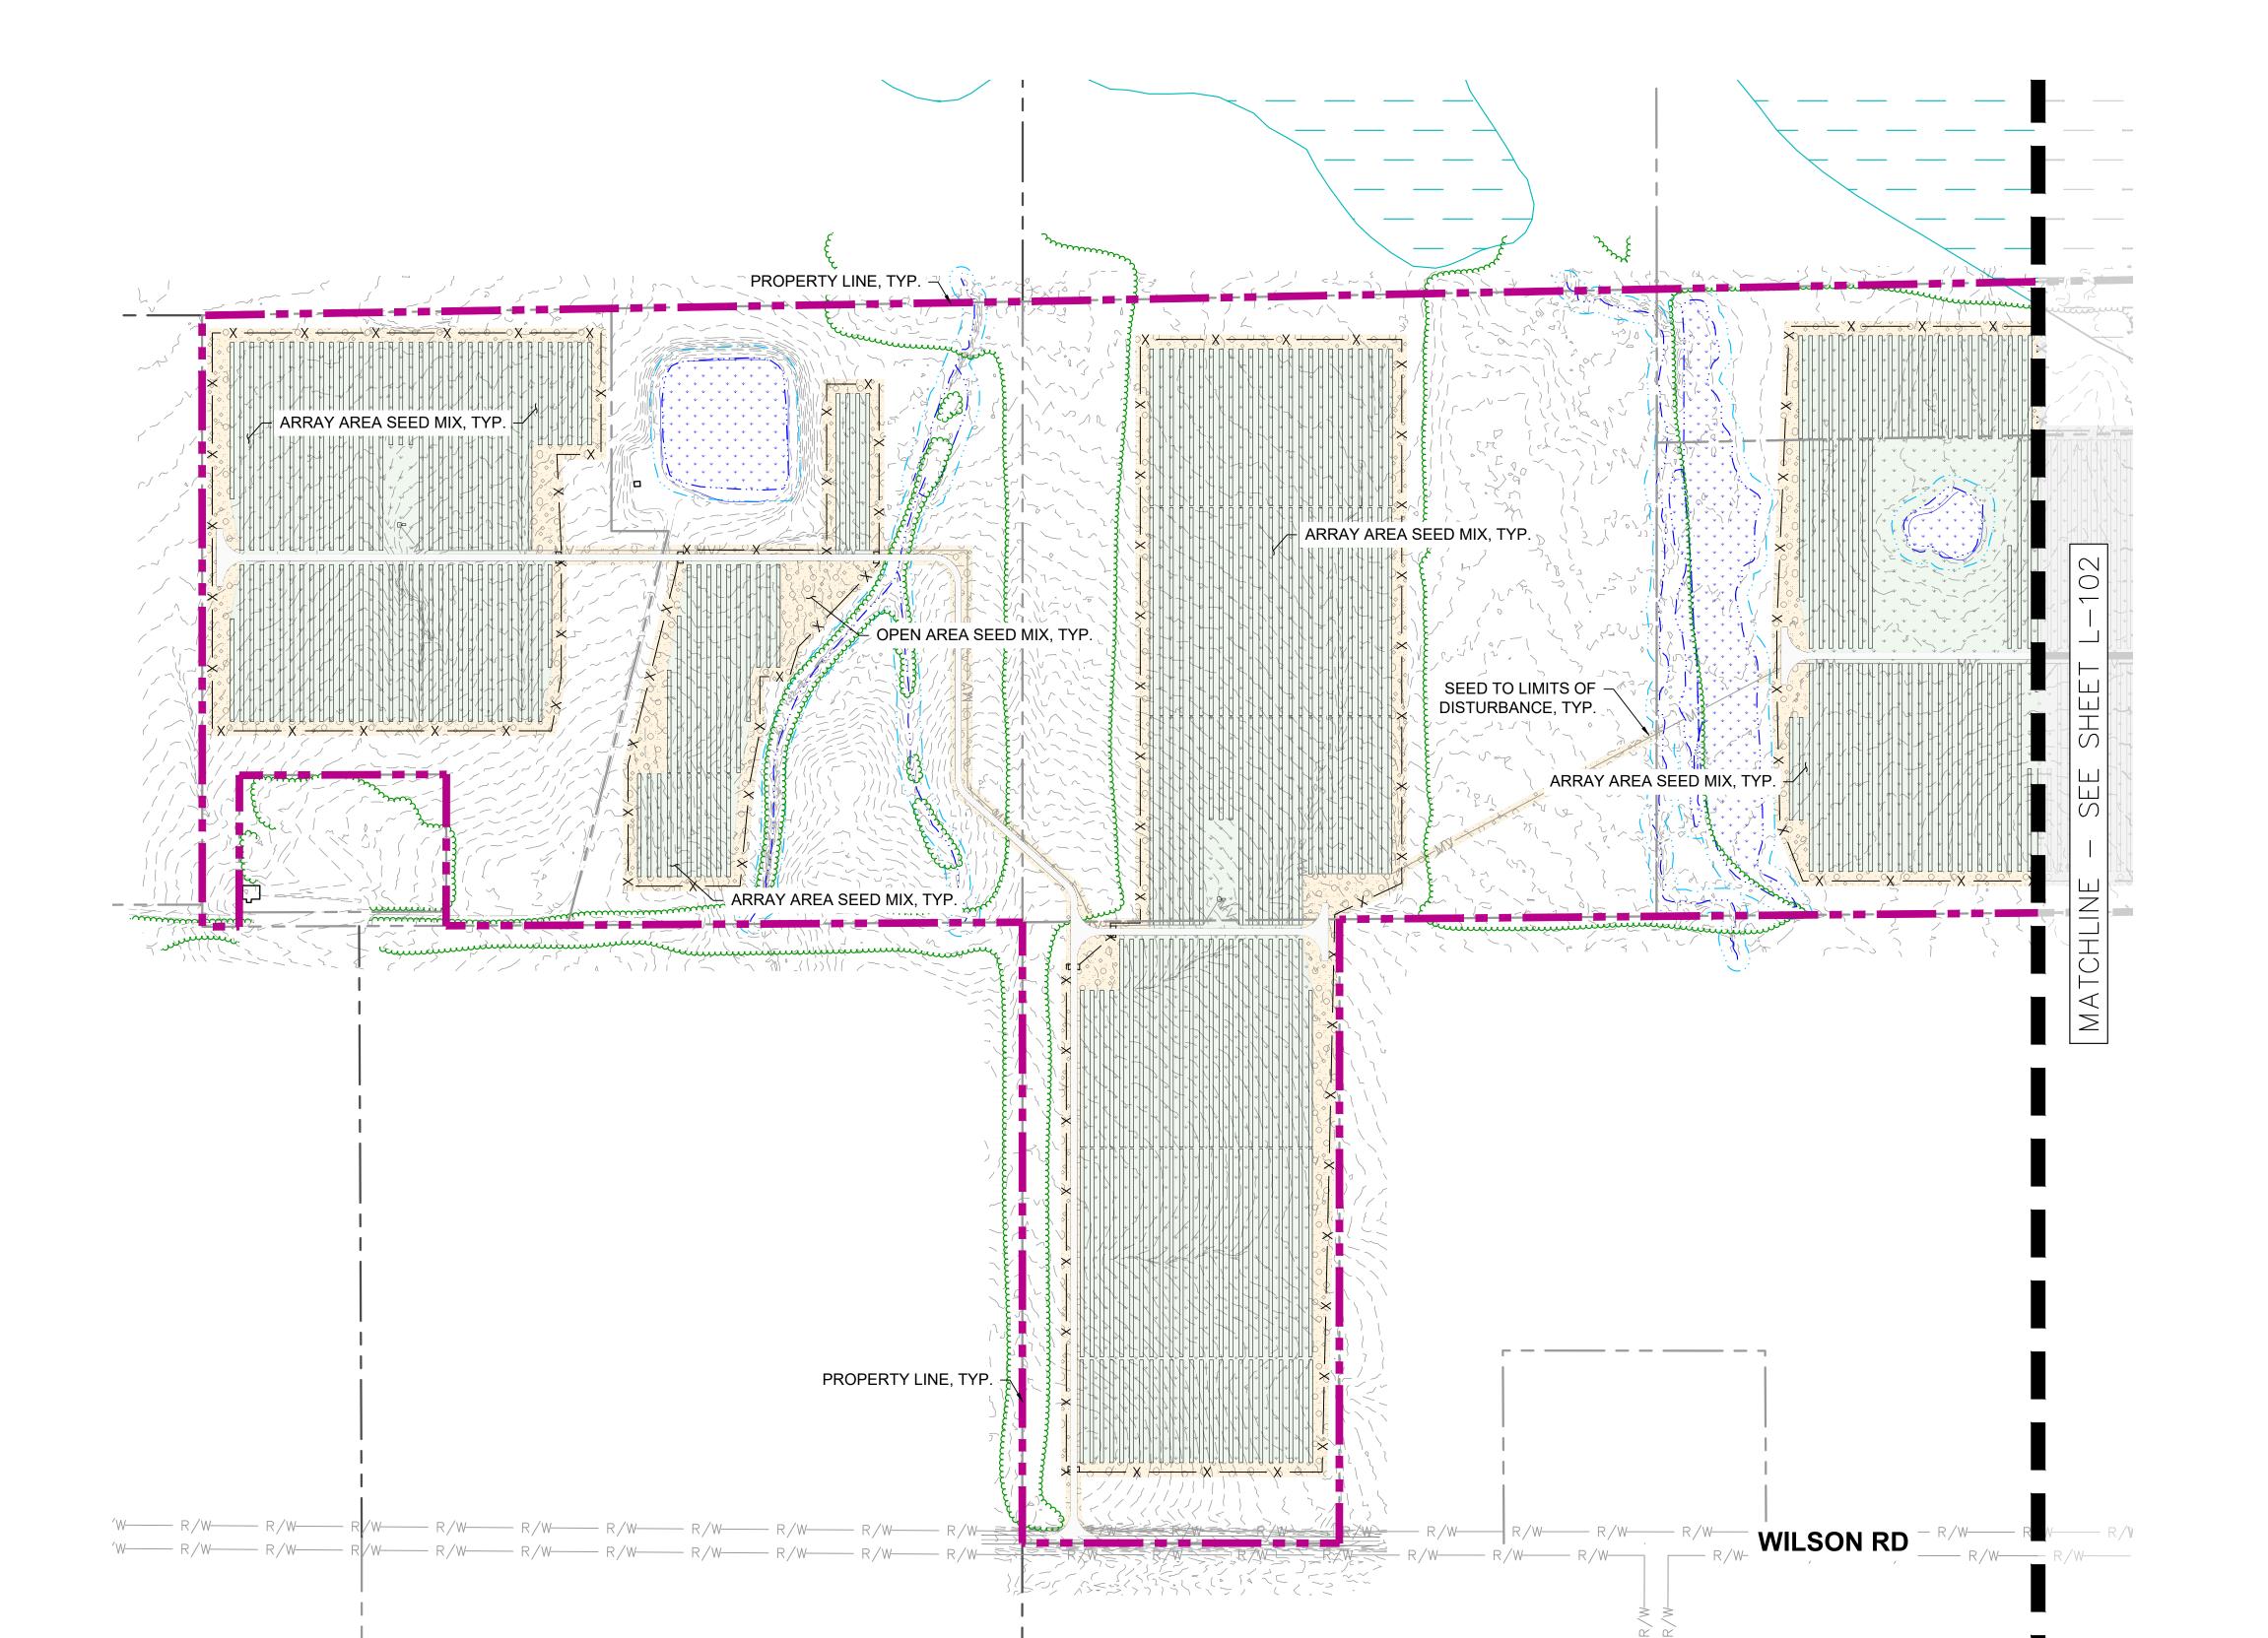

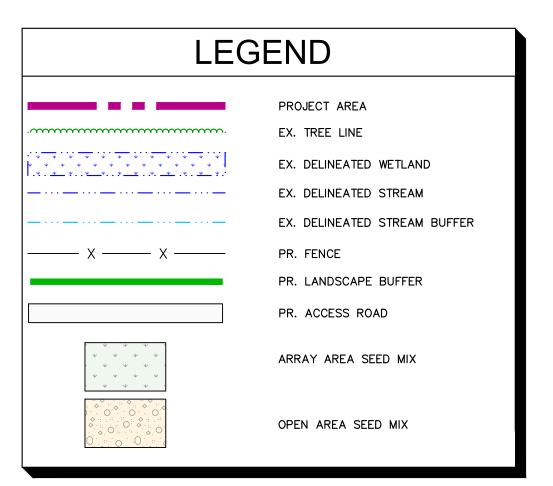

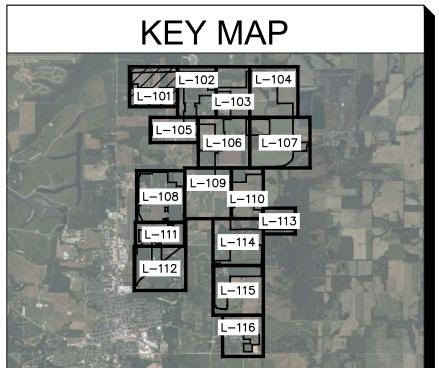






SHEET NUMBER L-101


0

Y

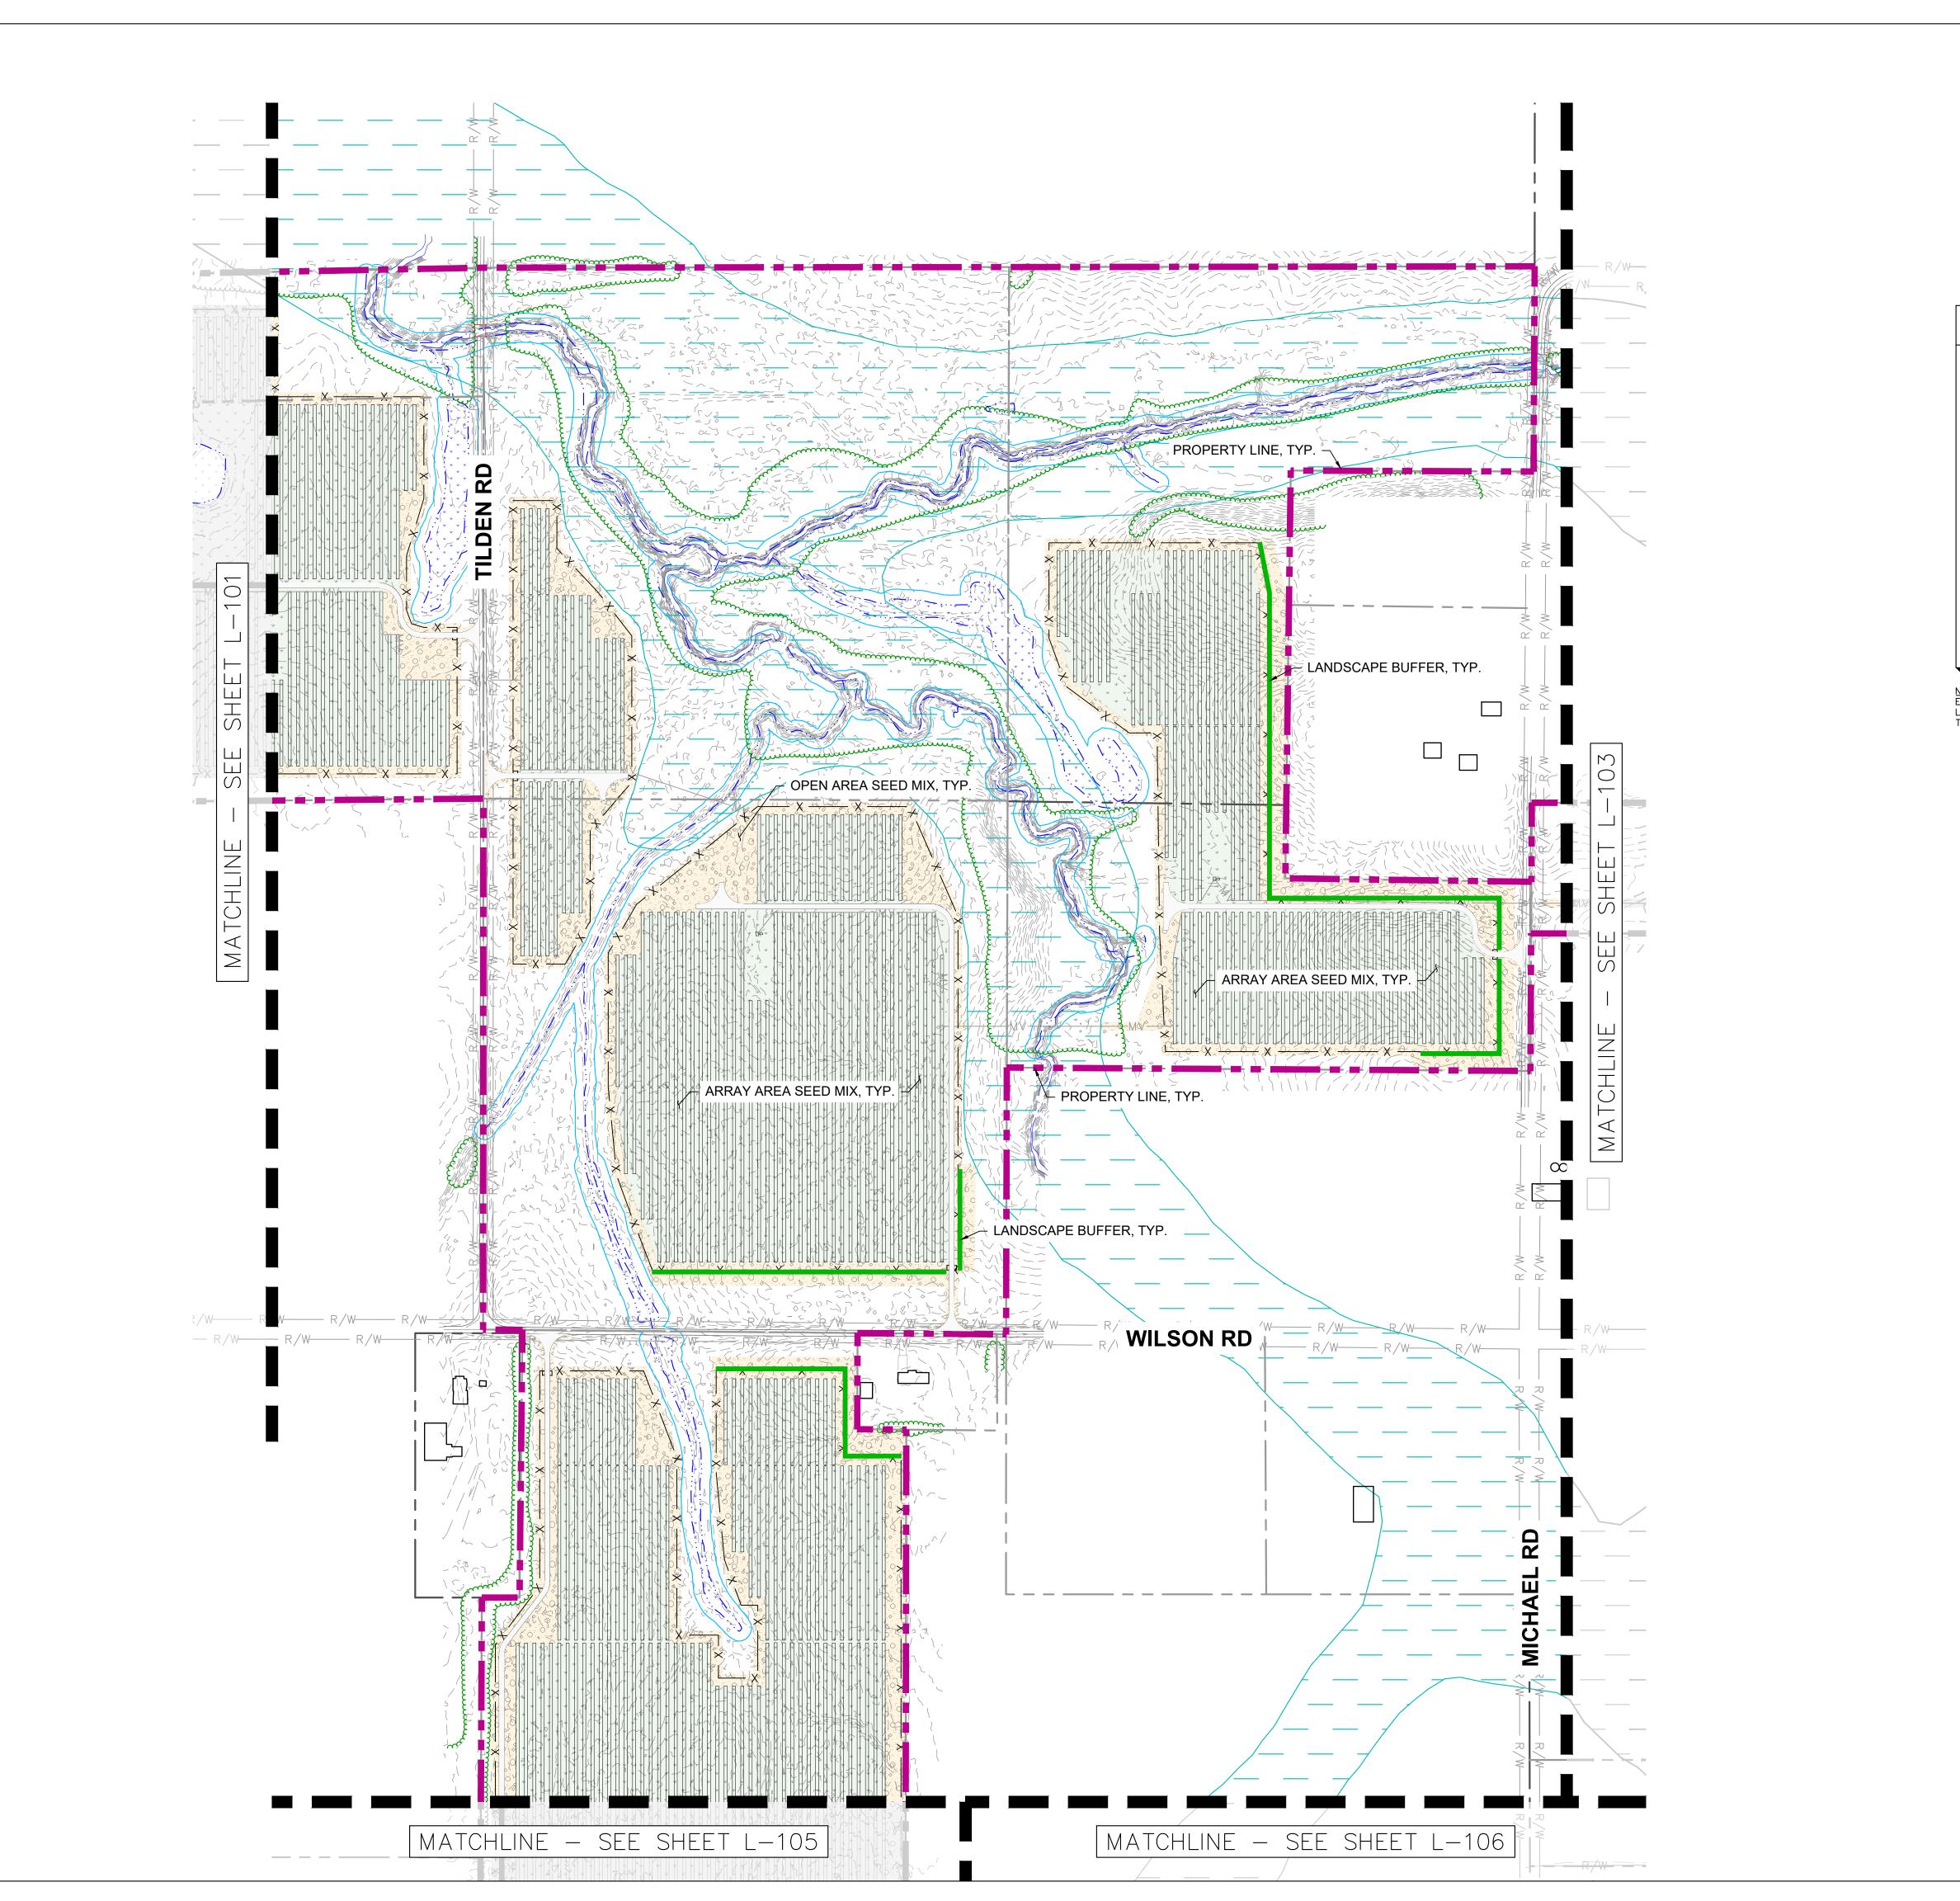


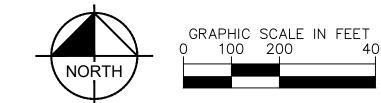

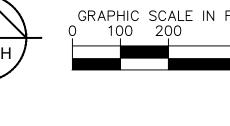

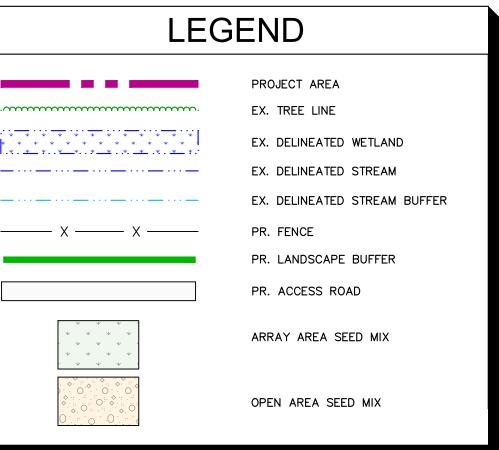

KEY MAP

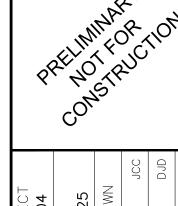



ANDSCAPE PLAN


SHEET NUMBER

Call Before You Dig


L-102

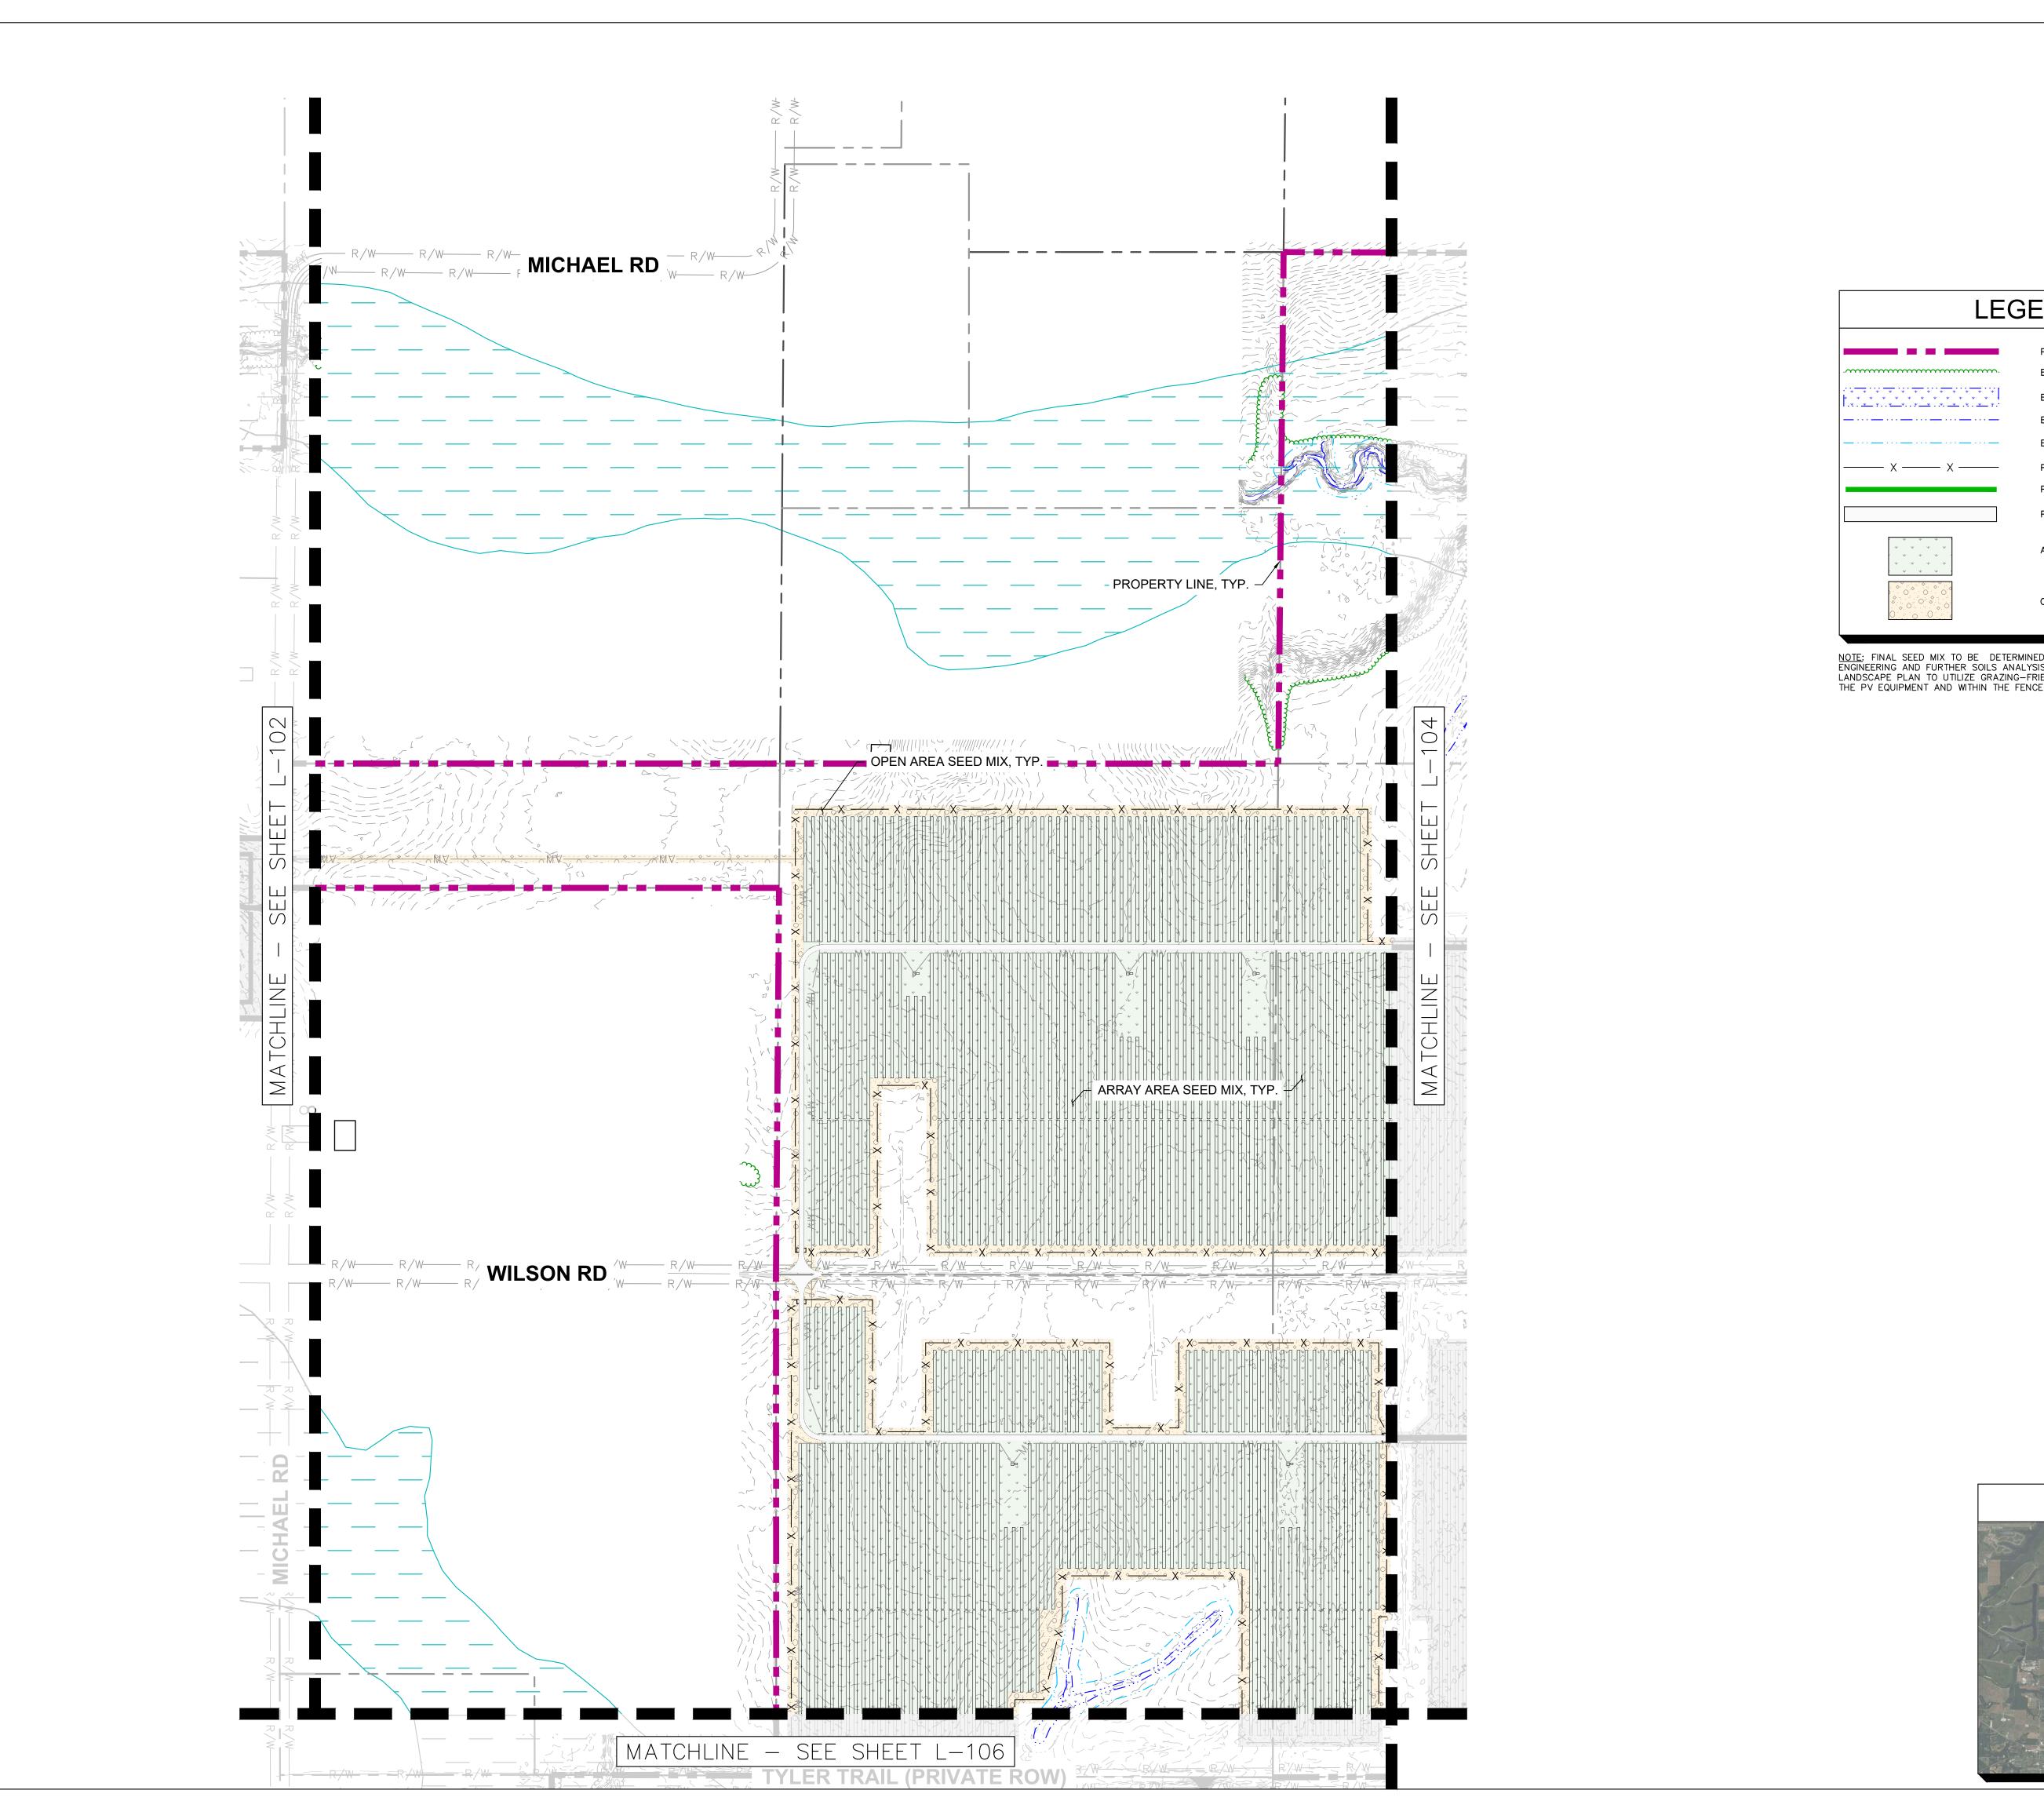

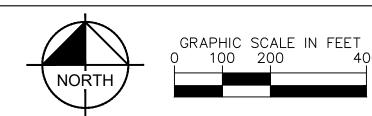


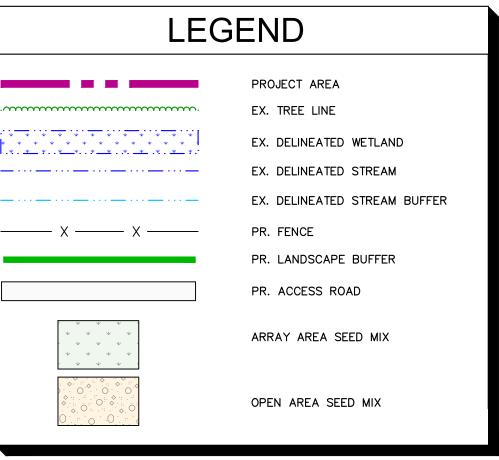

KEY MAP

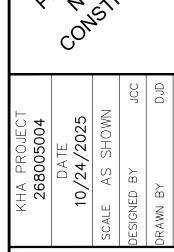

Call Before You Dig

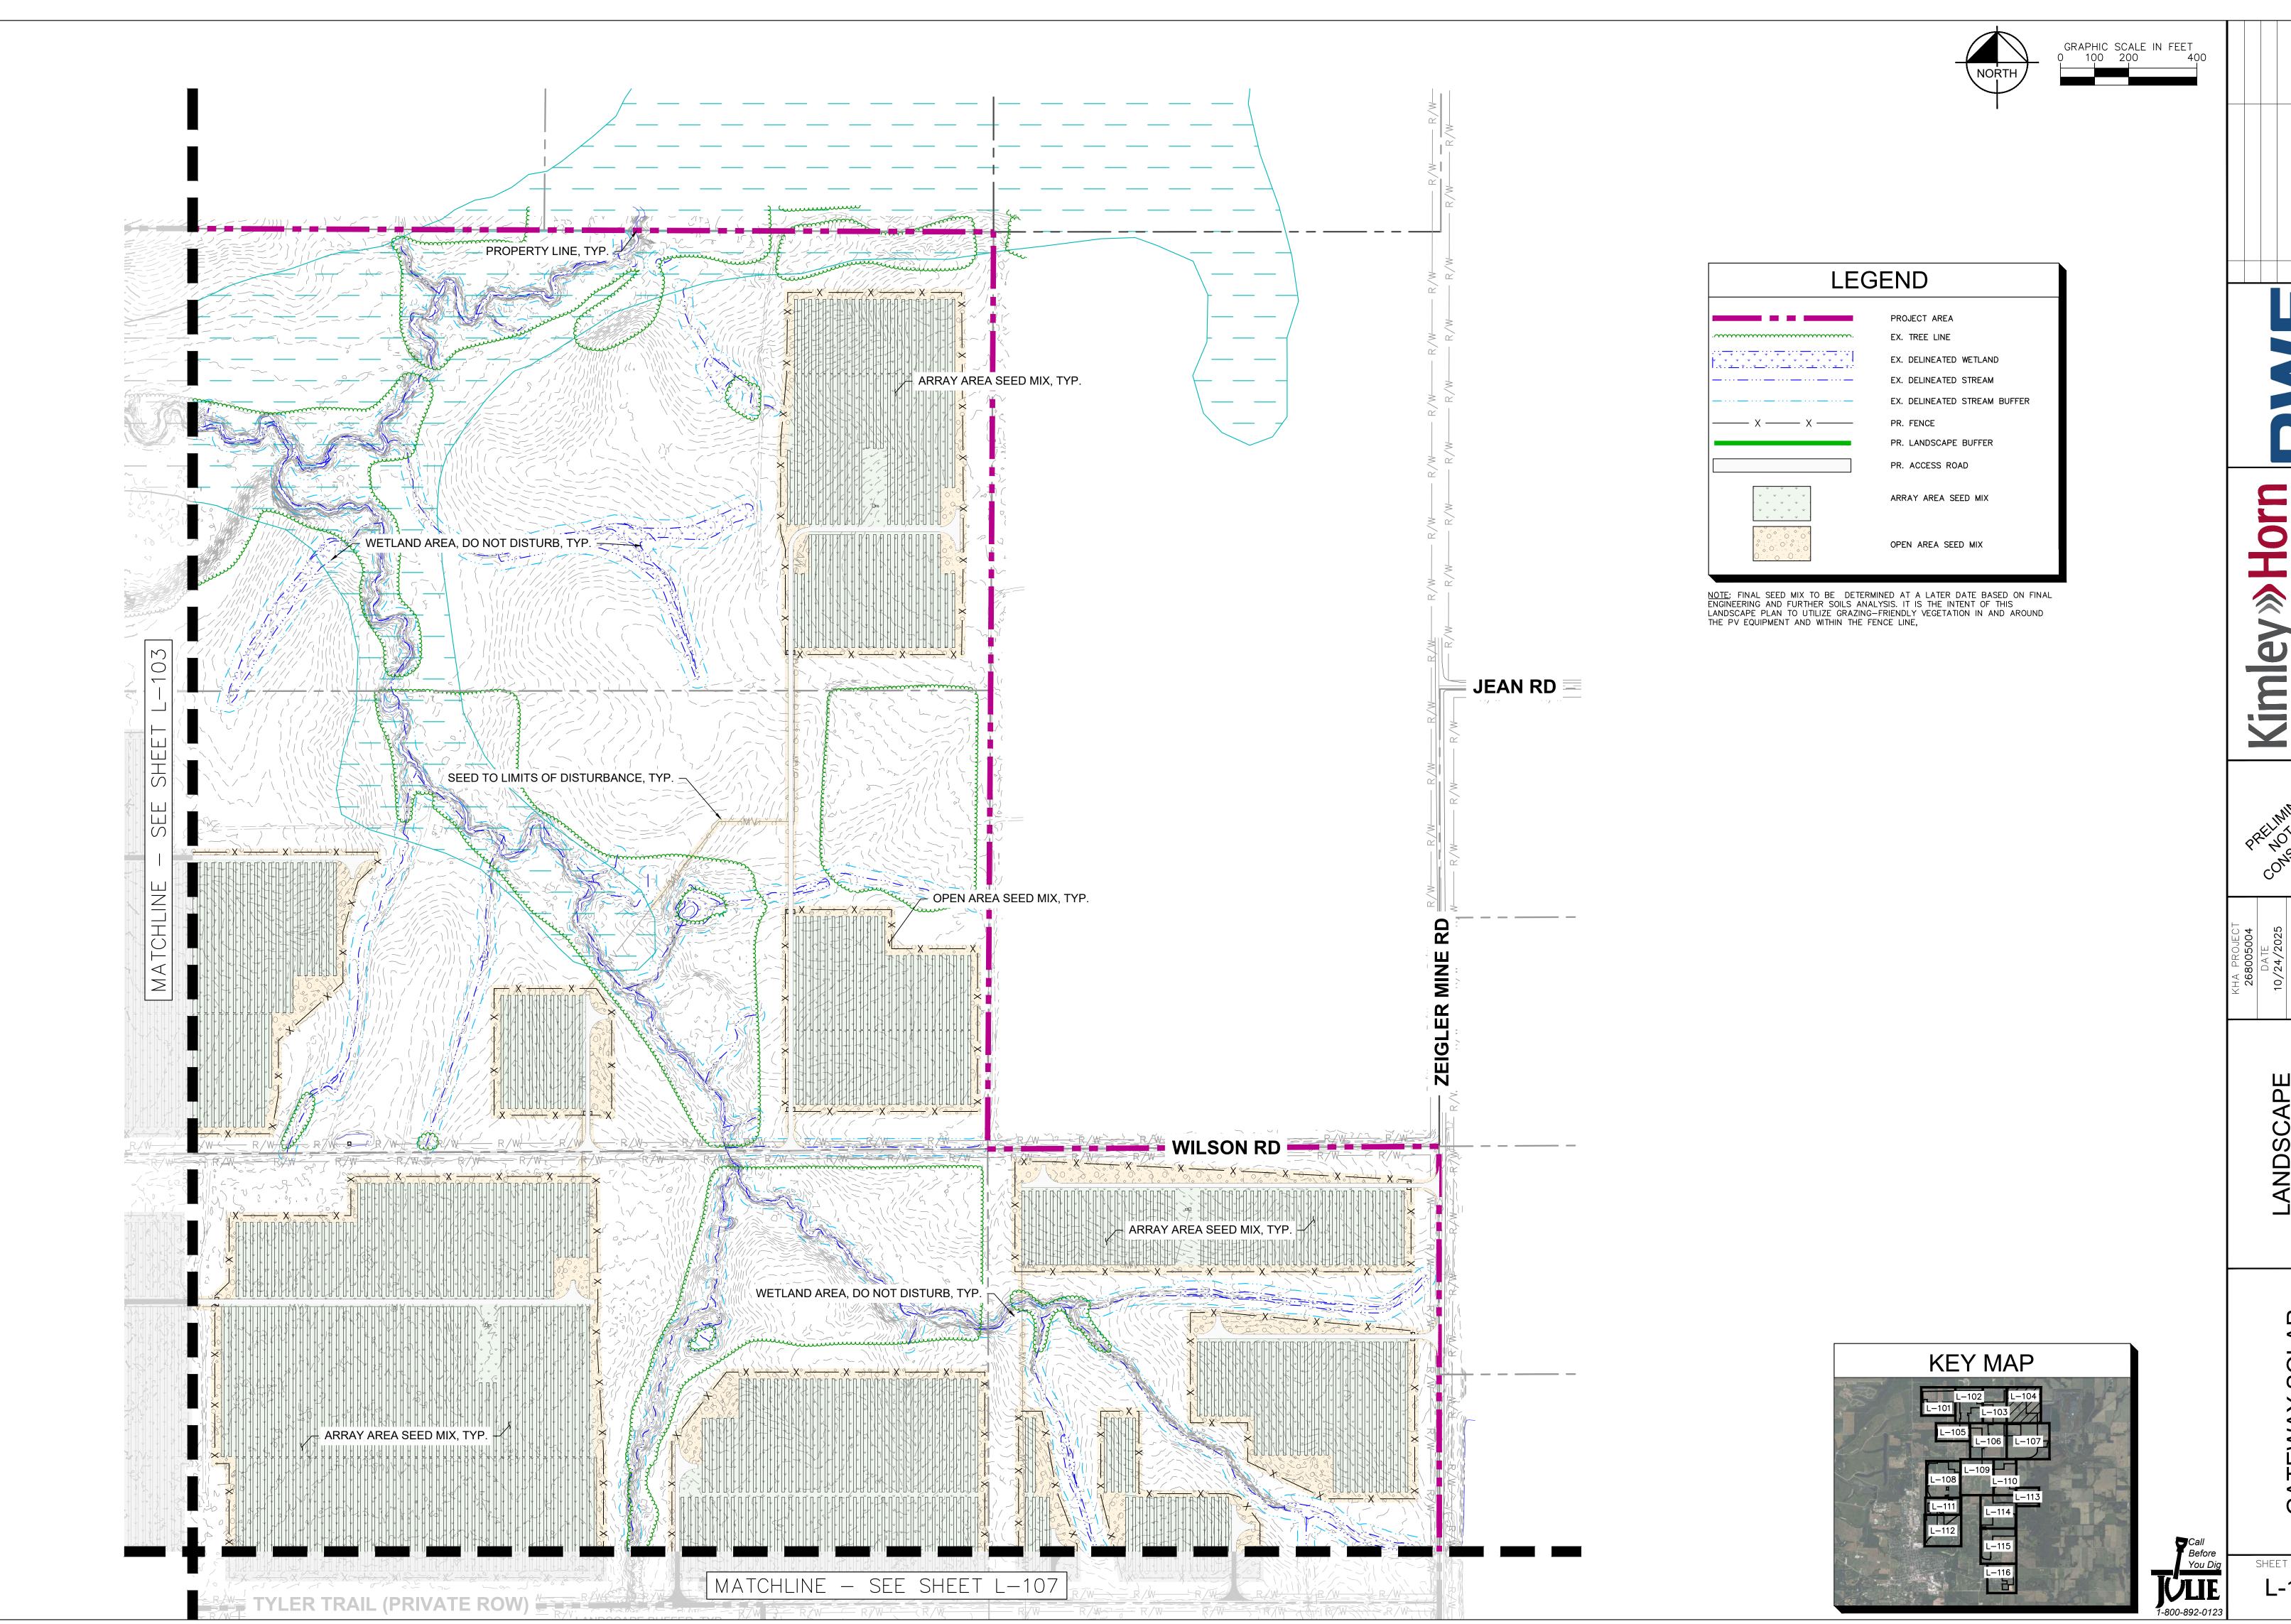

LEGEND EX. TREE LINE EX. DELINEATED WETLAND EX. DELINEATED STREAM EX. DELINEATED STREAM BUFFER PR. FENCE PR. LANDSCAPE BUFFER PR. ACCESS ROAD


NOTE: FINAL SEED MIX TO BE DETERMINED AT A LATER DATE BASED ON FINAL ENGINEERING AND FURTHER SOILS ANALYSIS. IT IS THE INTENT OF THIS LANDSCAPE PLAN TO UTILIZE GRAZING—FRIENDLY VEGETATION IN AND AROUND THE PV EQUIPMENT AND WITHIN THE FENCE LINE,


ARRAY AREA SEED MIX OPEN AREA SEED MIX

_ANDSCAPE PLAN


SHEET NUMBER L-105


Call Before You Dig

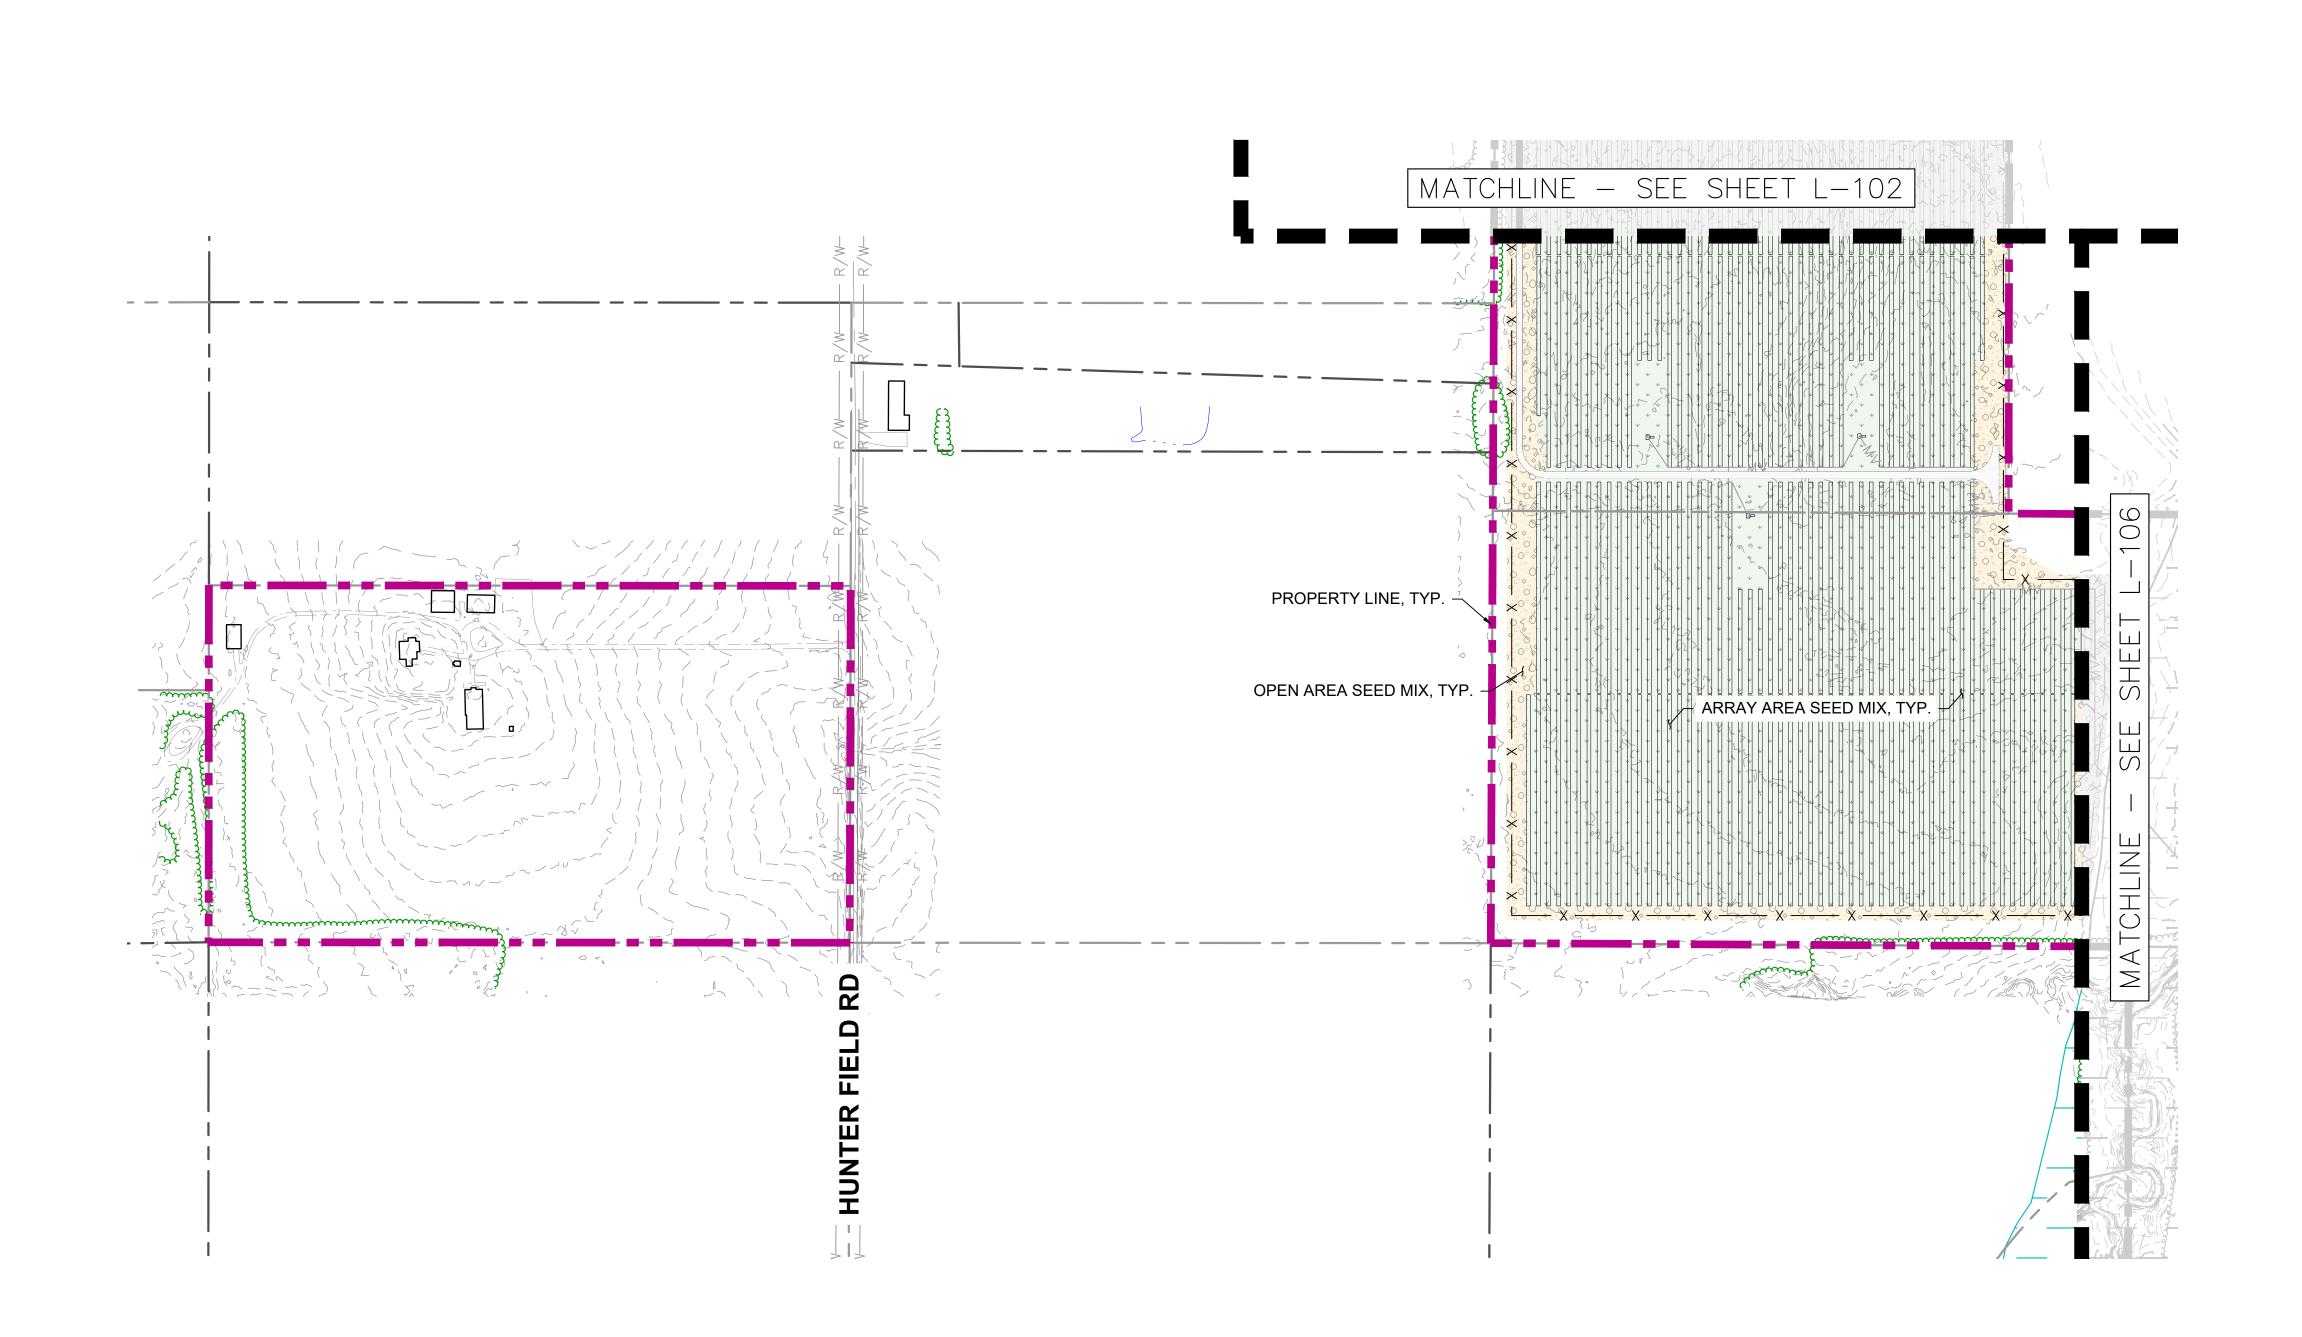

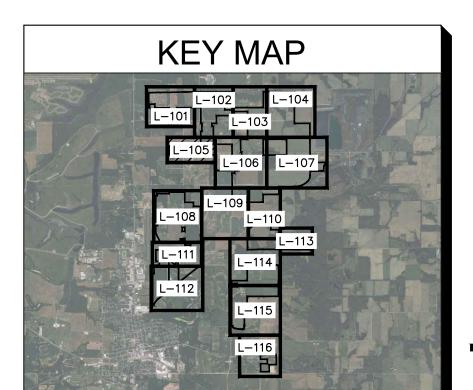





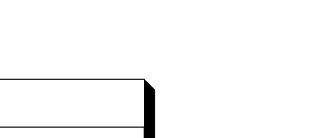


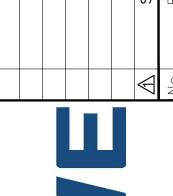





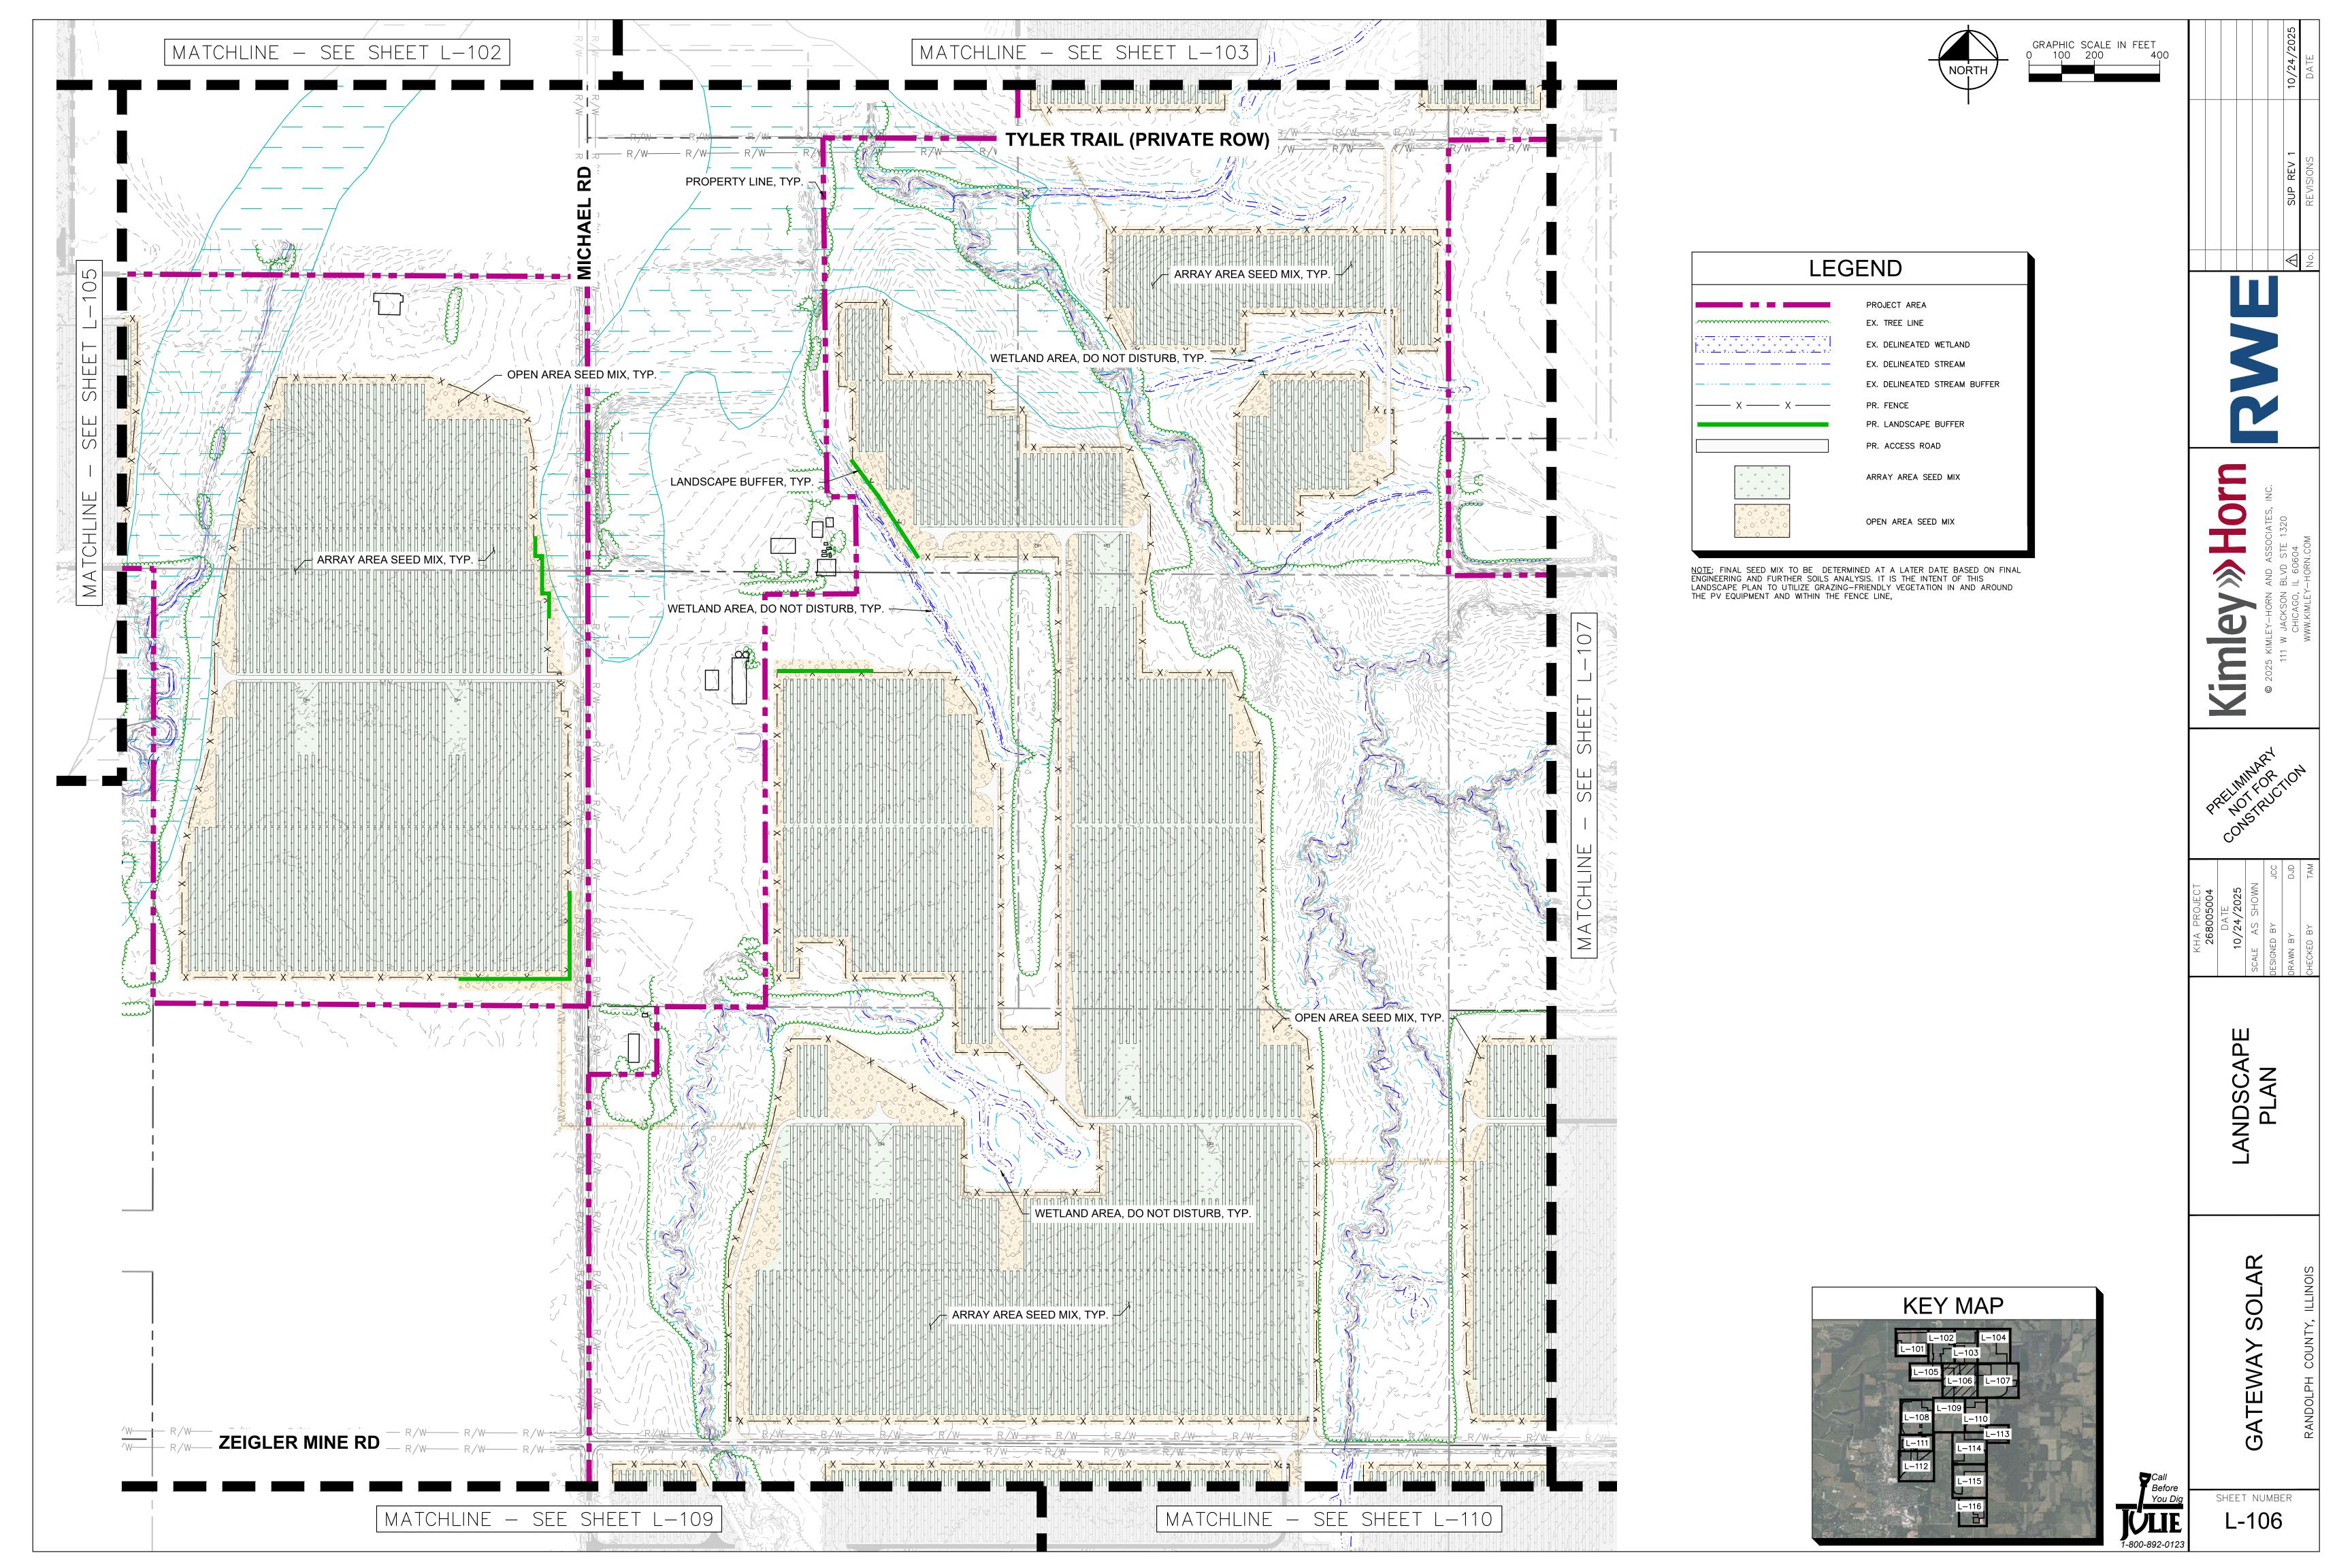

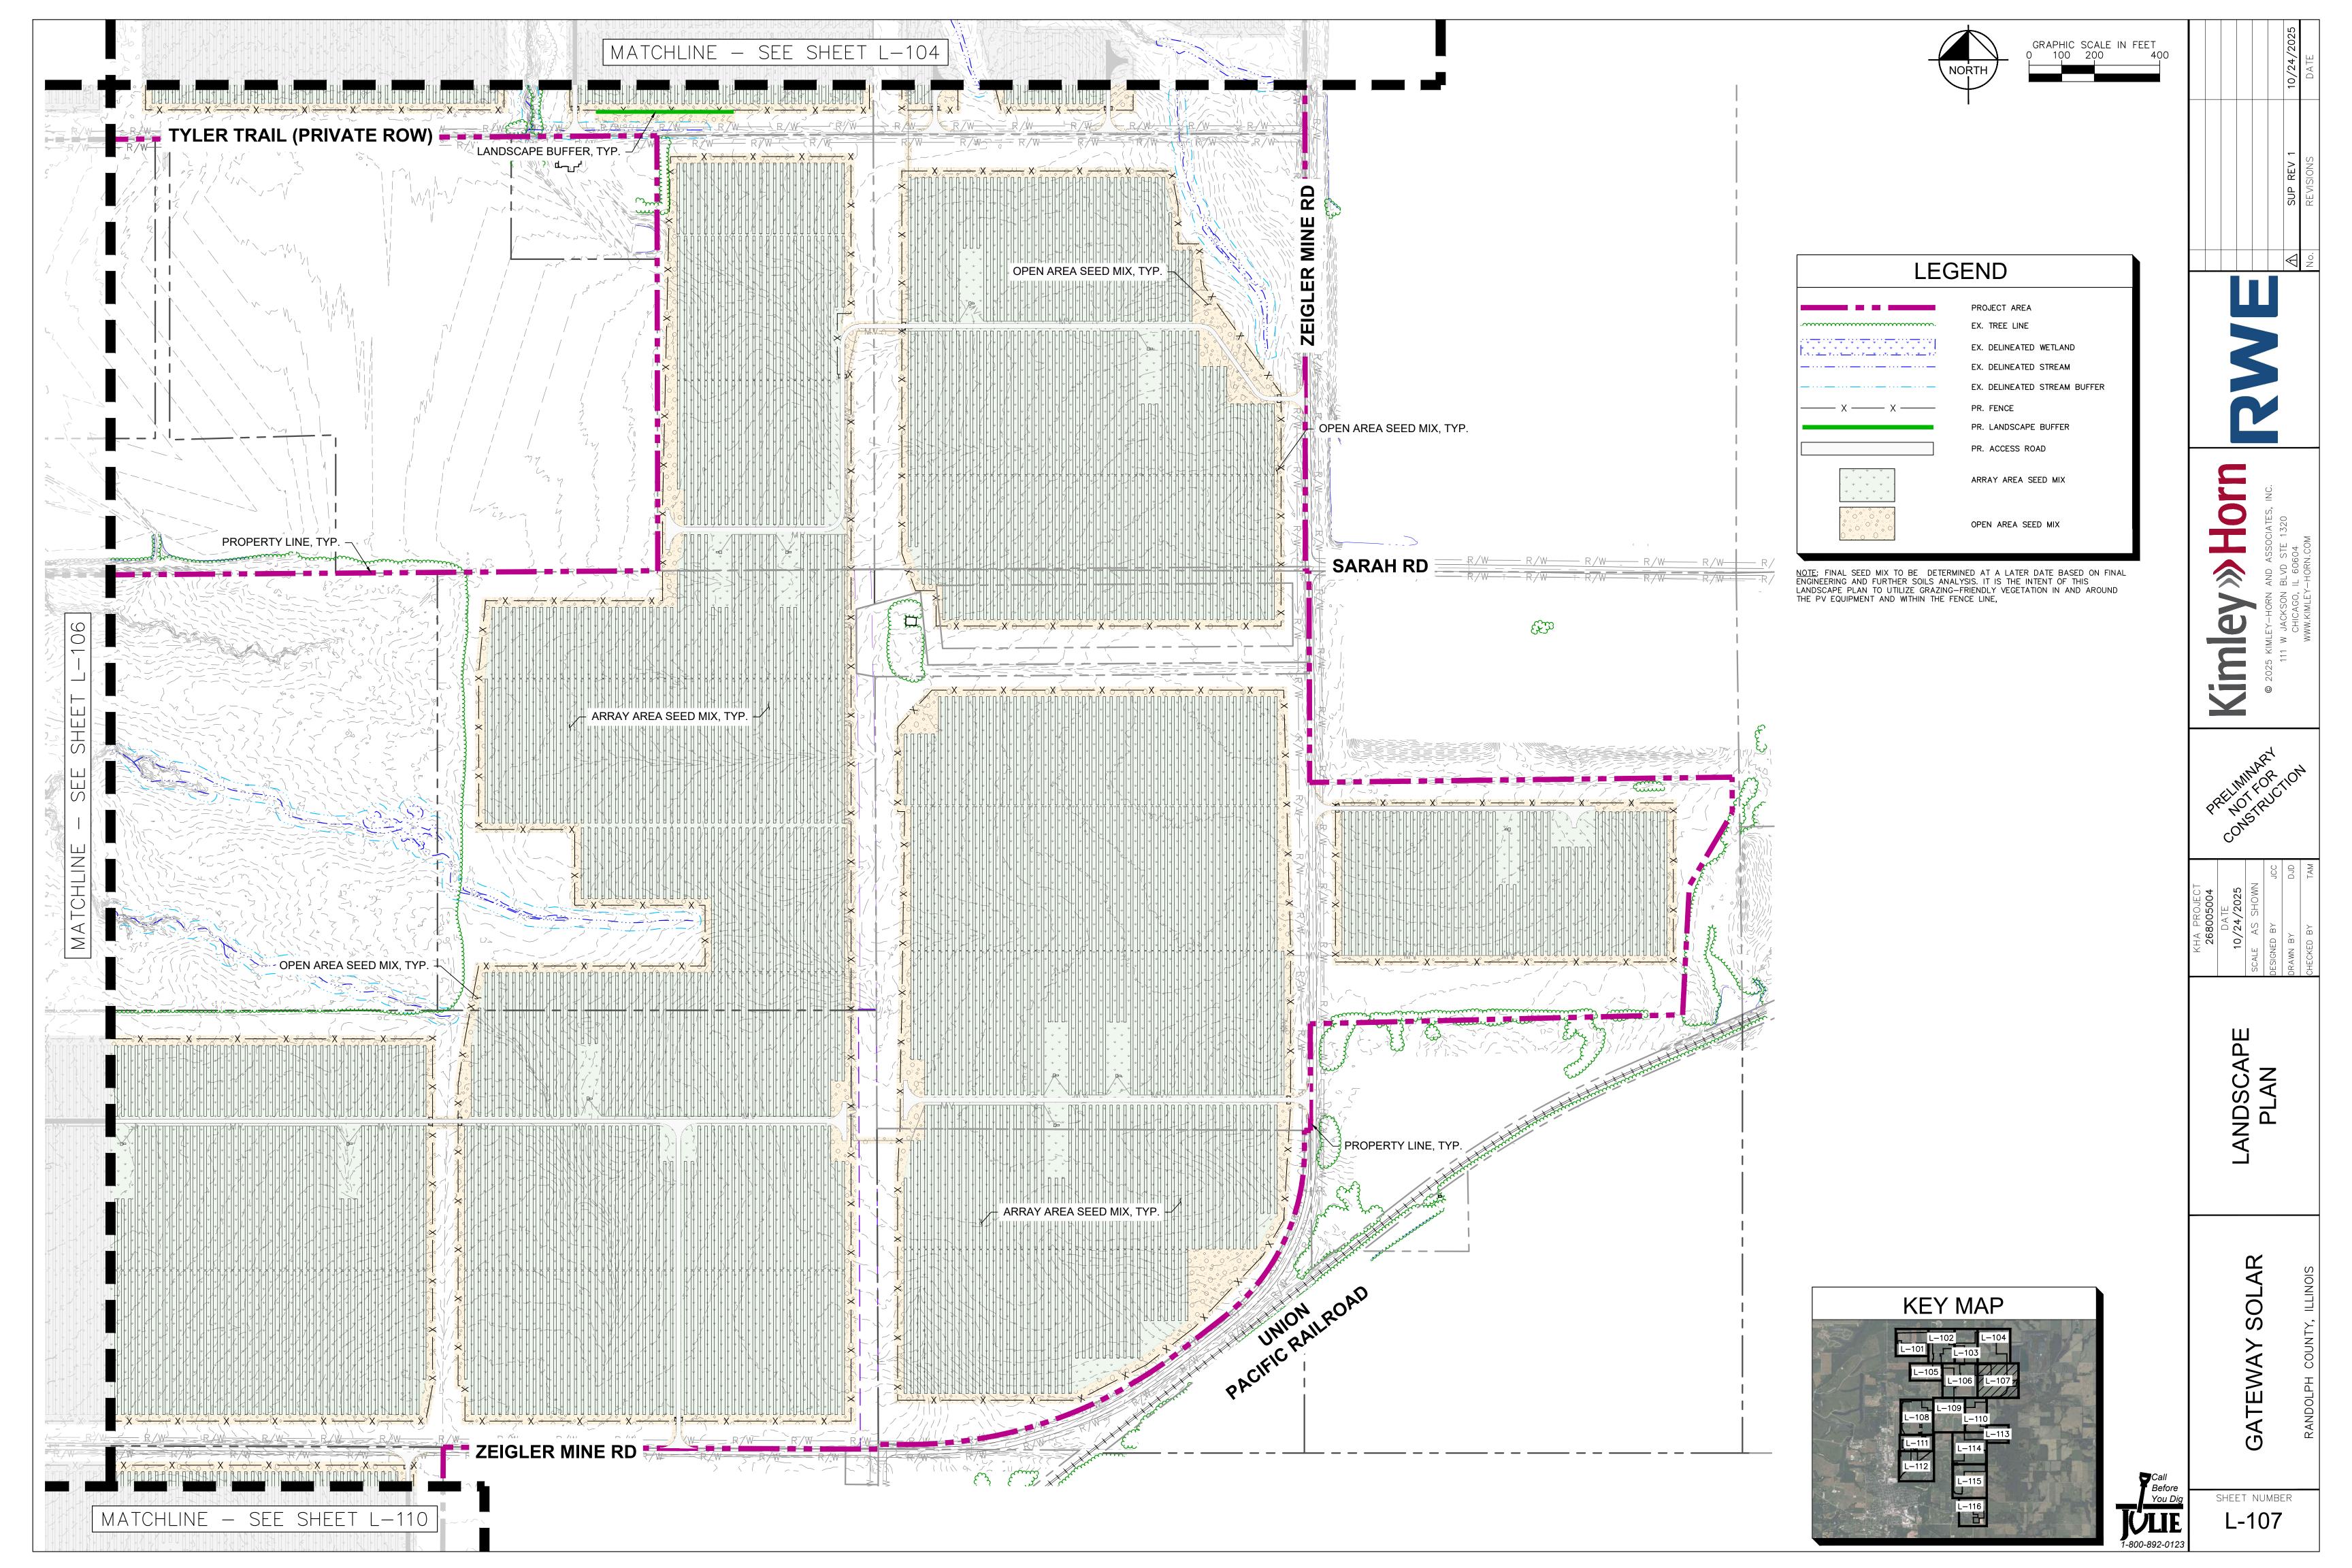

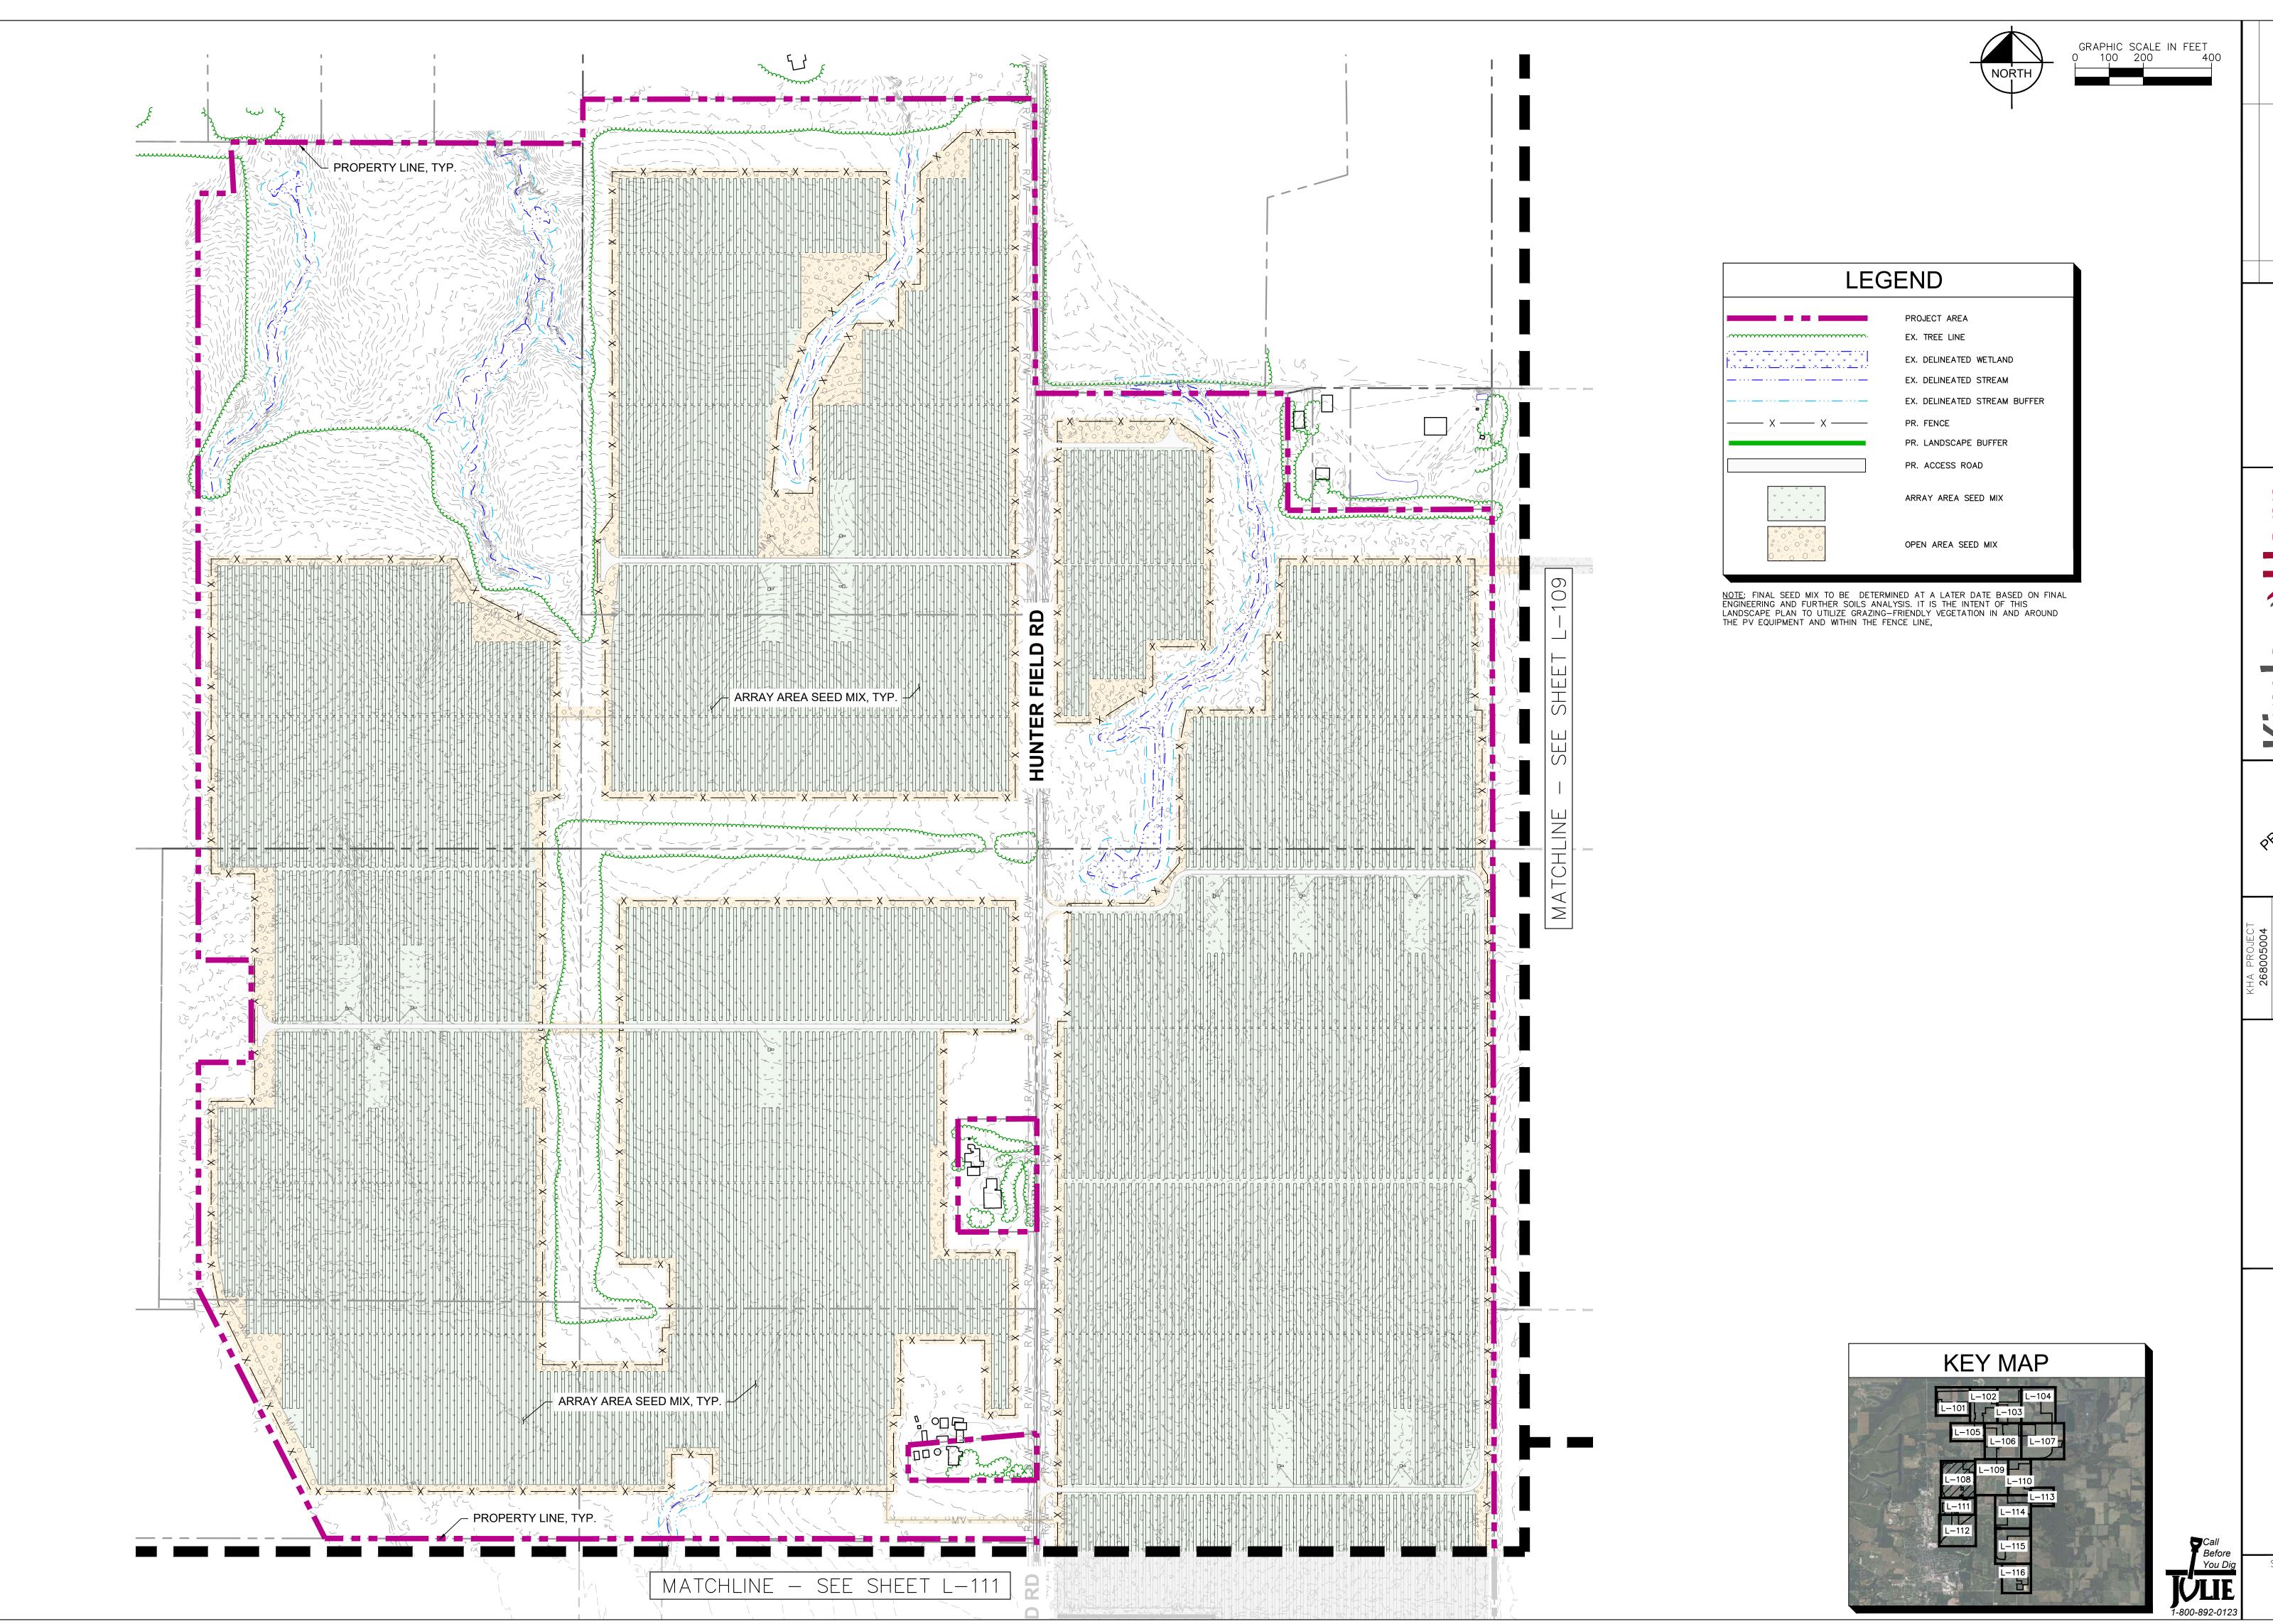

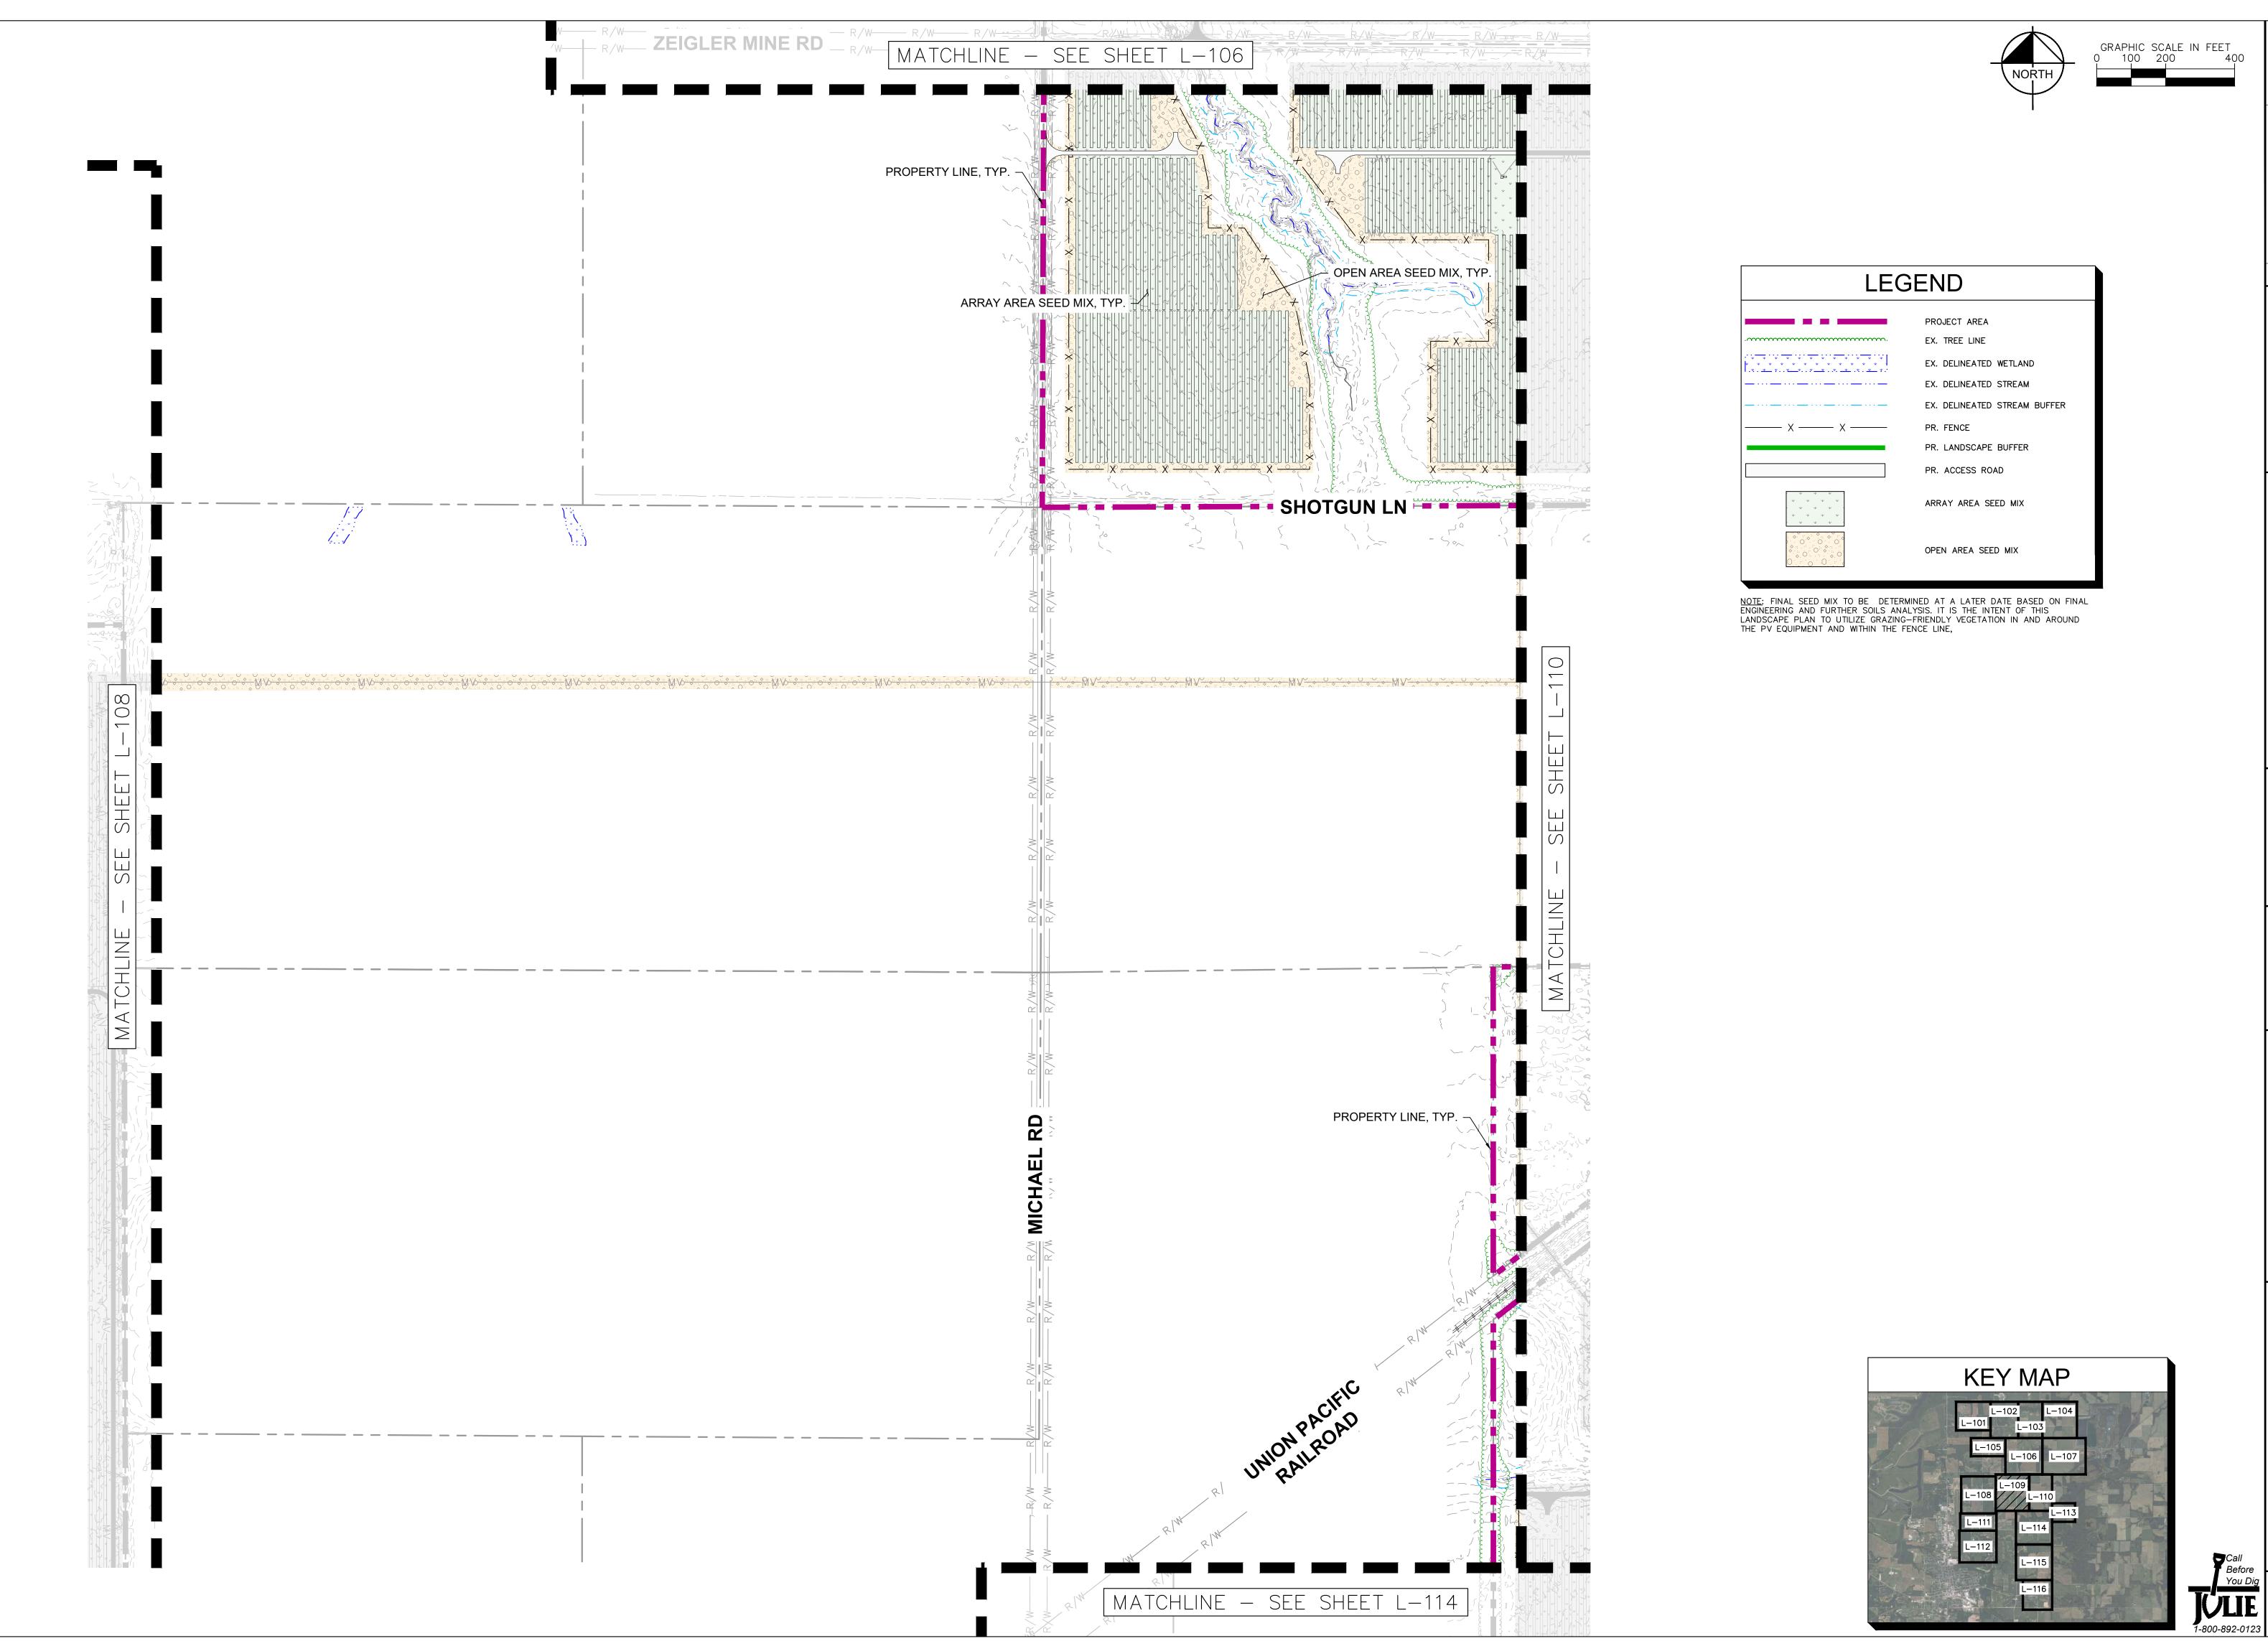

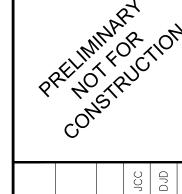


Kimle


SCALE AS SHOWN
DESIGNED BY JCC
DRAWN BY DJD

ANDSCAPE PLAN

TEWAY SOLAR

Call
Before
You Dig
SHEE

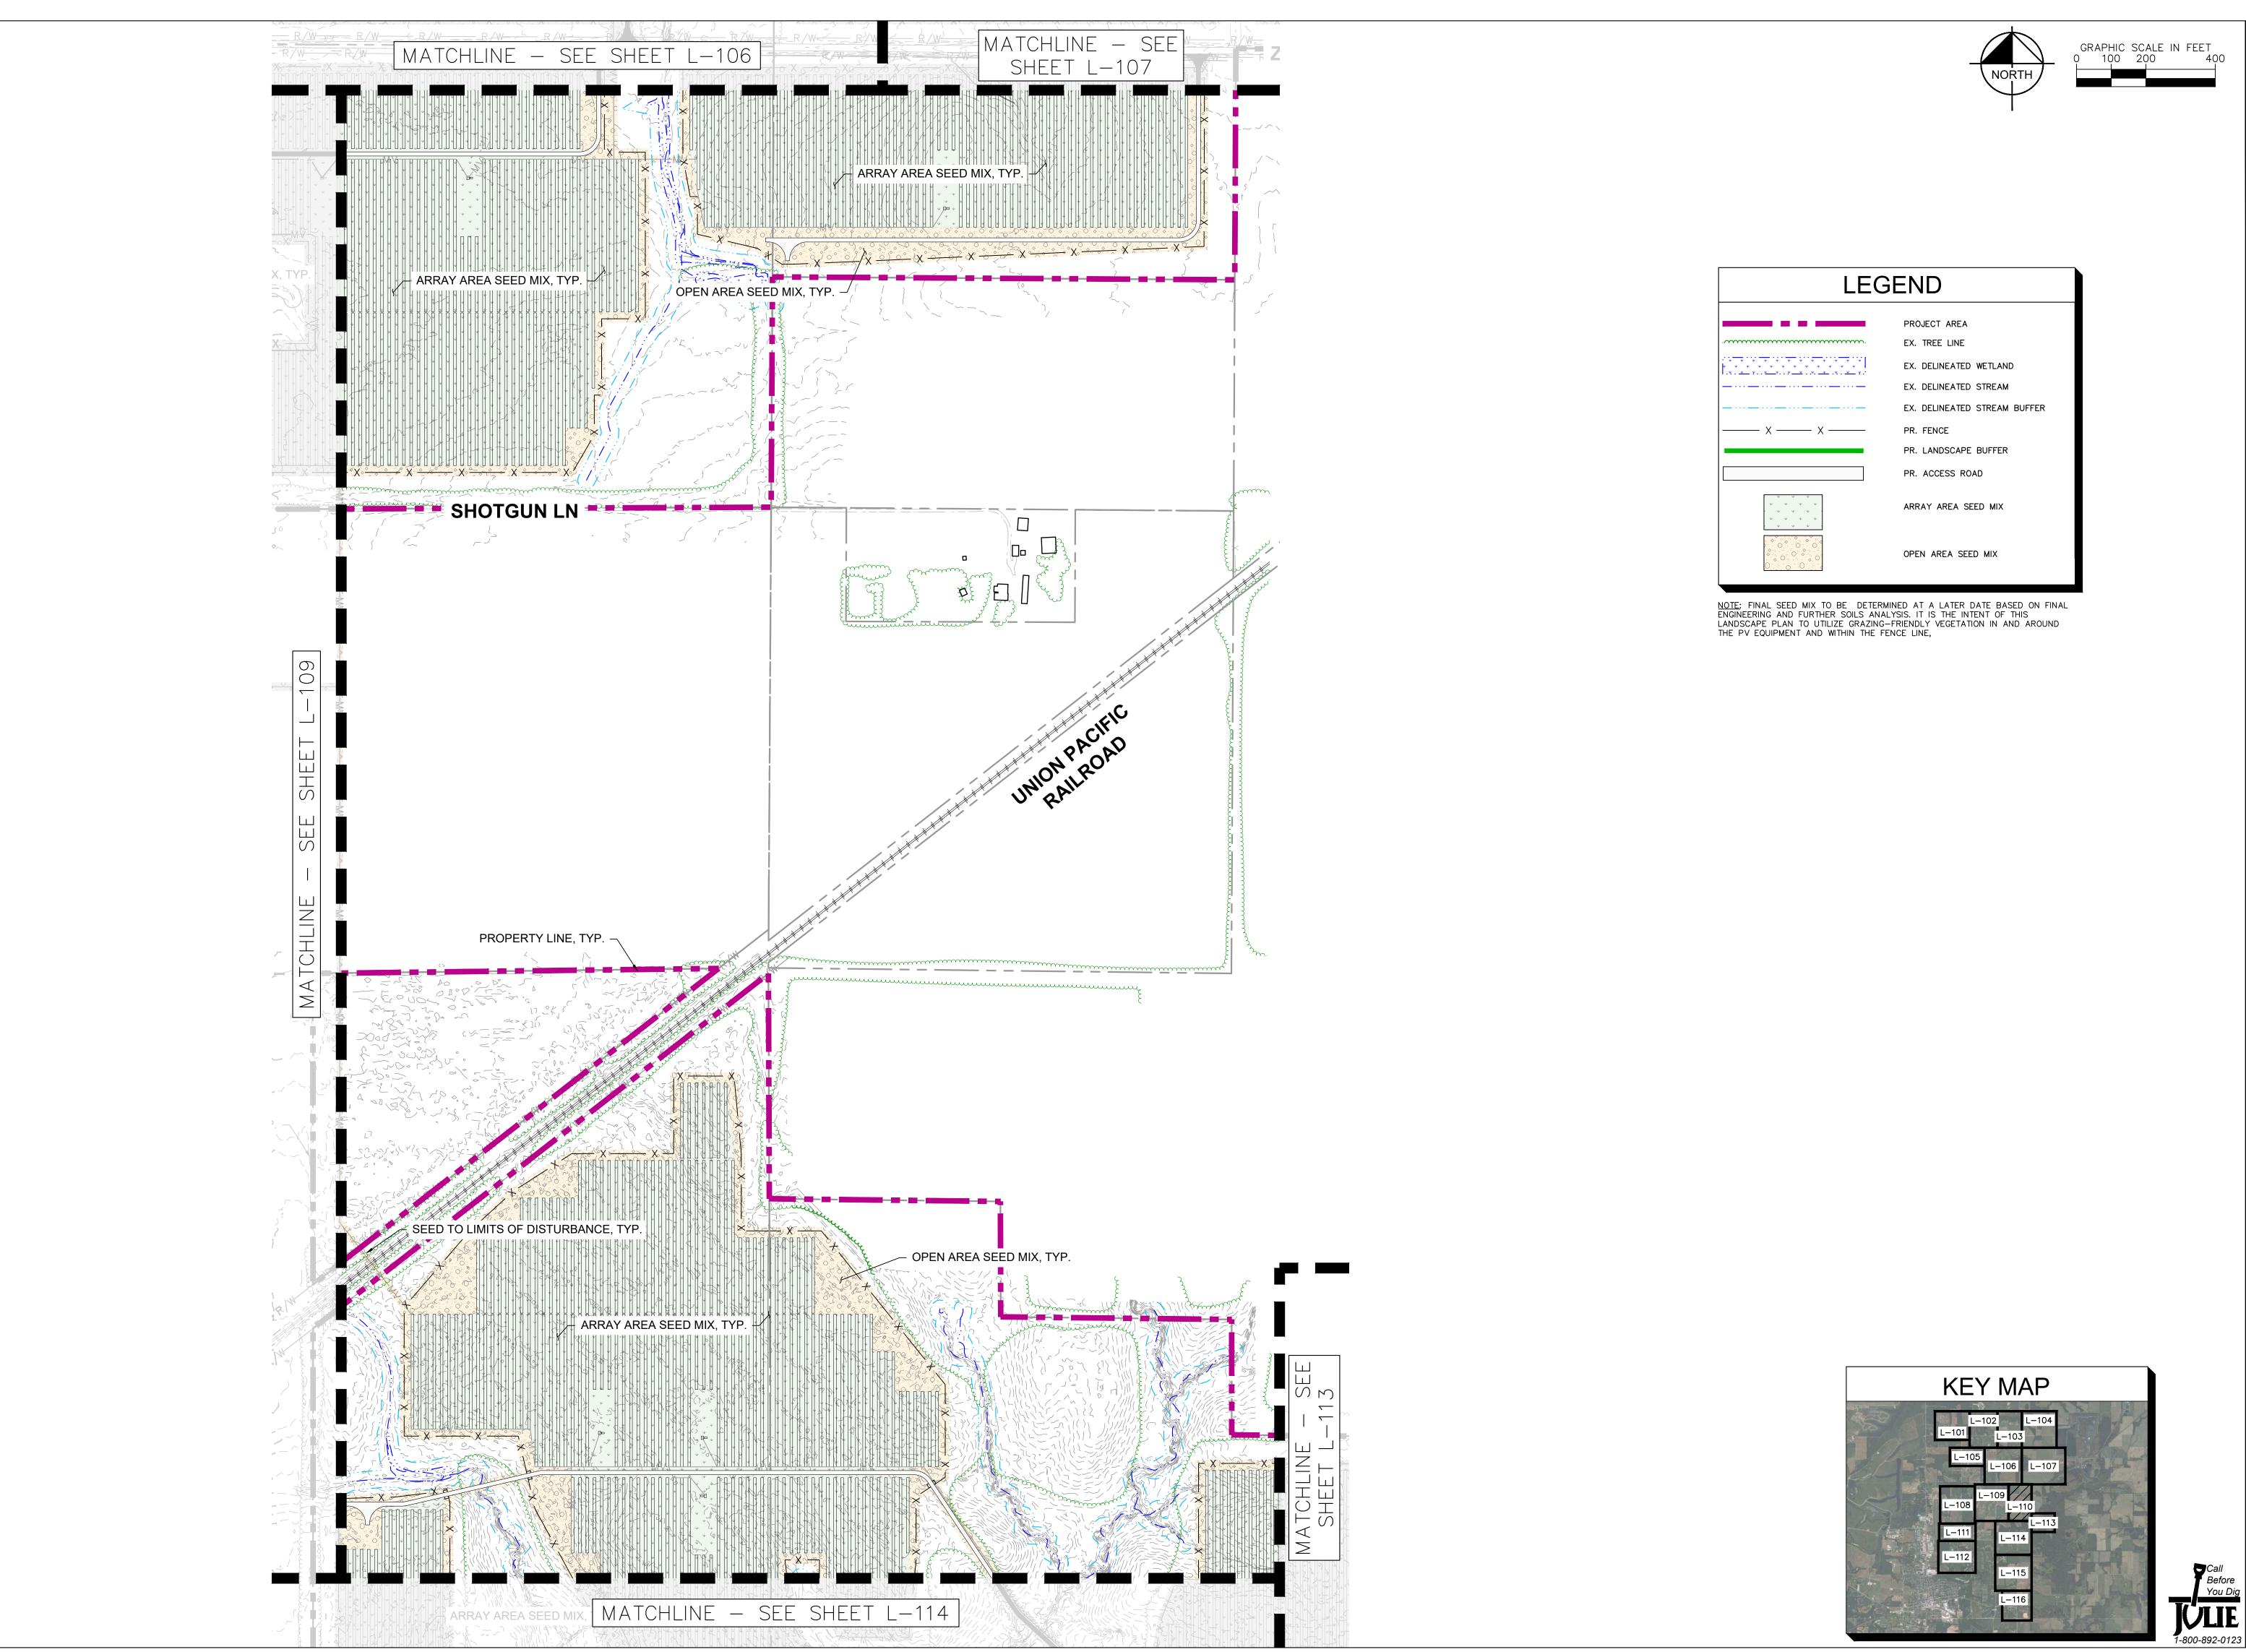

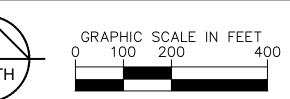

Kimle


ARRAY AREA SEED MIX OPEN AREA SEED MIX

Kimle


0

LANDSCAPE PLAN

SHEET NUMBER L-111

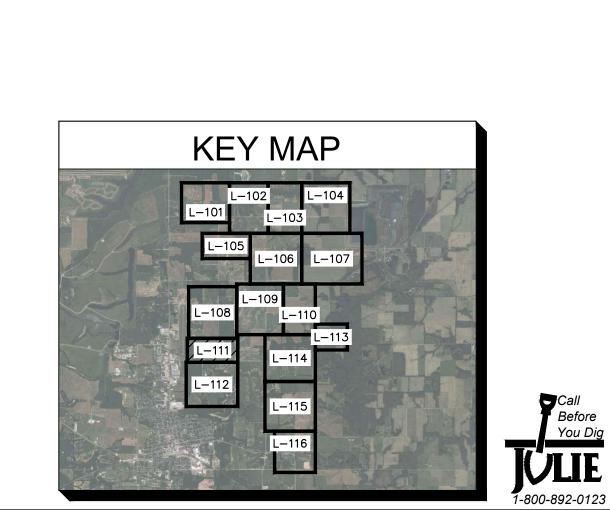




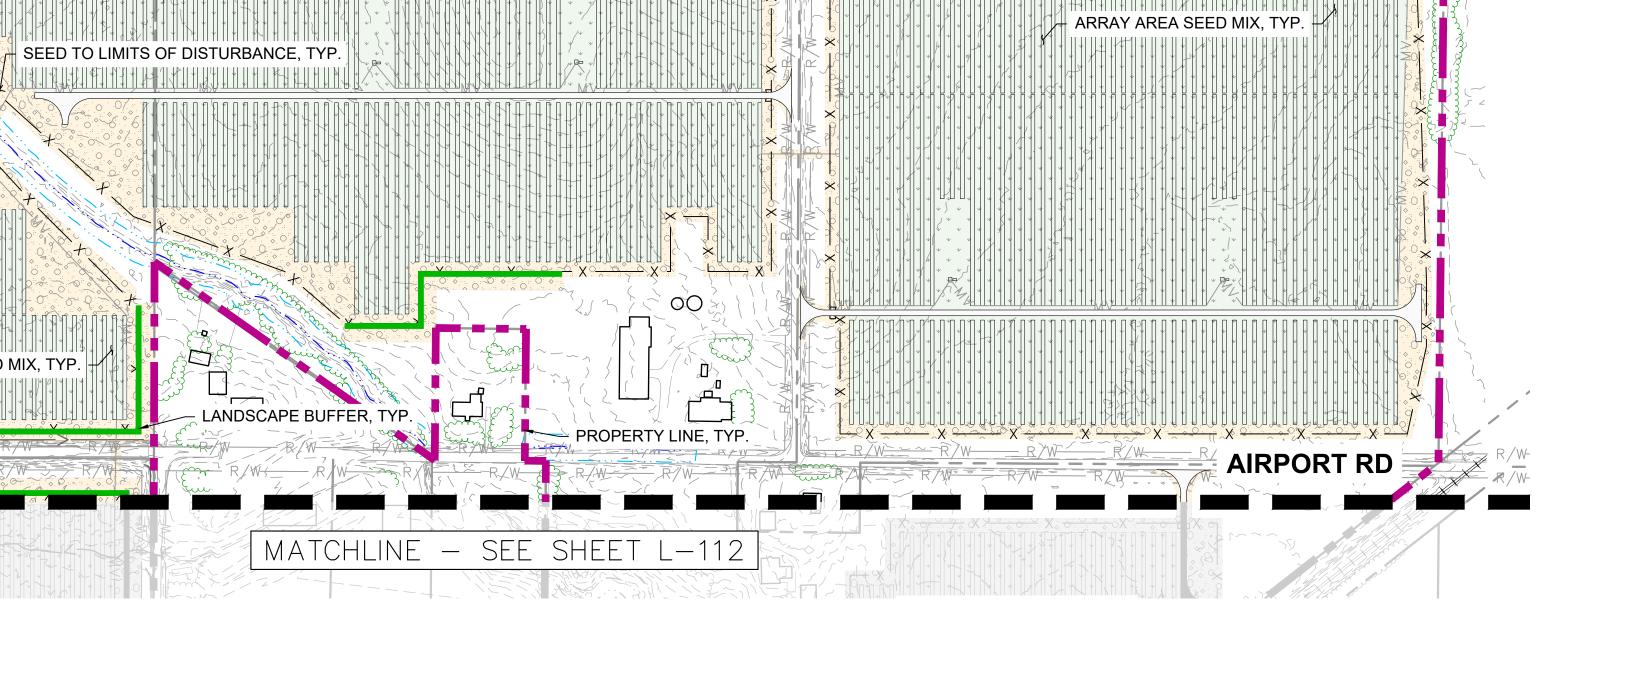

MATCHLINE - SEE SHEET L-108

- PROPERTY LINE, TYP.

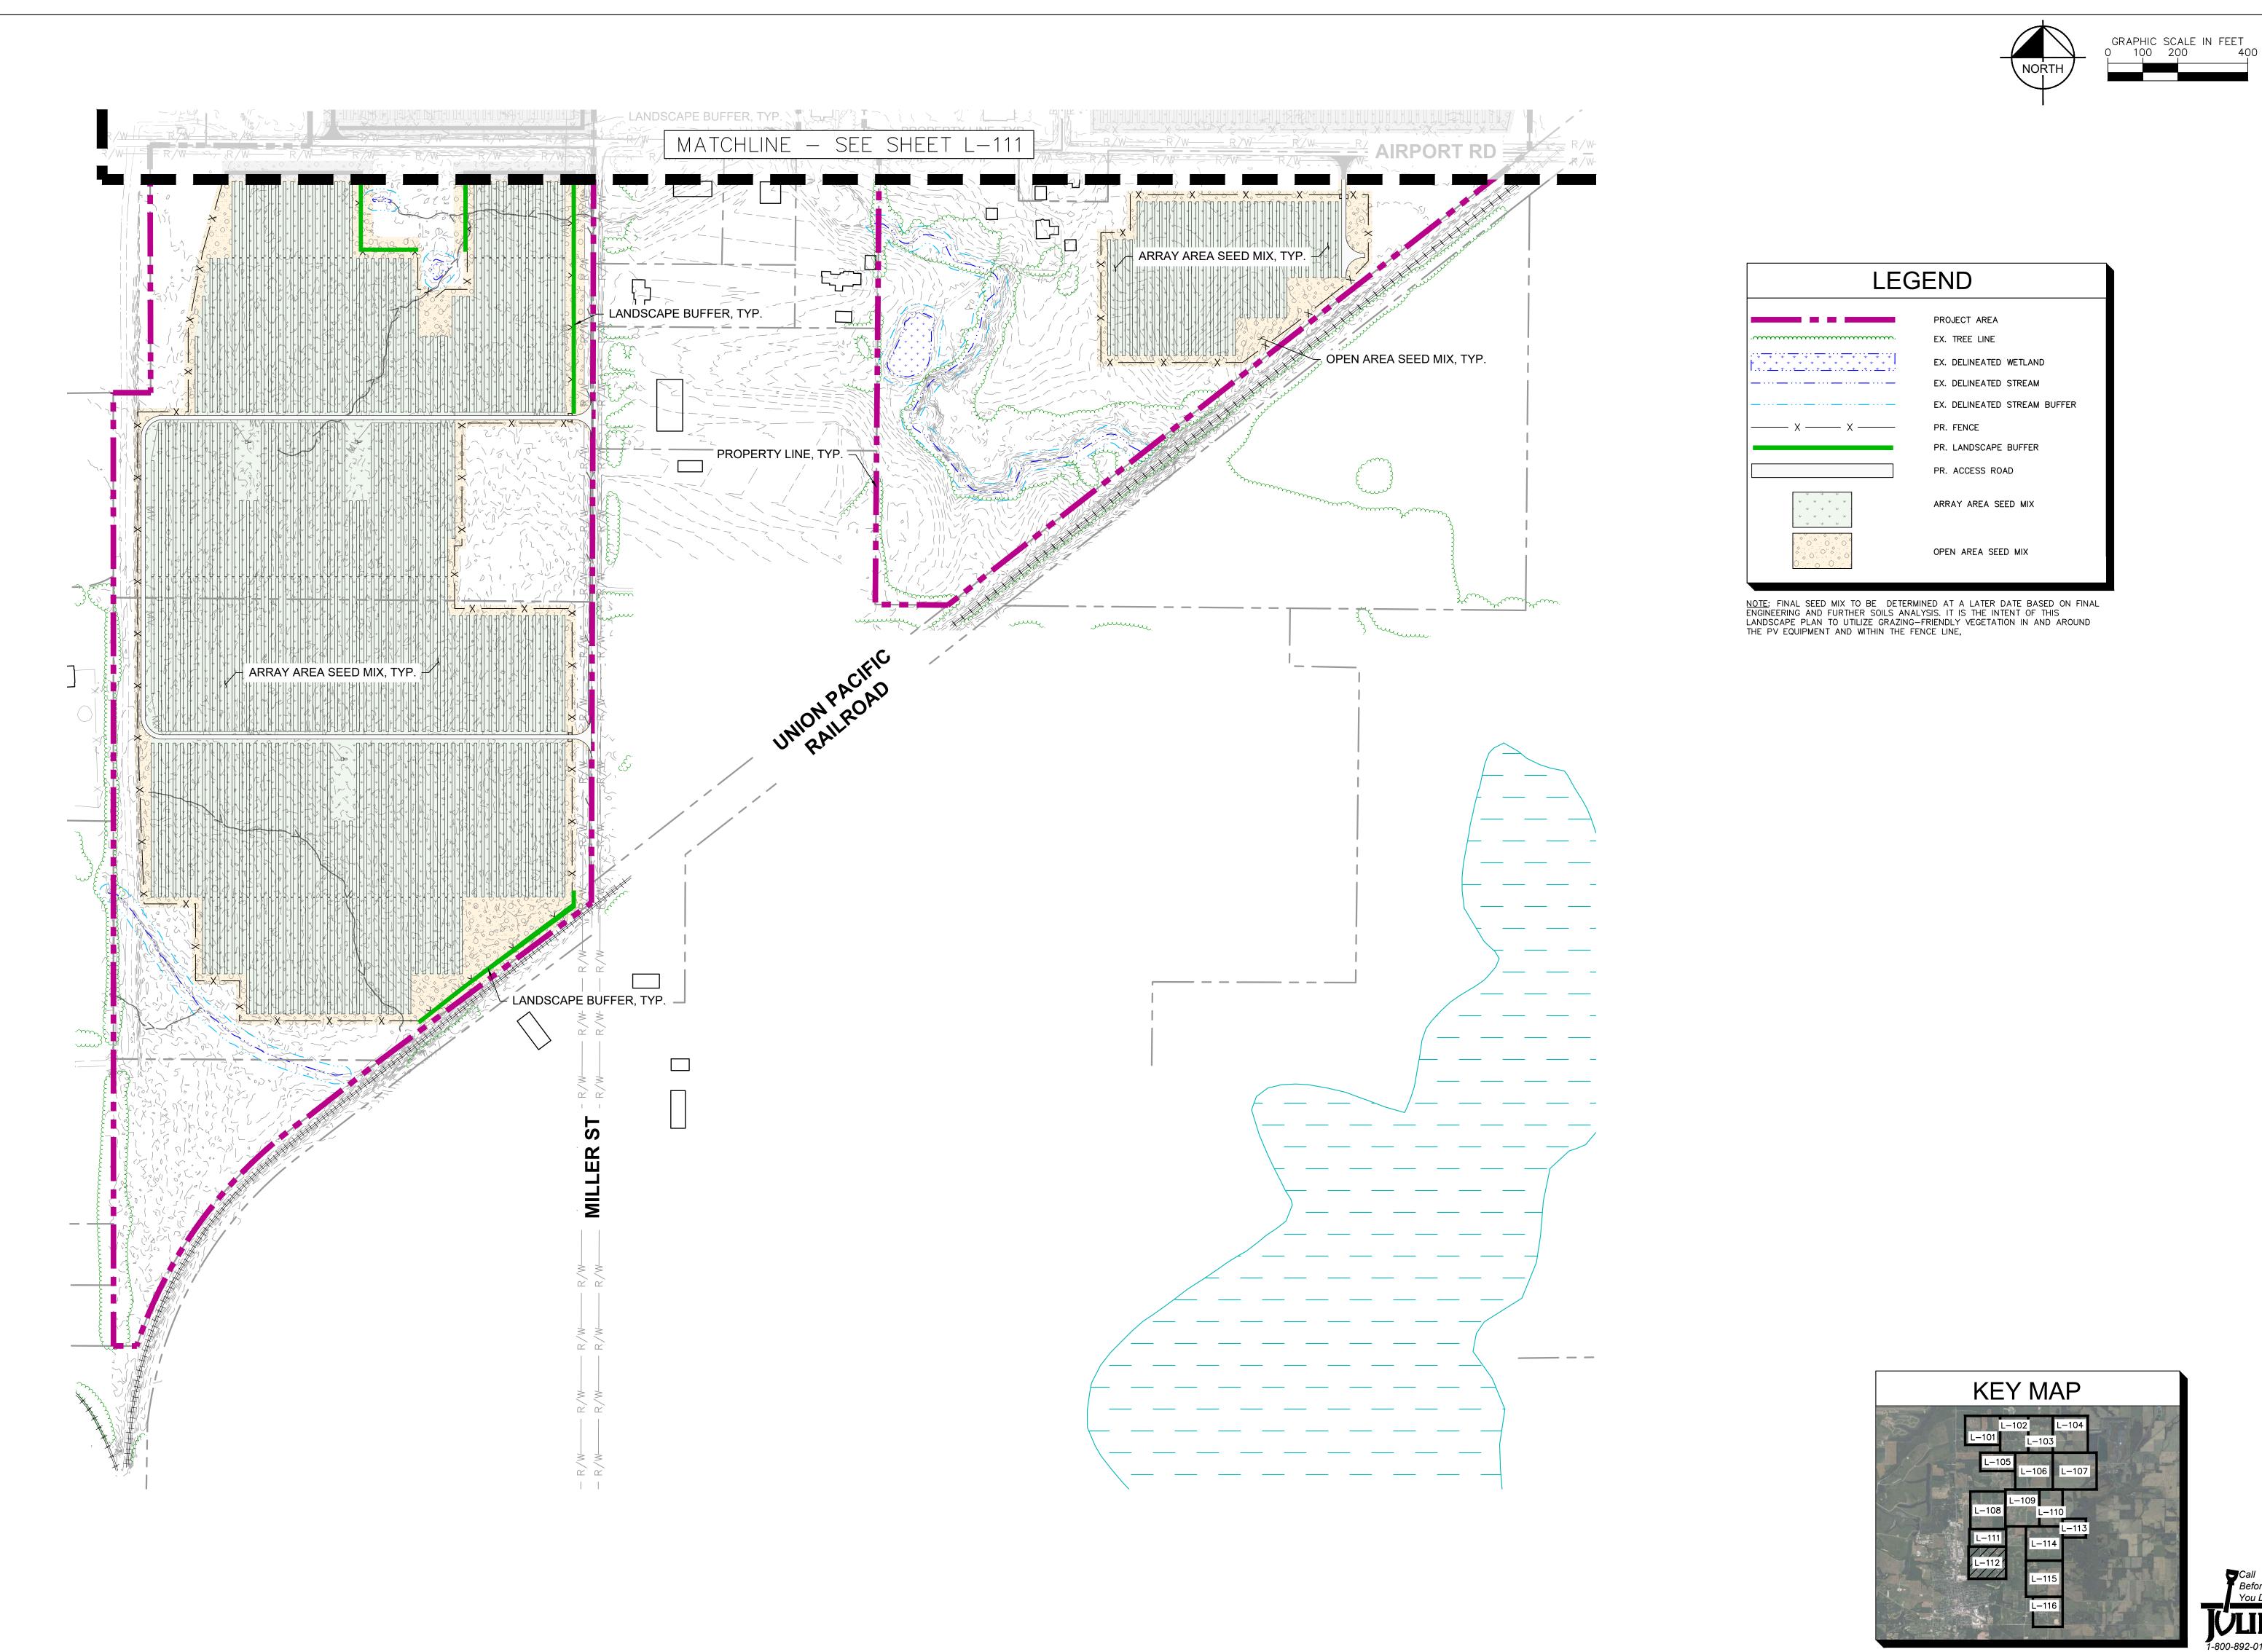

KEY MAP


Call Before You Dig

GATEWAY SOLAR SHEET NUMBER L-113


0


LANDSCAPE PLAN




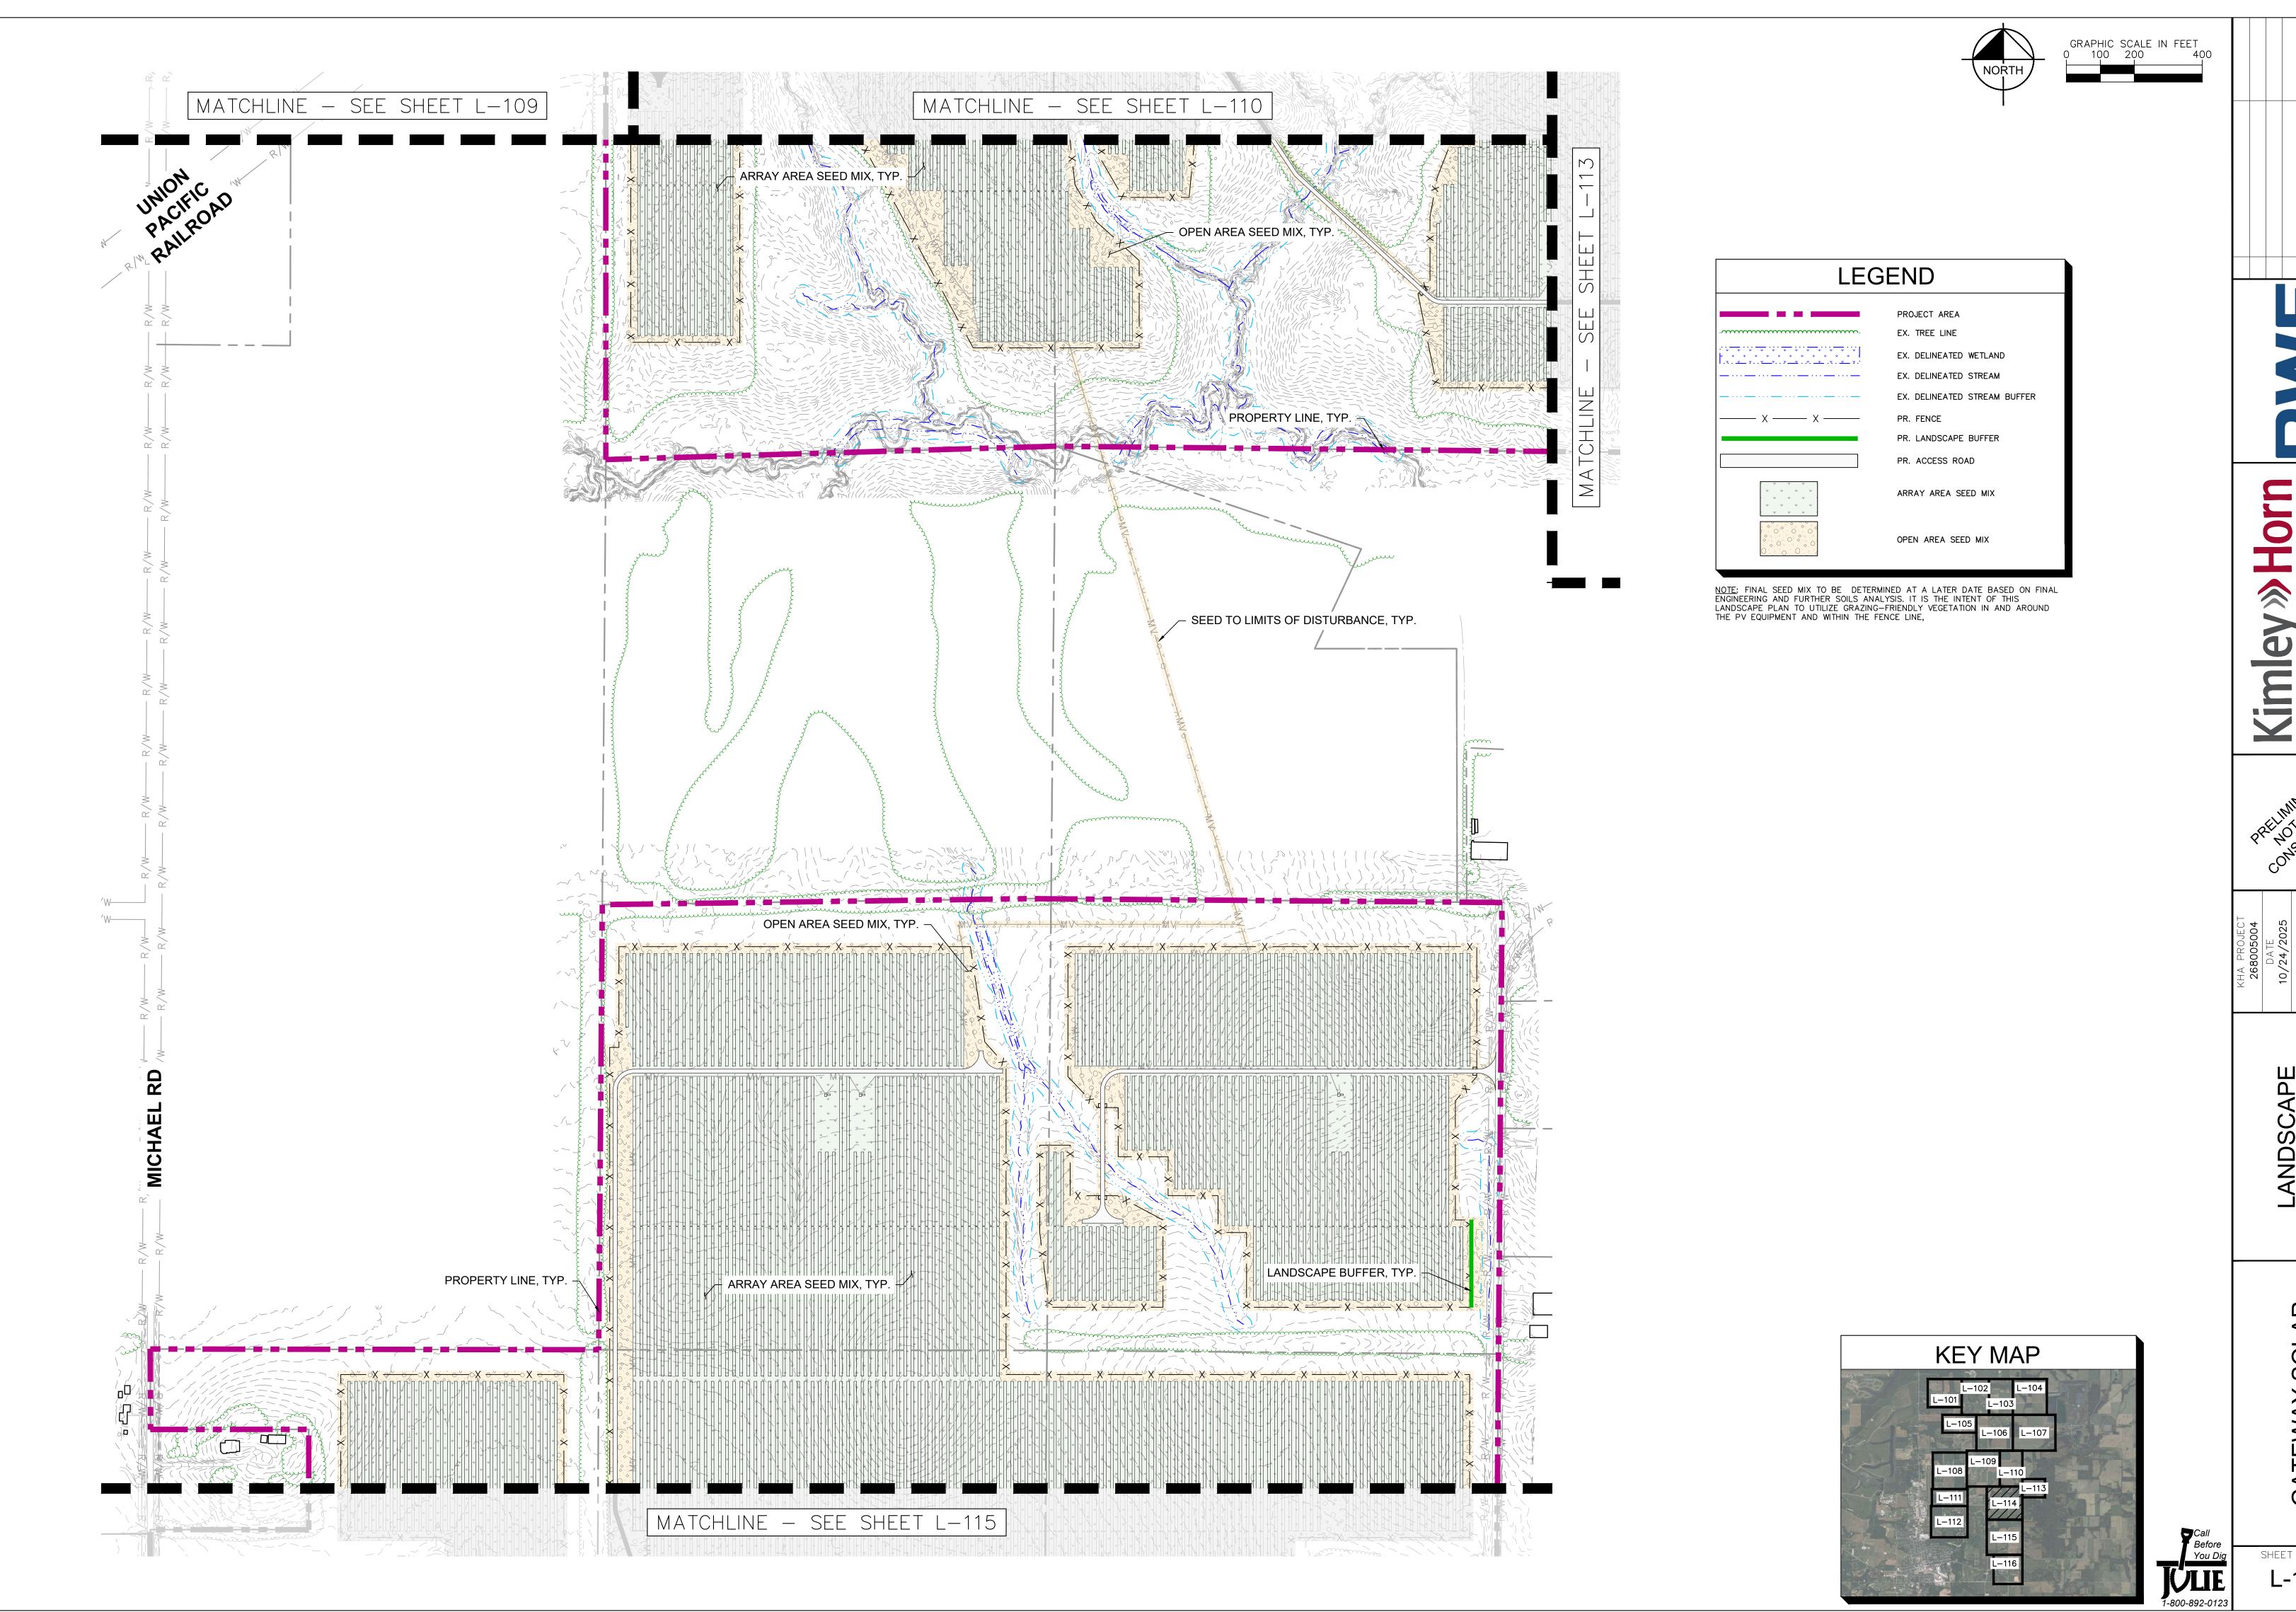





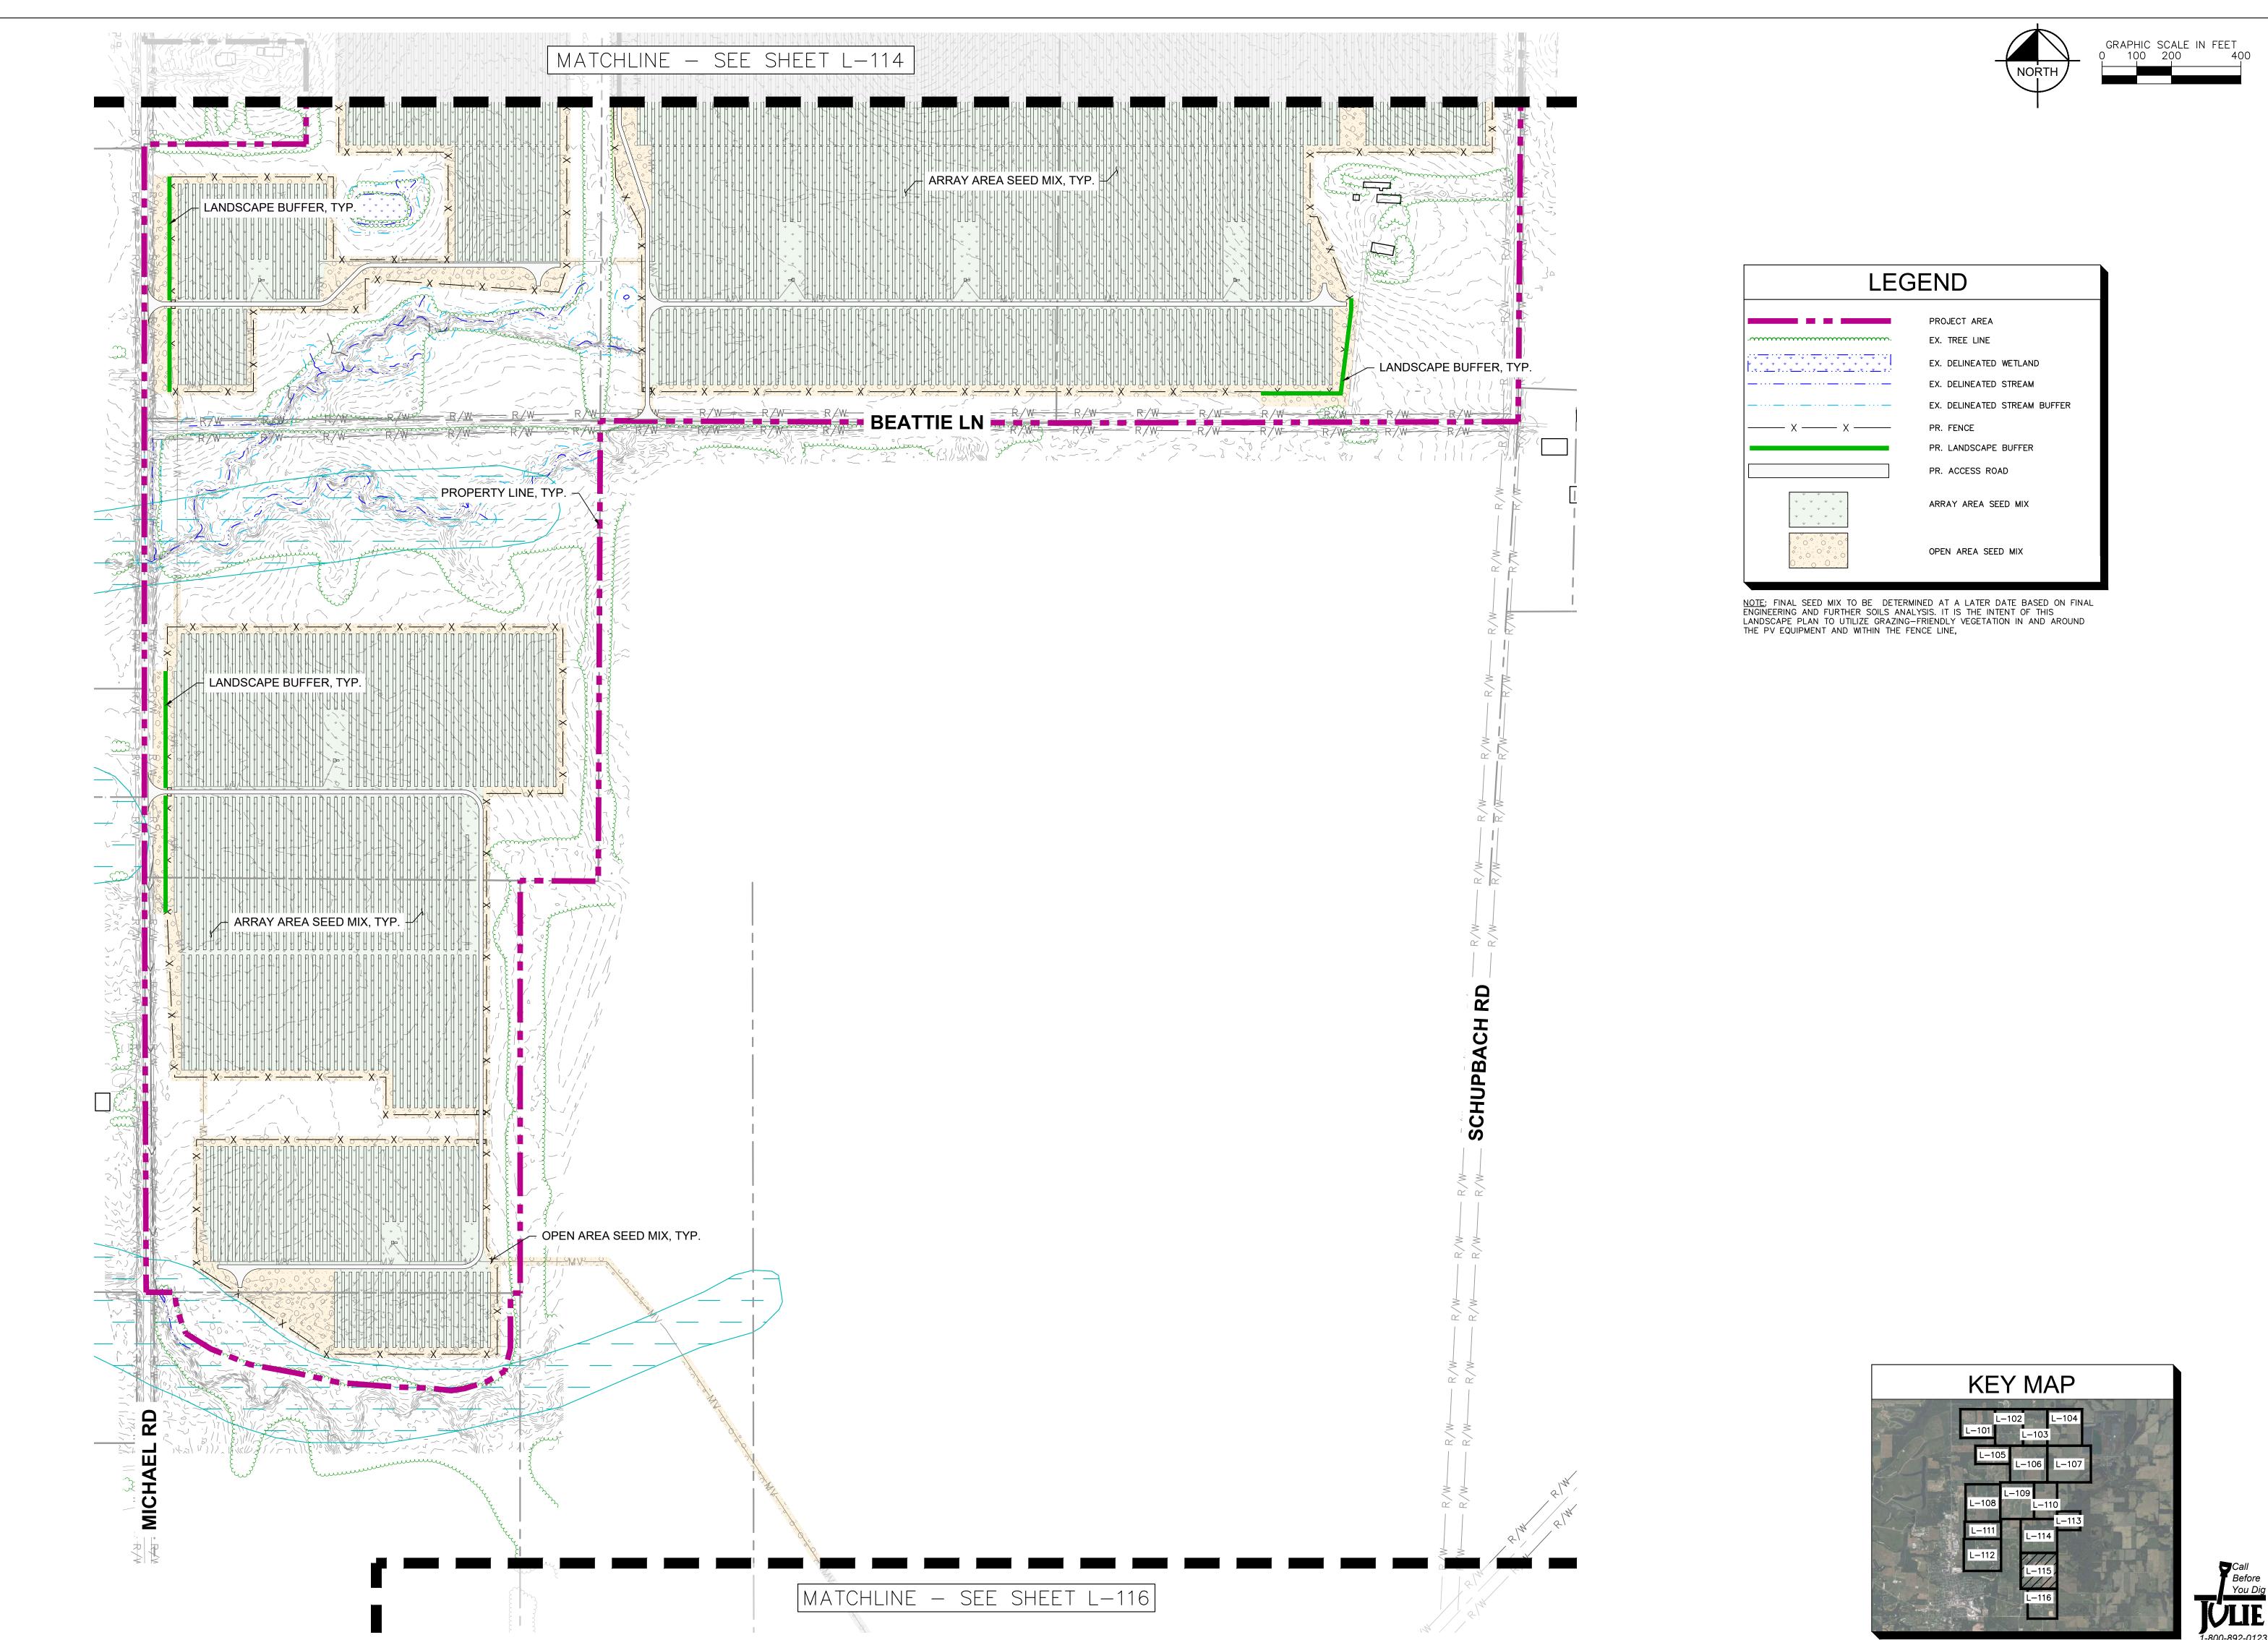


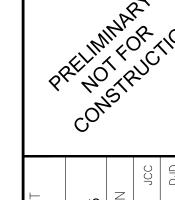

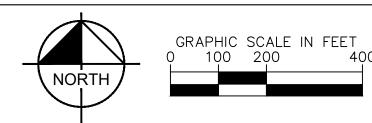

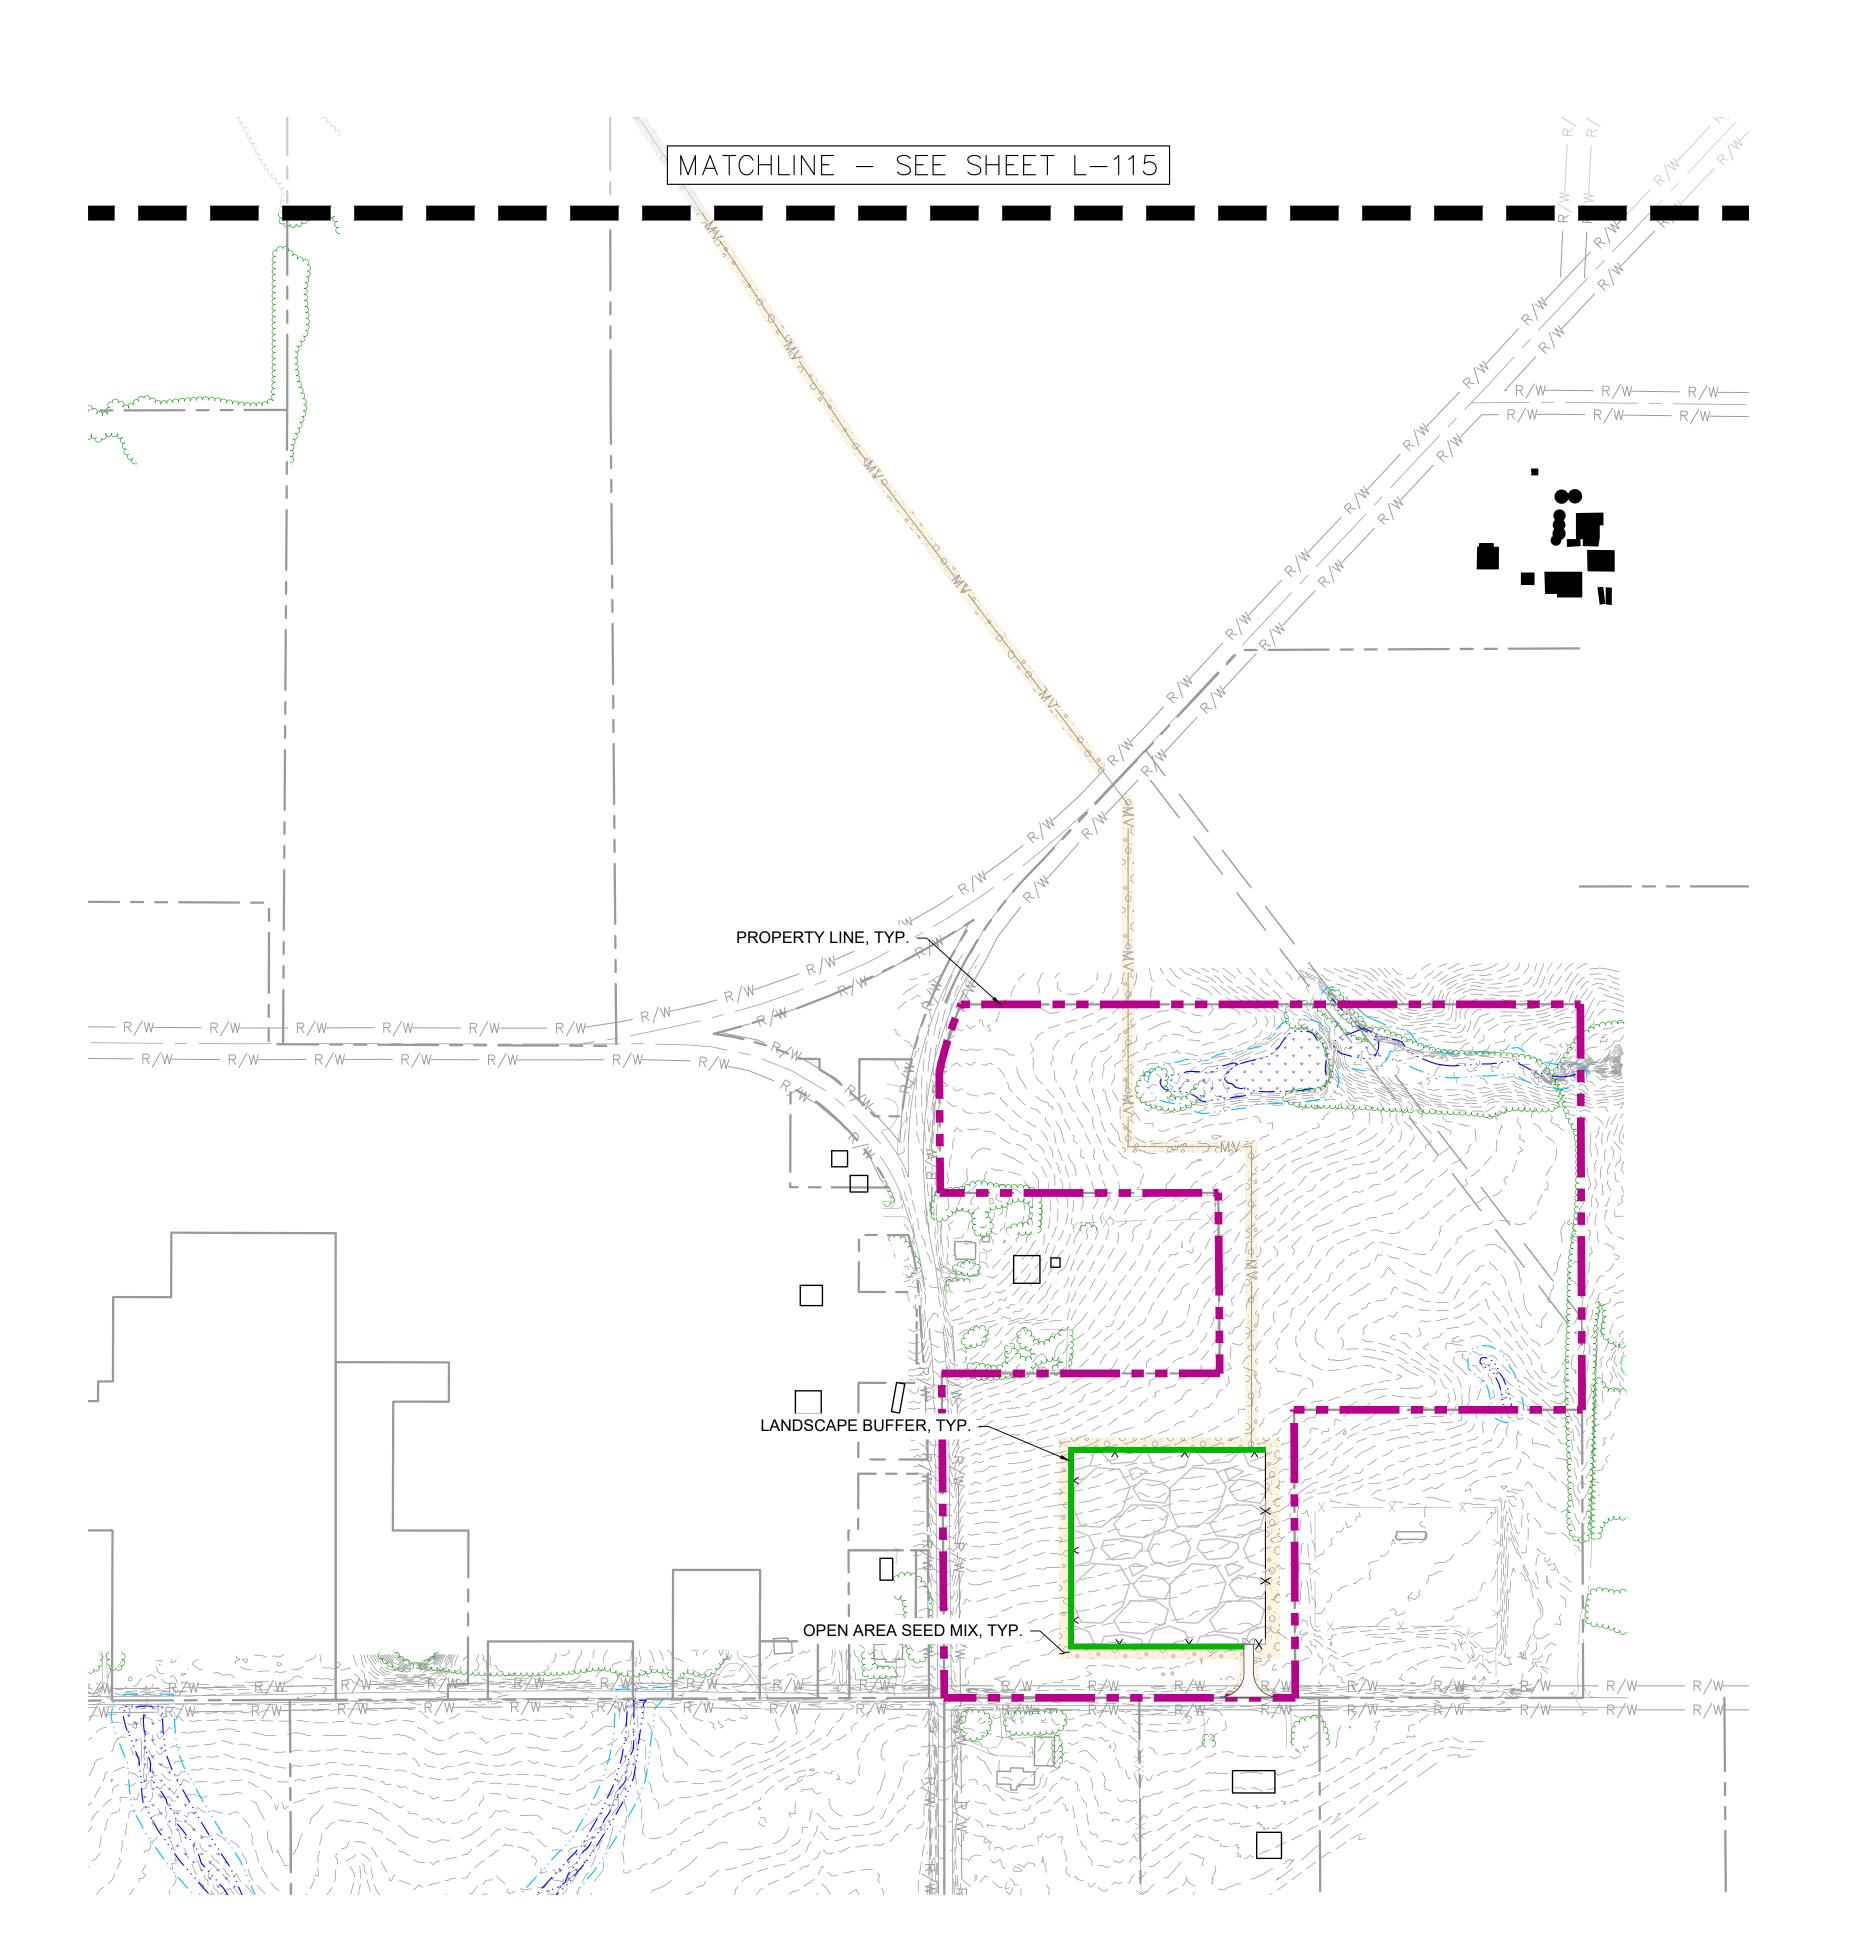

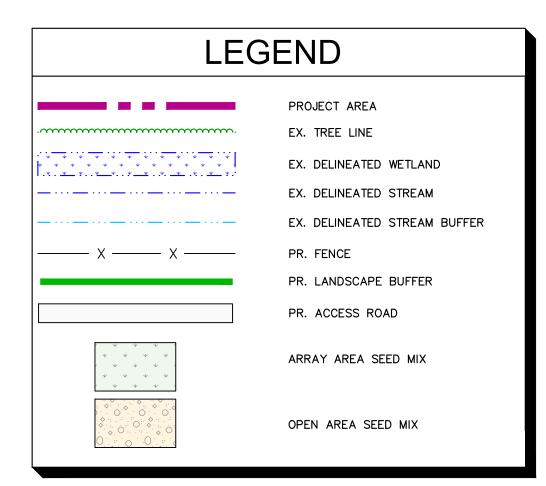

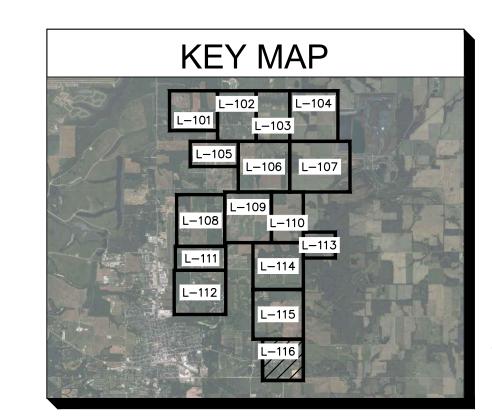



Kimle

0

_ANDSCAPE PLAN

GATEWAY SOLAR

GROUND COVER MAINTENANCE REQUIREMENTS

MAINTENANCE PROGRAMS SHALL BE SITE SPECIFIC AND COORDINATED WITH THE LANDSCAPE CONTRACTOR AND COUNTY FOR ADEQUATE MAINTENANCE PROCEDURES. A FIVE YEAR STEWARDSHIP PROGRAM IS NECESSARY TO ENSURE PROPER ESTABLISHMENT AND HEALTH OF GROUND COVER, TO CONTROL INVASIVE SPECIES, AND TO PREVENT OVERGROWTH AND SHADING OF EQUIPMENT. AFTER THE FIFTH GROWING SEASON, PROGRAM IS TO BE REDUCED TO TWO VISITS PER YEAR, DEPENDENT UPON SITE CONDITIONS AND REQUIRED STRATEGIES TO MAINTAIN GOOD HEALTH OF THE SITE SUCH AS DETHACHING, ADDITIONAL MOWING, OR HERBICIDE TREATMENTS.

FIRST YEAR

-EARLIEST POSSIBLE INSTALLATION MAY OCCUR IN THE SPRING OF THE FIRST YEAR. NO MAINTENANCE ACTIONS ARE REQUIRED TO BE PERFORMED DURING THE FIRST SEASON OF INSTALL. IF SEED APPLICATION TAKES PLACE IN SUMMER OR FALL OF THE FIRST YEAR, MAINTENANCE AND MONITORING SHOULD START THE FOLLOWING SEASON.

-SITE VISITS ARE TO BE PERFORMED THREE TIMES THROUGHOUT THE SUMMER AT THE MIDDLE OR END OF EACH MONTH, WITH MONITORING AND EVALUATION OF VEGETATION HEIGHT AND PRESENCE OF INVASIVE SPECIES OCCURRING AT EACH VISIT.

-CONTROL INVASIVE WOODY AND HERBACEOUS FLORA THROUGH PHYSICAL REMOVAL OR SPOT *HERBICIDE TREATMENTS. -CONDUCT MOWING UP TO THREE TIMES MAXIMUM DURING THE SUMMER IN AREAS OF THE SITE IDENTIFIED TO HAVE VEGETATION OVER 16 INCHES IN HEIGHT. AREAS WITH HEIGHT UNDER 16 INCHES MAY REMAIN UNTIL THE NEXT SCHEDULED MONITORING VISIT. NEWLY SEEDED AREAS SHOULD BE CUT BACK TO 10 INCHES IN HEIGHT.

-SITE VISITS ARE TO BE PERFORMED THREE TIMES THROUGHOUT THE FALL AT THE MIDDLE OR END OF EACH MONTH, WITH MONITORING AND EVALUATION OF VEGETATION HEIGHT AND PRESENCE OF INVASIVE SPECIES OCCURRING AT EACH VISIT. -CONTROL INVASIVE WOODY AND HERBACEOUS FLORA THROUGH PHYSICAL REMOVAL OR SPOT *HERBICIDE TREATMENTS. -CONDUCT MOWING UP TO THREE TIMES MAXIMUM DURING THE FALL IN AREAS OF THE SITE IDENTIFIED TO HAVE VEGETATION OVER 16 INCHES IN HEIGHT. AREAS WITH HEIGHT UNDER 16 INCHES MAY REMAIN UNTIL THE NEXT SCHEDULED MONITORING VISIT. NEWLY SEEDED AREAS SHOULD BE CUT BACK TO 10 INCHES IN HEIGHT.

SECOND YEAR

-SITE VISITS ARE TO BE PERFORMED THREE TIMES THROUGHOUT THE SPRING AT THE MIDDLE OR END OF EACH MONTH, WITH MONITORING AND EVALUATION OF VEGETATION HEIGHT AND PRESENCE OF INVASIVE SPECIES OCCURRING AT EACH

-DURING FIRST VISIT, MOWING SHOULD OCCUR TO CUT BACK ANY VEGETATION TO A HEIGHT OF 10 INCHES AND REMOVE DEAD STALKS AND SEED HEADS FROM THE PREVIOUS GROWING SEASON.

-CONTROL INVASIVE WOODY AND HERBACEOUS FLORA THROUGH PHYSICAL REMOVAL OR SPOT *HERBICIDE TREATMENTS. -CONDUCT MOWING UP TO THREE TIMES MAXIMUM DURING THE SPRING IN AREAS OF THE SITE IDENTIFIED TO HAVE VEGETATION OVER 16 INCHES IN HEIGHT. AREAS WITH HEIGHT UNDER 16 INCHES MAY REMAIN UNTIL THE NEXT SCHEDULED MONITORING VISIT. SEEDED AREAS SHOULD BE CUT BACK TO 12 INCHES IN HEIGHT.

-PLANT SUPPLEMENTAL SEED AS NEEDED TO ADDRESS AREAS OF POOR COVERAGE AND TO INCREASE COMPETITION AND **BIO-DIVERSITY.**

-SITE VISITS ARE TO BE PERFORMED THREE TIMES THROUGHOUT THE SUMMER AT THE MIDDLE OR END OF EACH MONTH. WITH MONITORING AND EVALUATION OF VEGETATION HEIGHT AND PRESENCE OF INVASIVE SPECIES OCCURRING AT EACH

-CONTROL INVASIVE WOODY AND HERBACEOUS FLORA THROUGH PHYSICAL REMOVAL OR SPOT *HERBICIDE TREATMENTS. -CONDUCT MOWING UP TO THREE TIMES MAXIMUM DURING THE SUMMER IN AREAS OF THE SITE IDENTIFIED TO HAVE VEGETATION OVER 16 INCHES IN HEIGHT. AREAS WITH HEIGHT UNDER 16 INCHES MAY REMAIN UNTIL THE NEXT SCHEDULED MONITORING VISIT. SEEDED AREAS SHOULD BE CUT BACK TO 12 INCHES IN HEIGHT.

FALL:

-SITE VISITS ARE TO BE PERFORMED THREE TIMES THROUGHOUT THE FALL AT THE MIDDLE OR END OF EACH MONTH, WITH MONITORING AND EVALUATION OF VEGETATION HEIGHT AND PRESENCE OF INVASIVE SPECIES OCCURRING AT EACH VISIT. -CONTROL INVASIVE WOODY AND HERBACEOUS FLORA THROUGH PHYSICAL REMOVAL OR SPOT *HERBICIDE TREATMENTS. -CONDUCT MOWING UP TO THREE TIMES MAXIMUM DURING THE FALL IN AREAS OF THE SITE IDENTIFIED TO HAVE VEGETATION OVER 16 INCHES IN HEIGHT. AREAS WITH HEIGHT UNDER 16 INCHES MAY REMAIN UNTIL THE NEXT SCHEDULED MONITORING VISIT. SEEDED AREAS SHOULD BE CUT BACK TO 12 INCHES IN HEIGHT.

THIRD, FOURTH, AND FIFTH YEAR

-SITE VISIT IS TO BE PERFORMED ONE TIME DURING THE EARLY SPRING. WITH MONITORING AND EVALUATION OF VEGETATION HEIGHT AND PRESENCE OF INVASIVE SPECIES OCCURRING.

-MOWING SHOULD OCCUR TO CUT BACK ANY VEGETATION TO A HEIGHT OF 10 INCHES AND REMOVE DEAD STALKS AND SEED HEADS FROM THE PREVIOUS GROWING SEASON.

-IF INVASIVE WOODY AND HERBACEOUS FLORA HAVE BEEN IDENTIFIED, PHYSICAL REMOVAL OR SPOT *HERBICIDE TREATMENTS ARE REQUIRED.

SUMMER:

-SITE VISIT IS TO BE PERFORMED ONE TIME DURING THE SUMMER, WITH MONITORING AND EVALUATION OF VEGETATION HEIGHT AND PRESENCE OF INVASIVE SPECIES OCCURRING.

-MOWING SHOULD OCCUR IN AREAS OF THE SITE IDENTIFIED TO HAVE VEGETATION OVER 16 INCHES IN HEIGHT. AREAS WITH HEIGHT UNDER 16 INCHES MAY REMAIN UNTIL THE NEXT SCHEDULED MONITORING VISIT. SEEDED AREAS SHOULD BE CUT BACK TO 12 INCHES IN HEIGHT.

-IF INVASIVE WOODY AND HERBACEOUS FLORA HAVE BEEN IDENTIFIED, PHYSICAL REMOVAL OR SPOT *HERBICIDE TREATMENTS ARE REQUIRED.

FALL:

-SITE VISIT IS TO BE PERFORMED ONE TIME DURING THE FALL, WITH MONITORING AND EVALUATION OF VEGETATION HEIGHT AND PRESENCE OF INVASIVE SPECIES OCCURRING.

-MOWING SHOULD OCCUR IN AREAS OF THE SITE IDENTIFIED TO HAVE VEGETATION OVER 24 INCHES IN HEIGHT. AREAS WITH HEIGHT UNDER 24 INCHES MAY REMAIN UNTIL THE NEXT SCHEDULED MONITORING VISIT. SEEDED AREAS SHOULD BE CUT BACK TO 12 INCHES IN HEIGHT.

-IF INVASIVE WOODY AND HERBACEOUS FLORA HAVE BEEN IDENTIFIED, PHYSICAL REMOVAL OR SPOT *HERBICIDE TREATMENTS ARE REQUIRED.

FOLLOWING THE FIFTH YEAR

-SITE VISITS ARE TO BE PERFORMED TWICE A YEAR, DURING THE EARLY SPRING AND LATE SUMMER, WITH MONITORING AND EVALUATION OF VEGETATION HEIGHT AND PRESENCE OF INVASIVE SPECIES OCCURRING AT EACH VISIT.

-DURING THE SPRING, MOWING SHOULD OCCUR TO CUT BACK ANY VEGETATION TO A HEIGHT OF 10 INCHES AND REMOVE DEAD STALKS AND SEED HEADS FROM THE PREVIOUS GROWING SEASON. -DURING THE FALL, MOWING SHOULD OCCUR IN AREAS OF THE SITE IDENTIFIED TO HAVE VEGETATION OVER 24 INCHES IN

HEIGHT. AREAS WITH HEIGHT UNDER 24 INCHES MAY REMAIN UNTIL THE NEXT SCHEDULED MONITORING VISIT. SEEDED AREAS SHOULD BE CUT BACK TO 12 INCHES IN HEIGHT

-IF INVASIVE WOODY AND HERBACEOUS FLORA HAVE BEEN IDENTIFIED, PHYSICAL REMOVAL OR SPOT *HERBICIDE TREATMENTS ARE REQUIRED.

PERFORMANCE STANDARDS

SATISFACTORY LANDSCAPE DEVELOPMENT ASSOCIATED WITH NATURALIZED VEGETATION WILL BE BASED ON THE FOLLOWING ITEMS.

FIRST YEAR:

WITHIN THREE MONTHS OF SEED INSTALLATION (OR THREE MONTHS AFTER THE START OF THE GROWING SEASON FOLLOWING DORMANT SEEDING), APPROXIMATELY 90 PERCENT OF THE SEEDED AREA, AS MEASURED BY AERIAL COVER, WILL BE VEGETATED OR OTHERWISE STABILIZED AGAINST EROSION. THE COVER CROP MAY BE INCLUDED IN THIS MEASUREMENT. IF MINIMUM IS NOT MET. ADDITIONAL SEEDING IS REQUIRED IN AREAS WITH POOR COVER.

SECOND YEAR:

BY THE END OF THE SECOND GROWING SEASON, THE PLANTED AREAS ARE DESIGNED TO HAVE A MINIMUM OF 50 PERCENT GROUND COVER BY SPECIES IN FINAL SEED MIX (NOT TO INCLUDE TEMPORARY COVER CROP OR UNDESIRABLE / INVASIVE SPECIES).

THIRD YEAR:

BY THE END OF THE THIRD GROWING SEASON, THE PLANTED AREAS ARE DESIGNED TO HAVE A MINIMUM OF 75 PERCENT GROUND COVER BY SPECIES IN FINAL SEED MIX (NOT TO INCLUDE TEMPORARY COVER CROP OR UNDESIRABLE / INVASIVE SPECIES).

IF PERFORMANCE STANDARD IS NOT MET AT EACH OBSERVATION, LANDSCAPE CONTRACTOR IS TO NOTIFY OWNER AND DEVELOP CORRECTIVE ACTION SUCH AS SEEDING OR HERBICIDE **TREATMENT**

GENERAL LANDSCAPE NOTES

- 1. THE LANDSCAPE CONTRACTOR SHALL BE RESPONSIBLE FOR INSTALLING MATERIALS AND PLANTS SHOWN ON THE LANDSCAPE PLAN. THE CONTRACTOR IS RESPONSIBLE FOR THE COST TO REPAIR UTILITIES, ADJACENT LANDSCAPE, PUBLIC AND PRIVATE PROPERTY THAT IS DAMAGED BY THE CONTRACTOR OR THEIR SUBCONTRACTOR'S OPERATIONS DURING INSTALLATION OR DURING THE SPECIFIED MAINTENANCE PERIOD. CALL FOR UTILITY LOCATIONS PRIOR TO ANY EXCAVATION.
- 2. THE CONTRACTOR SHALL REPORT ANY DISCREPANCY IN PLAN VS. FIELD CONDITIONS IMMEDIATELY TO THE LANDSCAPE ARCHITECT, PRIOR TO CONTINUING WITH THAT PORTION OF
- 3. NO PLANTING WILL BE INSTALLED UNTIL ALL GRADING AND CONSTRUCTION HAS BEEN COMPLETED IN THE IMMEDIATE AREA.
- 4. THE CONTRACTOR SHALL BE RESPONSIBLE FOR THE REPAIR OF ANY OF THEIR TRENCHES OR EXCAVATIONS THAT SETTLE.
- DO NOT DISTURB THE EXISTING PAVING, LIGHTING, OR LANDSCAPING THAT EXISTS ADJACENT TO THE SITE UNLESS OTHERWISE NOTED ON PLAN.
- 6. PLANT QUANTITIES SHOWN ARE FOR THE CONVENIENCE OF THE OWNER AND JURISDICTIONAL REVIEW AGENCIES. THE CONTRACTOR IS RESPONSIBLE FOR VERIFYING ALL PLANT QUANTITIES AS DRAWN.
- THE CONTINUED MAINTENANCE OF ALL REQUIRED LANDSCAPING SHALL BE THE RESPONSIBILITY OF THE OWNER OF THE PROPERTY ON WHICH SAID MATERIALS ARE REQUIRED. ALL PLANT MATERIALS REQUIRED BY THIS SECTION SHALL BE MAINTAINED AS LIVING VEGETATION AND SHALL BE PROMPTLY REPLACED IF THE PLANT MATERIAL HAS DIED PRIOR TO FINAL ACCEPTANCE.
- 8. NO GENERAL SPRAY OF HERBICIDES IS TO BE USED FOR ANY SEEDED AREAS.
- 9. ONLY HERBICIDES FORMULATED FOR ANIMAL SAFETY SHALL BE USED.
- 10. ALL WORK DEEMED NATURAL AREA TO BE SEEDED OR PLANTED SHALL BE PERFORMED BY A QUALIFIED LANDSCAPE CONTRACTOR.
- 11. SEED SHALL BE OBTAINED FROM SOURCE SPECIALIZING IN NATIVE SPECIES, WHERE AVAILABLE OR AS APPROVED BY CLIENT OR CLIENT'S REPRESENTATIVE.
- 12. ALL SEED MIXES SHALL BE INSTALLED WITH A COVER CROP DEPENDENT ON SEASON AND REQUIREMENTS SPECIFIED PER SEED MIX / SEED SUPPLIER.

ESTABLISHMENT NOTES AND STANDARDS

SEED AREA ESTABLISHMENT

PREPARATION

-SOIL IN AREAS OF EXISTING AGRICULTURAL USAGE IS RECOMMENDED TO BE TESTED FOR HIGH LEVELS OF HERBICIDES, AND AMENDED APPROPRIATELY TO BRING CONCENTRATION DOWN TO LEVELS APPROPRIATE FOR COMMON GRASSES. SOILS IDENTIFIED TO BE HIGH IN HERBICIDES OR CONTAMINATES SHOULD BE EVALUATED BY AN ENVIRONMENTAL SPECIALIST OR SOIL SCIENTIST TO DETERMINE REQUIRED METHODS OF REMEDIATION. -SOILS SHALL BE UNIFORM, WITHOUT EXCESSIVE FURROWS, RUTS, OR RIDGES, AND LOW AREAS WHERE WATER MAY COLLECT.

-SOILS SHOULD BE CLEARED OF TRASH, DEBRIS, AND INVASIVE SPECIES PRIOR TO FINAL SEEDING APPLICATION. -SOIL PREPARATION SHALL OCCUR WHEN WEATHER PERMITS AND TIMING ALLOWS FOR AT LEAST A FOLLOWING 48 HOURS WHERE SEEDING AND STABILIZATION METHODS MAY TAKE PLACE.

TIMING

-TO PROMOTE EARLY AND STRONG ESTABLISHMENT OF SPECIFIED SEED MIX, DORMANT SEASON SEED APPLICATION SHOULD BE UTILIZED IF POSSIBLE AND AS CONSTRUCTION TIMELINE PERMITS

-DORMANT SEASON SEEDING SHOULD UTILIZE WINTER-TOLERANT SEED FROM THE SPECIFIED SEED MIX, ALONG WITH 20-30 LBS PER ACRE OF A WINTER NURSE CROP SUCH AS SECALE CEREALE, PISUM SATIVUM, OR AVENA SATIVA. -TO APPLY DORMANT SEED, SITE SHOULD BE CLEARED OF INVASIVE WEEDS, LIGHTLY TILLED OR DISKED, THEN DRILL APPLIED ACROSS THE ENTIRE AREA OF AGRICULTURAL SOIL.

-ACTIVE SEASON SEED APPLICATION SHOULD BE PERFORMED BETWEEN APRIL 1ST AND MAY 30TH, AFTER RISK OF MAJOR FREEZING CONDITIONS IS MINIMIZED, FOR IDEAL ESTABLISHMENT AND MINIMIZING INVASIVE SPECIES COMPETITION.

APPLICATION

-SEED MIXTURES SHALL BE MECHANICALLY DRILLED.

-NO STRAW MULCH IS REQUIRED, UNLESS NEEDED FOR STEEP SLOPES, SOIL STABILIZATION, OR OTHER AREAS THAT ARE IDENTIFIED FOR EROSION PREVENTION.

-SEED SHALL BE APPLIED AT INDICATED RATES WITH COVER CROP OATS, JAPANESE MILLET, WINTER WHEAT, ANNUAL RYE, OR SPECIFIED CROP DEPENDENT ON SEASON AND SOIL CONDITIONS.

-FINAL SEED MIX MAY VARY DEPENDENT UPON SPECIFIC SPECIES AVAILABILITY AND TIME OF INSTALLATION. -FINAL SEED MIX SHALL BE APPROVED BY OWNER, OWNER'S REPRESENTATIVE, OR LANDSCAPE ARCHITECT.

-SITE SHOULD BE MONITORED FOLLOWING INSTALLATION FOR AREAS IDENTIFIED FOR ADDITIONAL RESEEDING UNTIL

INVASIVE WEED CONTROL, MONITORING, AND MANAGEMENT

-A WORK PLAN SHOULD BE DEVELOPED TO AVOID THE SPREAD OF INVASIVE PLANTS FROM THESE AREAS -IF SUBSTANTIAL AREAS OF INVASIVE HERBACEOUS SPECIES ARE FOUND PRIOR TO OR AFTER PROJECT

-FOR INVASIVE TREES, SHRUBS, AND VINES, MANAGEMENT MAY REQUIRE CUT-STEM HERBICIDE TREATMENTS. -ALL INVASIVE SPECIES MANAGEMENT SHOULD BE CONDUCTED DURING THE SUMMER MONTHS WHILE THE TARGET

SEPARATED BY AT LEAST TWO WEEKS.

TREE AND SHRUB INSTALLATION

-ALL PLANTS TO BE SPECIMEN GRADE, WELL BRANCHED, HEALTHY, FULL, PRE-INOCULATED, AND FERTILIZED. PLANTS SHALL BE FREE FROM DISEASE, PESTS, WOUNDS, AND SCARS. PLANTS SHALL BE FREE FROM NOTICEABLE GAPS,

CONTRACTOR SHALL REMOVE THE WRAP AT THE PROPER TIME AS PART OF THIS CONTRACT -THE OWNER'S REPRESENTATIVE MAY REJECT ANY PLANT MATERIALS THAT ARE DISEASED. DEFORMED. OR

INSPECTION. THE GUARANTEE BEGINS ON THE DATE OF THE LANDSCAPE ARCHITECT'S OR OWNER'S WRITTEN

REQUIREMENTS FOR SIZE AND TYPE SPECIFIED.

-PRUNE PLANTS AS NECESSARY PER STANDARD NURSERY PRACTICE AND TO CORRECT POOR BRANCHING OF EXISTING AND PROPOSED TREES.

-SEED SPECIES SHALL BE LOCALLY SOURCED WHEN FEASIBLE.

-IF SEEDING IS PERFORMED PRIOR TO FINAL SITE INSTALLATION, ADDITIONAL SEED MAY BE APPLIED BY A LOW SPREADER IN AREAS THAT WERE DISTURBED.

SEED MIX IS SUFFICIENTLY ESTABLISHED.

DEVELOPMENT, FOLIAR OR BROADCAST HERBICIDE APPLICATIONS MAY BE REQUIRED.

PLANTS ARE ACTIVELY GROWING. -TREATMENTS SHOULD BE CONDUCTED ACCORDING TO MAINTENANCE PLANS EACH YEAR AND SHOULD BE

-HERBICIDE USE REPORTING WILL ADHERE TO ALL APPLICATOR LICENSING REQUIREMENTS

HOLES, OR DEFORMITIES. PLANTS SHALL BE FREE FROM BROKEN OR DEAD BRANCHES. -TRUNKS WILL BE WRAPPED IF NECESSARY TO PREVENT SUN SCALD AND INSECT DAMAGE. THE LANDSCAPE

OTHERWISE NOT EXHIBITING SUPERIOR QUALITY. -ALL NURSERY STOCK SHALL BE GUARANTEED, BY THE CONTRACTOR, FOR ONE YEAR FROM DATE OF FINAL

ACCEPTANCE OF THE INITIAL PLANTING. REPLACEMENT PLANT MATERIAL SHALL HAVE A ONE YEAR GUARANTEE COMMENCING UPON PLANTING. -PLANTS ARE TO MEET AMERICAN STANDARD FOR NURSERY STOCK (ANSI Z60.1-2014 OR MOST CURRENT VERSION)

-CONTRACTOR SHALL INSTALL SHREDDED HARDWOOD MULCH AT A 3" DEPTH TO ALL TREE AND SHRUB AREAS. TREES PLACED IN AREA COVERED BY TURF SHALL RECEIVE A 4' WIDE TREE RING WITH 3" DEPTH SHREDDED HARDWOOD MULCH.

> Before **ULIE**

SCAPE SS AND FAILS

N O O

 $\overline{\mathsf{O}}$


S

 \triangleleft


(')

SHEET NUMBER

L-200

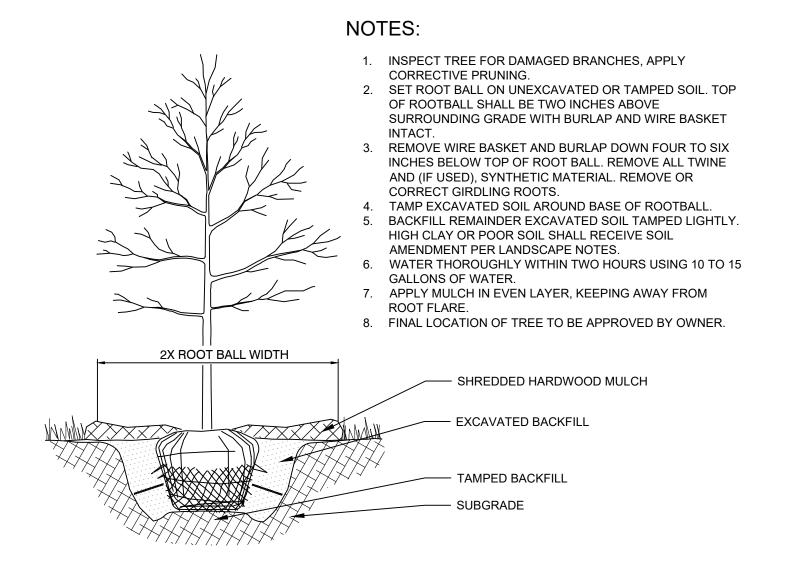

NTS

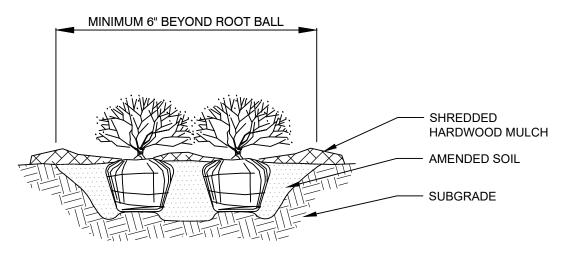

NOTES:


TREE PLANTING

- APPLY CORRECTIVE PRUNING.
- 2. SET ROOT BALL OR CONTAINER ON UNEXCAVATED OR TAMPED SOIL. TOP OF ROOTBALL (CONTAINER) SHALL BE ONE INCH ABOVE SURROUNDING GRADE. FOR LARGER SHRUBS WITHIN PLANTING BED DIG A DEEPER PIT ONLY FOR THOSE SHRUBS.
- 3. REMOVE BURLAP FROM TOP HALF THE LENGTH OF ROOTBALL. TWINE AND (IF USED) SYNTHETIC MATERIAL SHALL BE REMOVED FROM PLANTING BED. FOR CONTAINER GROWN SHRUBS, REMOVE CONTAINER AND LOOSEN ROOTS PRIOR TO INSTALLATION.
- 4. REMOVE OR CORRECT GIRDLING ROOTS. 5. PLUMB AND BACKFILL WITH AMENDED SOIL PER LANDSCAPE NOTES. WATER
- THOROUGHLY WITHIN TWO HOURS. 6. APPLY MULCH IN EVEN LAYER, KEEPING AWAY FROM ROOT FLARE. MULCH LIMITS FOR SHRUBS EXTEND TO ALL LIMITS OF PLANTING BED, SEE PLANS FOR BED LAYOUTS.

SHRUB PLANTING

PLANT SCHEDULE

SYMBOL	CODE	QTY	BOTANICAL / COMMON NAME	CONT	SIZE
TREES					
+	ET	1,327	EVERGREEN TREE	-	24" HT. MIN.
\bigcirc	UT	584	UNDERSTORY TREE	-	24" HT. MIN.
SHRUBS (**)	DS	659	DECIDUOUS SHRUB	-	

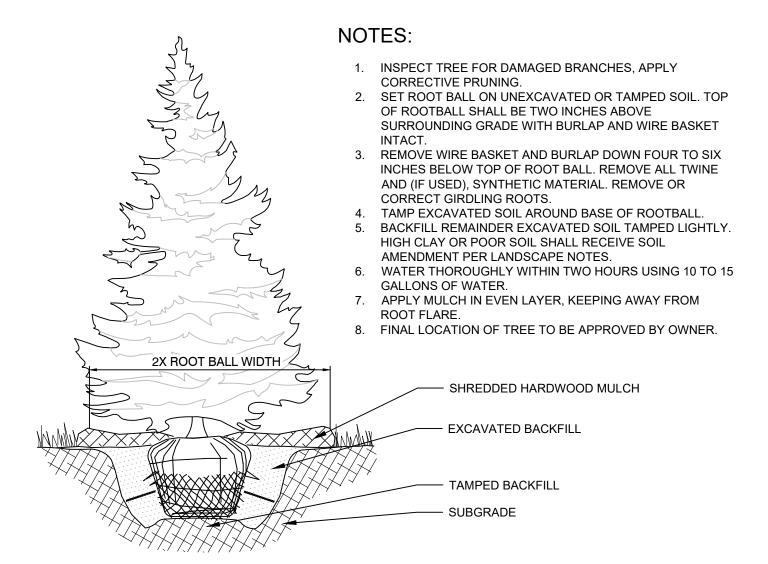

NTS

EVERGREEN TREE PLANTING

- DIG HOLE WITH AMPLE SPACE FOR TREE ROOTS. SURFACE PLANT MATERIAL OR LEAVES ARE TO BE SEPARATED A FROM THE EXCAVATED SOIL AT THE EDGE OF THE HOLE — EXCAVATED SOIL — EXISTING SOIL — EXISTING VEGETATION/LANDSCAPE MATERIAL - PLANT TREE TRUNK TO BE PLUMB AND TRUE - PLANT BARE ROOT TREE SAPLING WITH THE ROOT FLARE ABOVE THE ADJACENT EXISTING GRADE BACKFILL PLANTING HOLE WITH CRUMBLED FRIABLE EXISTING TOPSOIL EVENLY AROUND THE ROOTS OF THE TREE SAPLING. - BACKFILL PLANT HOLE WITH EXISTING TOPSOIL - SPREAD THE EXISTING LEAF MULCH OR LANDSCAPE MATERIAL OVER THE EXPOSED GROUND SURFACE - COMPACT THE EXISTING TOPSOIL DOWN TO 85% PROCTOR DENSITY

- HEAL IN EXISTING TOPSOIL FIRMLY WITH TOE

AROUND THE STEM OF THE TREE SAPLING

- DISTRIBUTE THE EXISTING LEAF MULCH OR LANDSCAPE MATERIAL

NTS

BARE ROOT TREE PLANTING DETAIL

Call Before

SOL

GATEWAY