


LEGEND	
ITEM	SYMBOL
WIND TURBINE DESIGNATION	T53
SOIL BOUNDARY	---
PARCEL BOUNDARY	---
115 KV OVERHEAD GENERATOR LEAD LINE	—115KV—
115 KV GENERATOR LEAD LINE POLE	●
UNDERGROUND COLLECTION LINE	---
OVERHEAD COLLECTION LINE	---
PERMANENT ACCESS ROAD EDGE	---
WIND TURBINE CONSTRUCTION SITE	☐

NOTE: REFER TO APPENDIX C OF THE PRELIMINARY STORMWATER POLLUTION PREVENTION PLAN (SWPPP) FOR SOIL MAP UNIT NAMES AND SOIL DESCRIPTIONS.

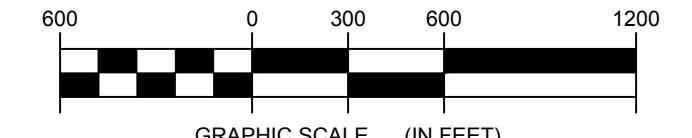

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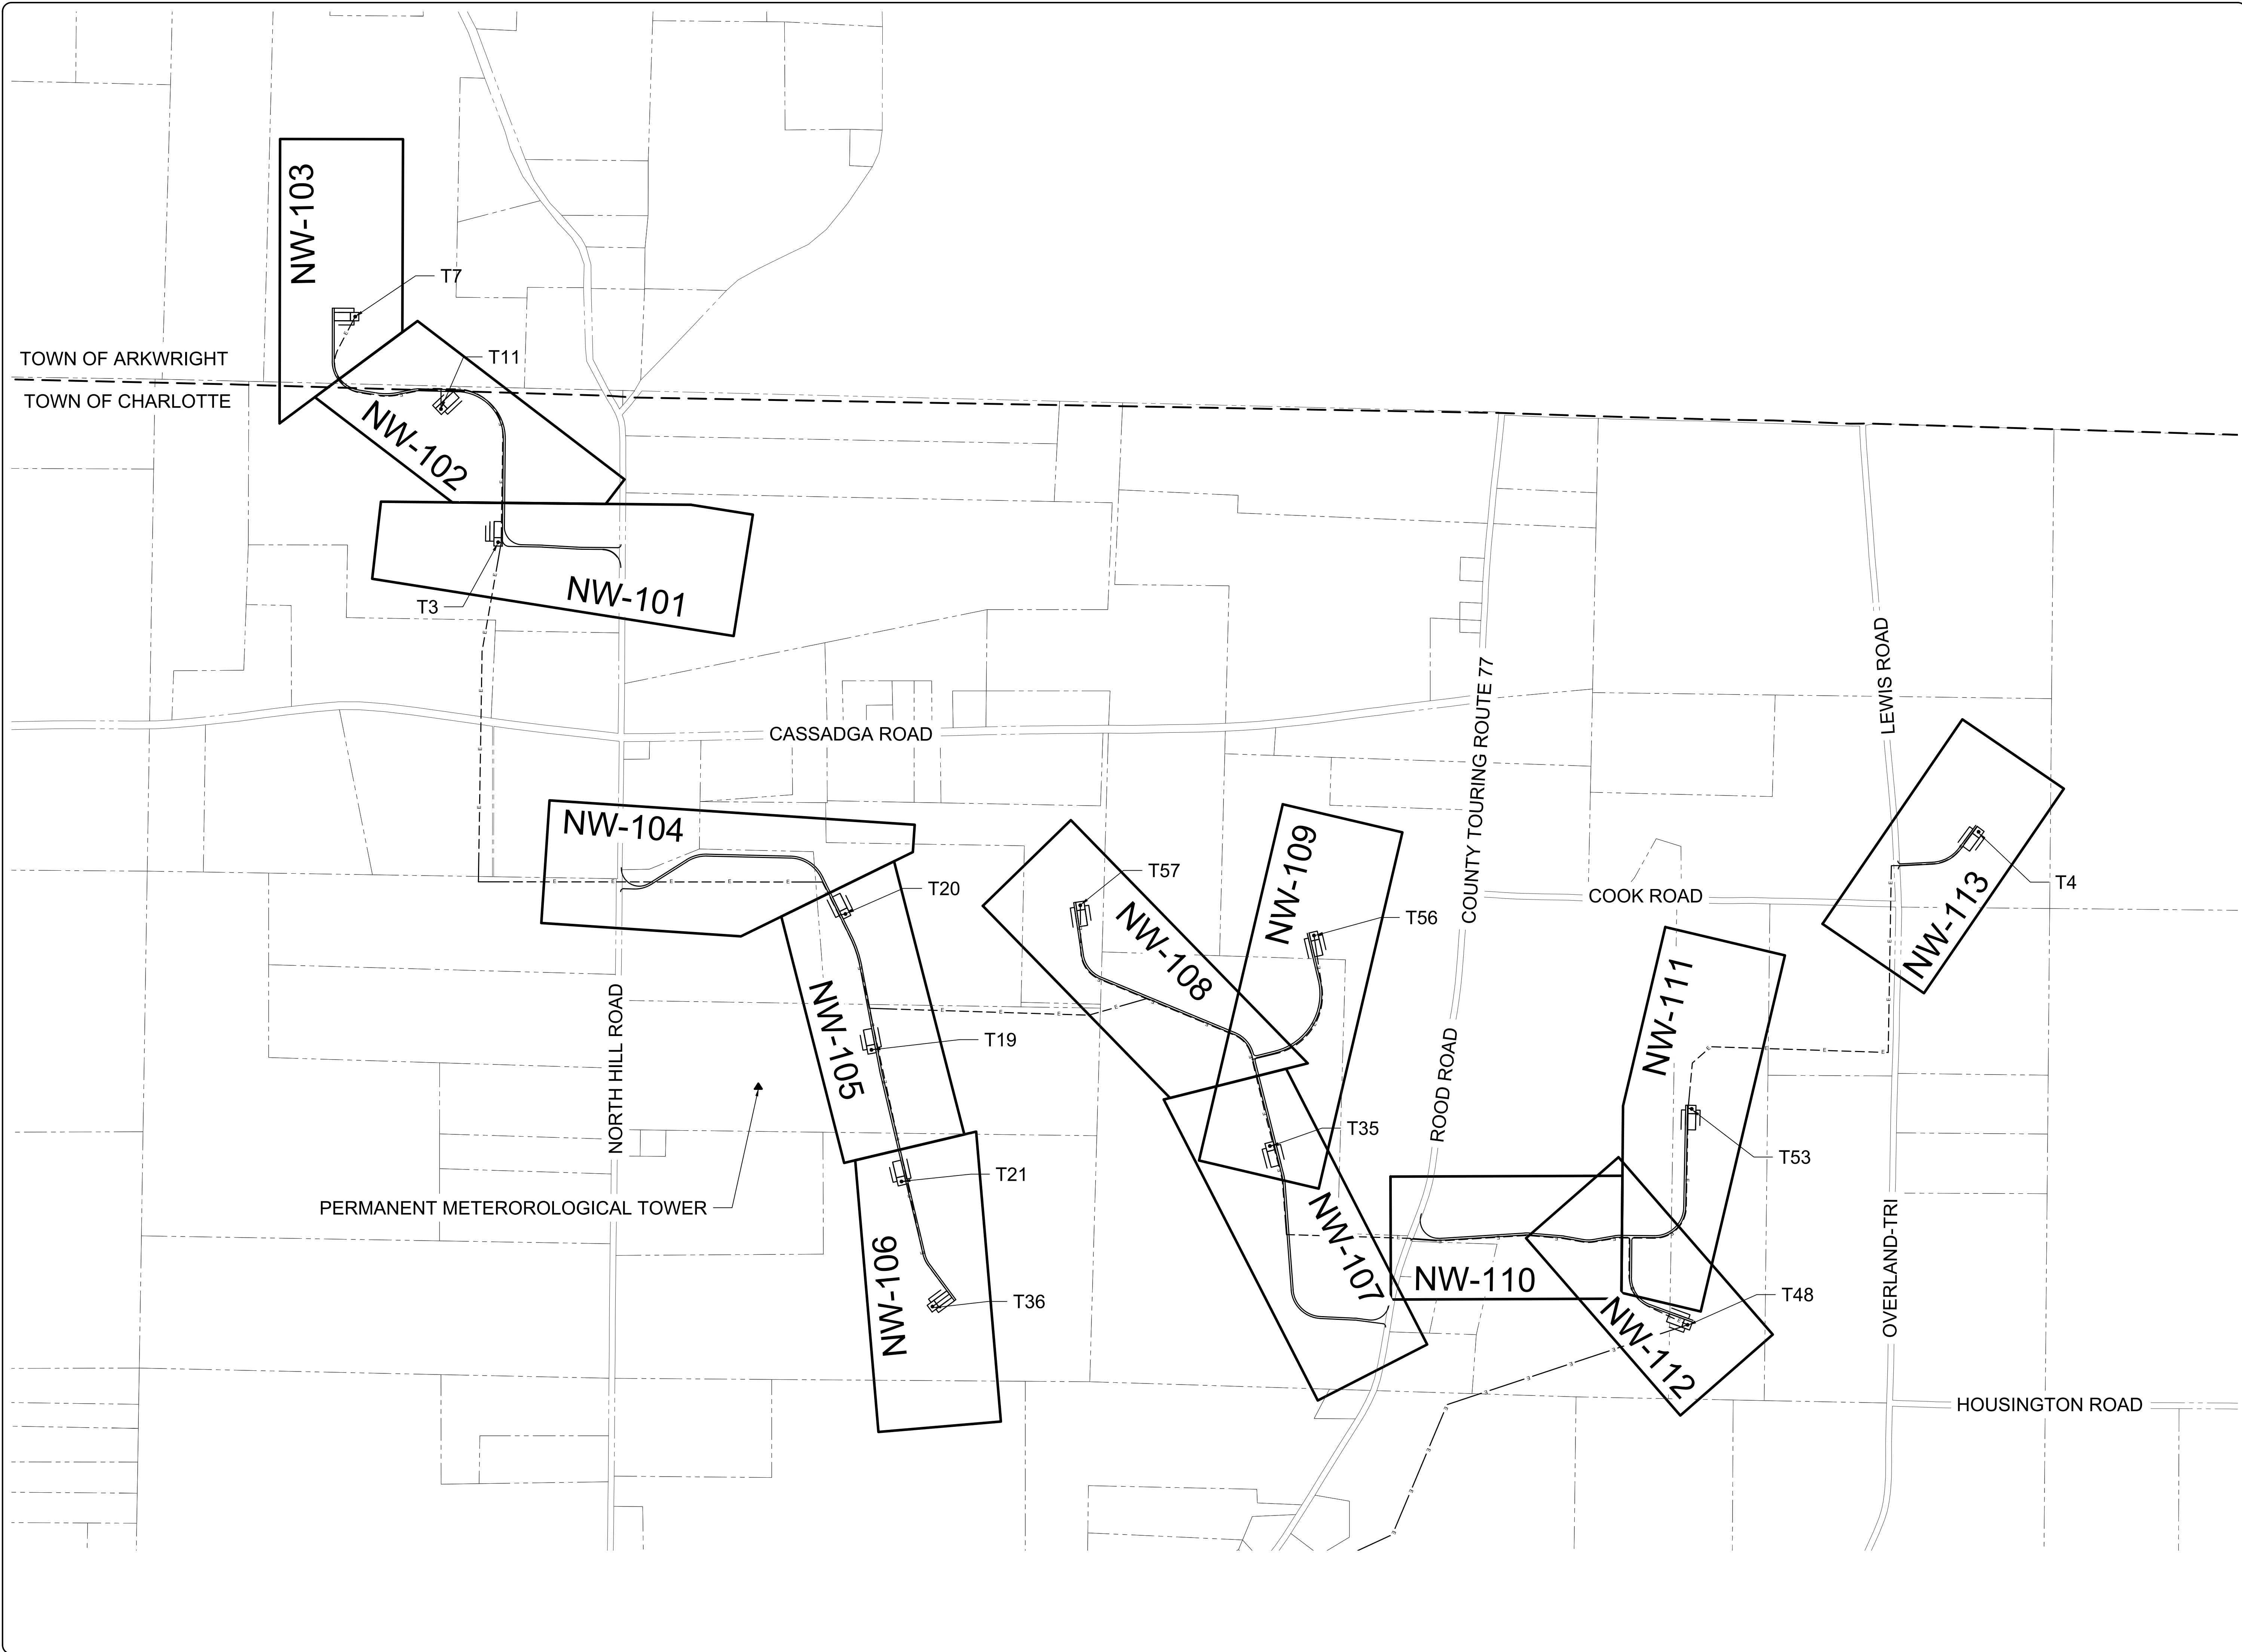
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DRAWING REVISIONS	
NO.	DATE

**PROJECT TITLE: CASSADAGA WIND PROJECT**  
TOWNS OF CHARLOTTE, CHERRY CREEK, ARKWRIGHT, AND STOCKTON  
PROJECT LOCATION: CHAUTAQUA COUNTY, NEW YORK  
CLIENT: CASSADAGA WIND LLC  
DRAWING TITLE: NORTHWEST SOIL MAP

DATE: APRIL 22, 2016  
SCALE: 1"=600'  
edr Job#: 14048  
DRAWN BY: AW, CB, ZR  
CHECKED BY: TD  
FILE NAME:  
14048\_Working\_NW.dwg  
DRAWING NUMBER:  
**NW-001**



TOWN OF ARKWRIGHT  
TOWN OF CHARLOTTE

NW-103

NW-102

NW-101

NW-104

NW-105

NW-106

NW-108

NW-109

NW-107

NW-110

NW-111

NW-112

NW-113

PERMANENT METEOROLOGICAL TOWER

T7

T11

T3

T20

T57

T56

T19

T21

T36

T35

T53

T48

T4

CASSADAGA ROAD

NORTH HILL ROAD

ROOD ROAD

COUNTY TOURING ROUTE 77

COOK ROAD

LEWIS ROAD

OVERLAND-TRI


HOUSINGTON ROAD



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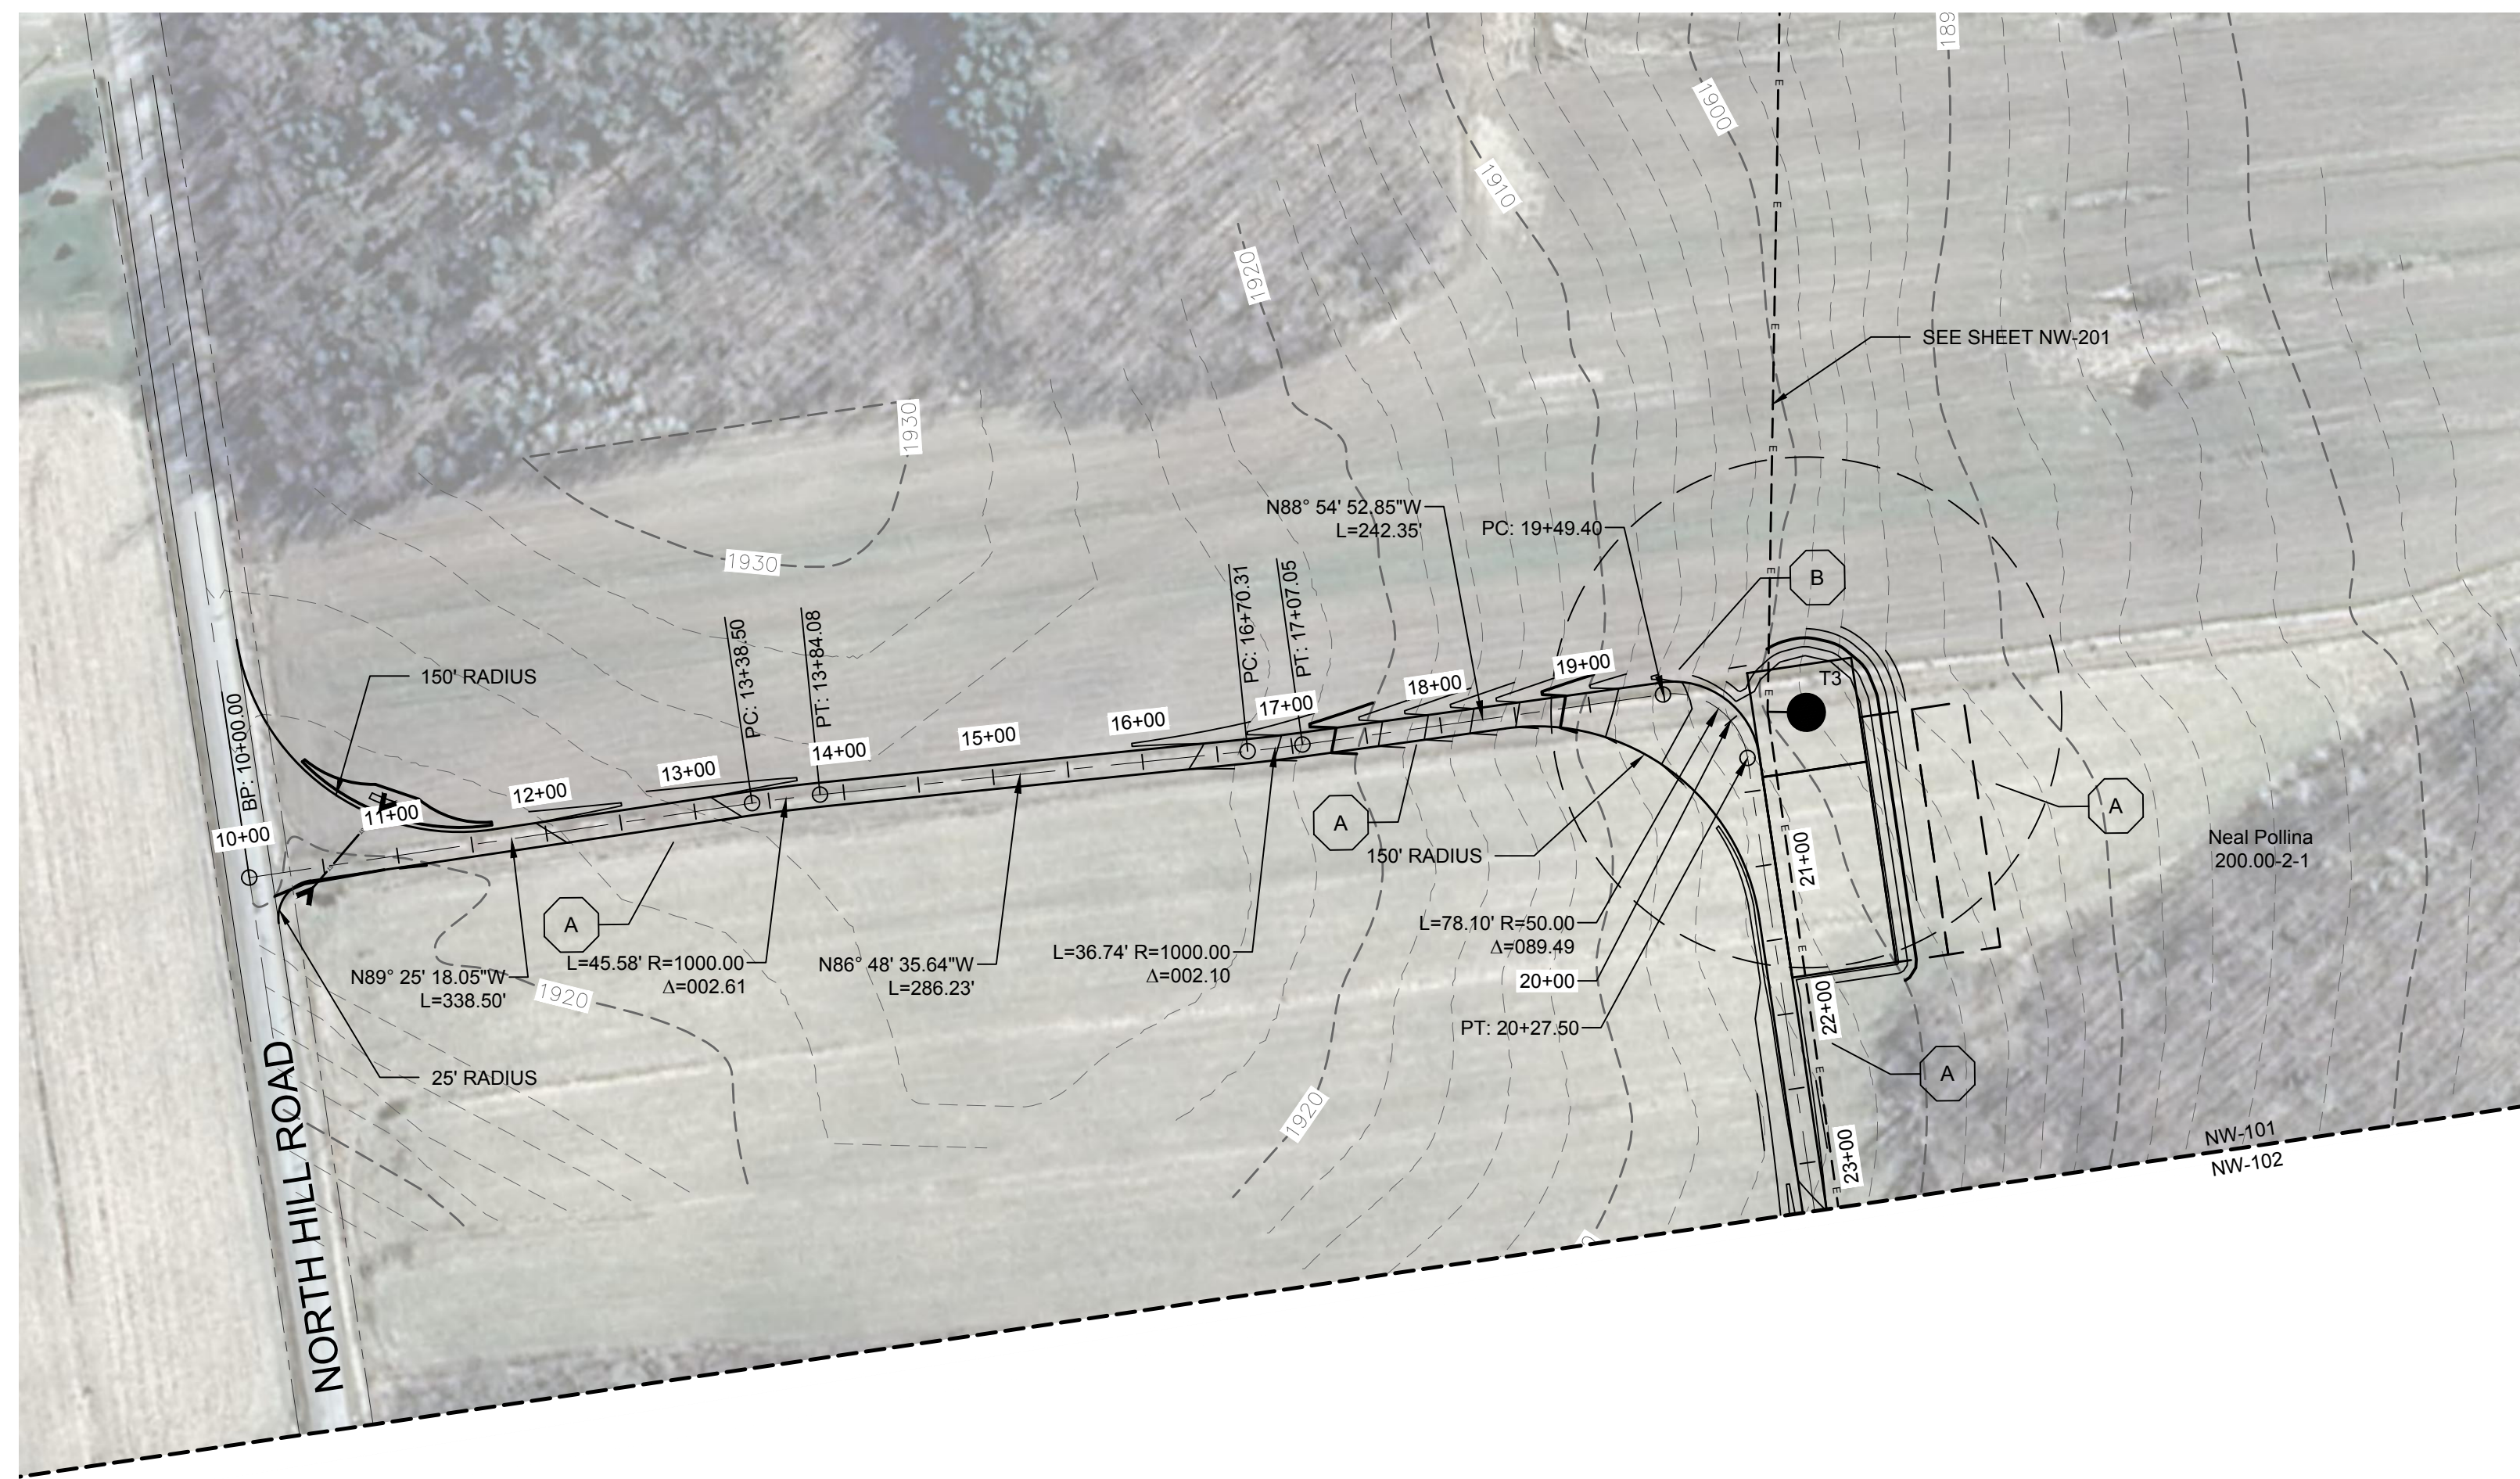
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NO.	DATE

**PROJECT TITLE: CASSADAGA WIND PROJECT**  
TOWNS OF CHARLOTTE, CHERRY CREEK, ARKWRIGHT, AND STOCKTON  
**PROJECT LOCATION: CHAUTAQUA COUNTY, NEW YORK**  
CLIENT: CASSADAGA WIND LLC  
**DRAWING TITLE: ACCESS ROAD INDEX SHEET**


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DRAWING NUMBER:  
**NW-100**

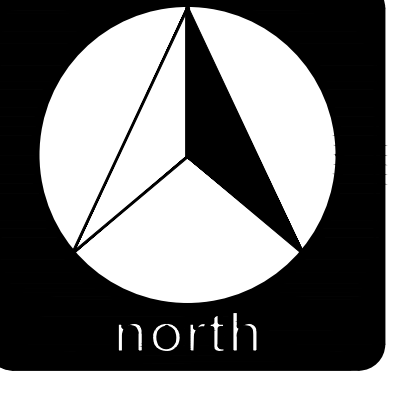J:\14048\_Cassadaga\_Wind\working\drawing\14048\_Access.dwg





1 PLAN VIEW - TRUNK T7 ACCESS ROAD TO TURBINES T3, T11 AND T7  
Scale: 1"=100'

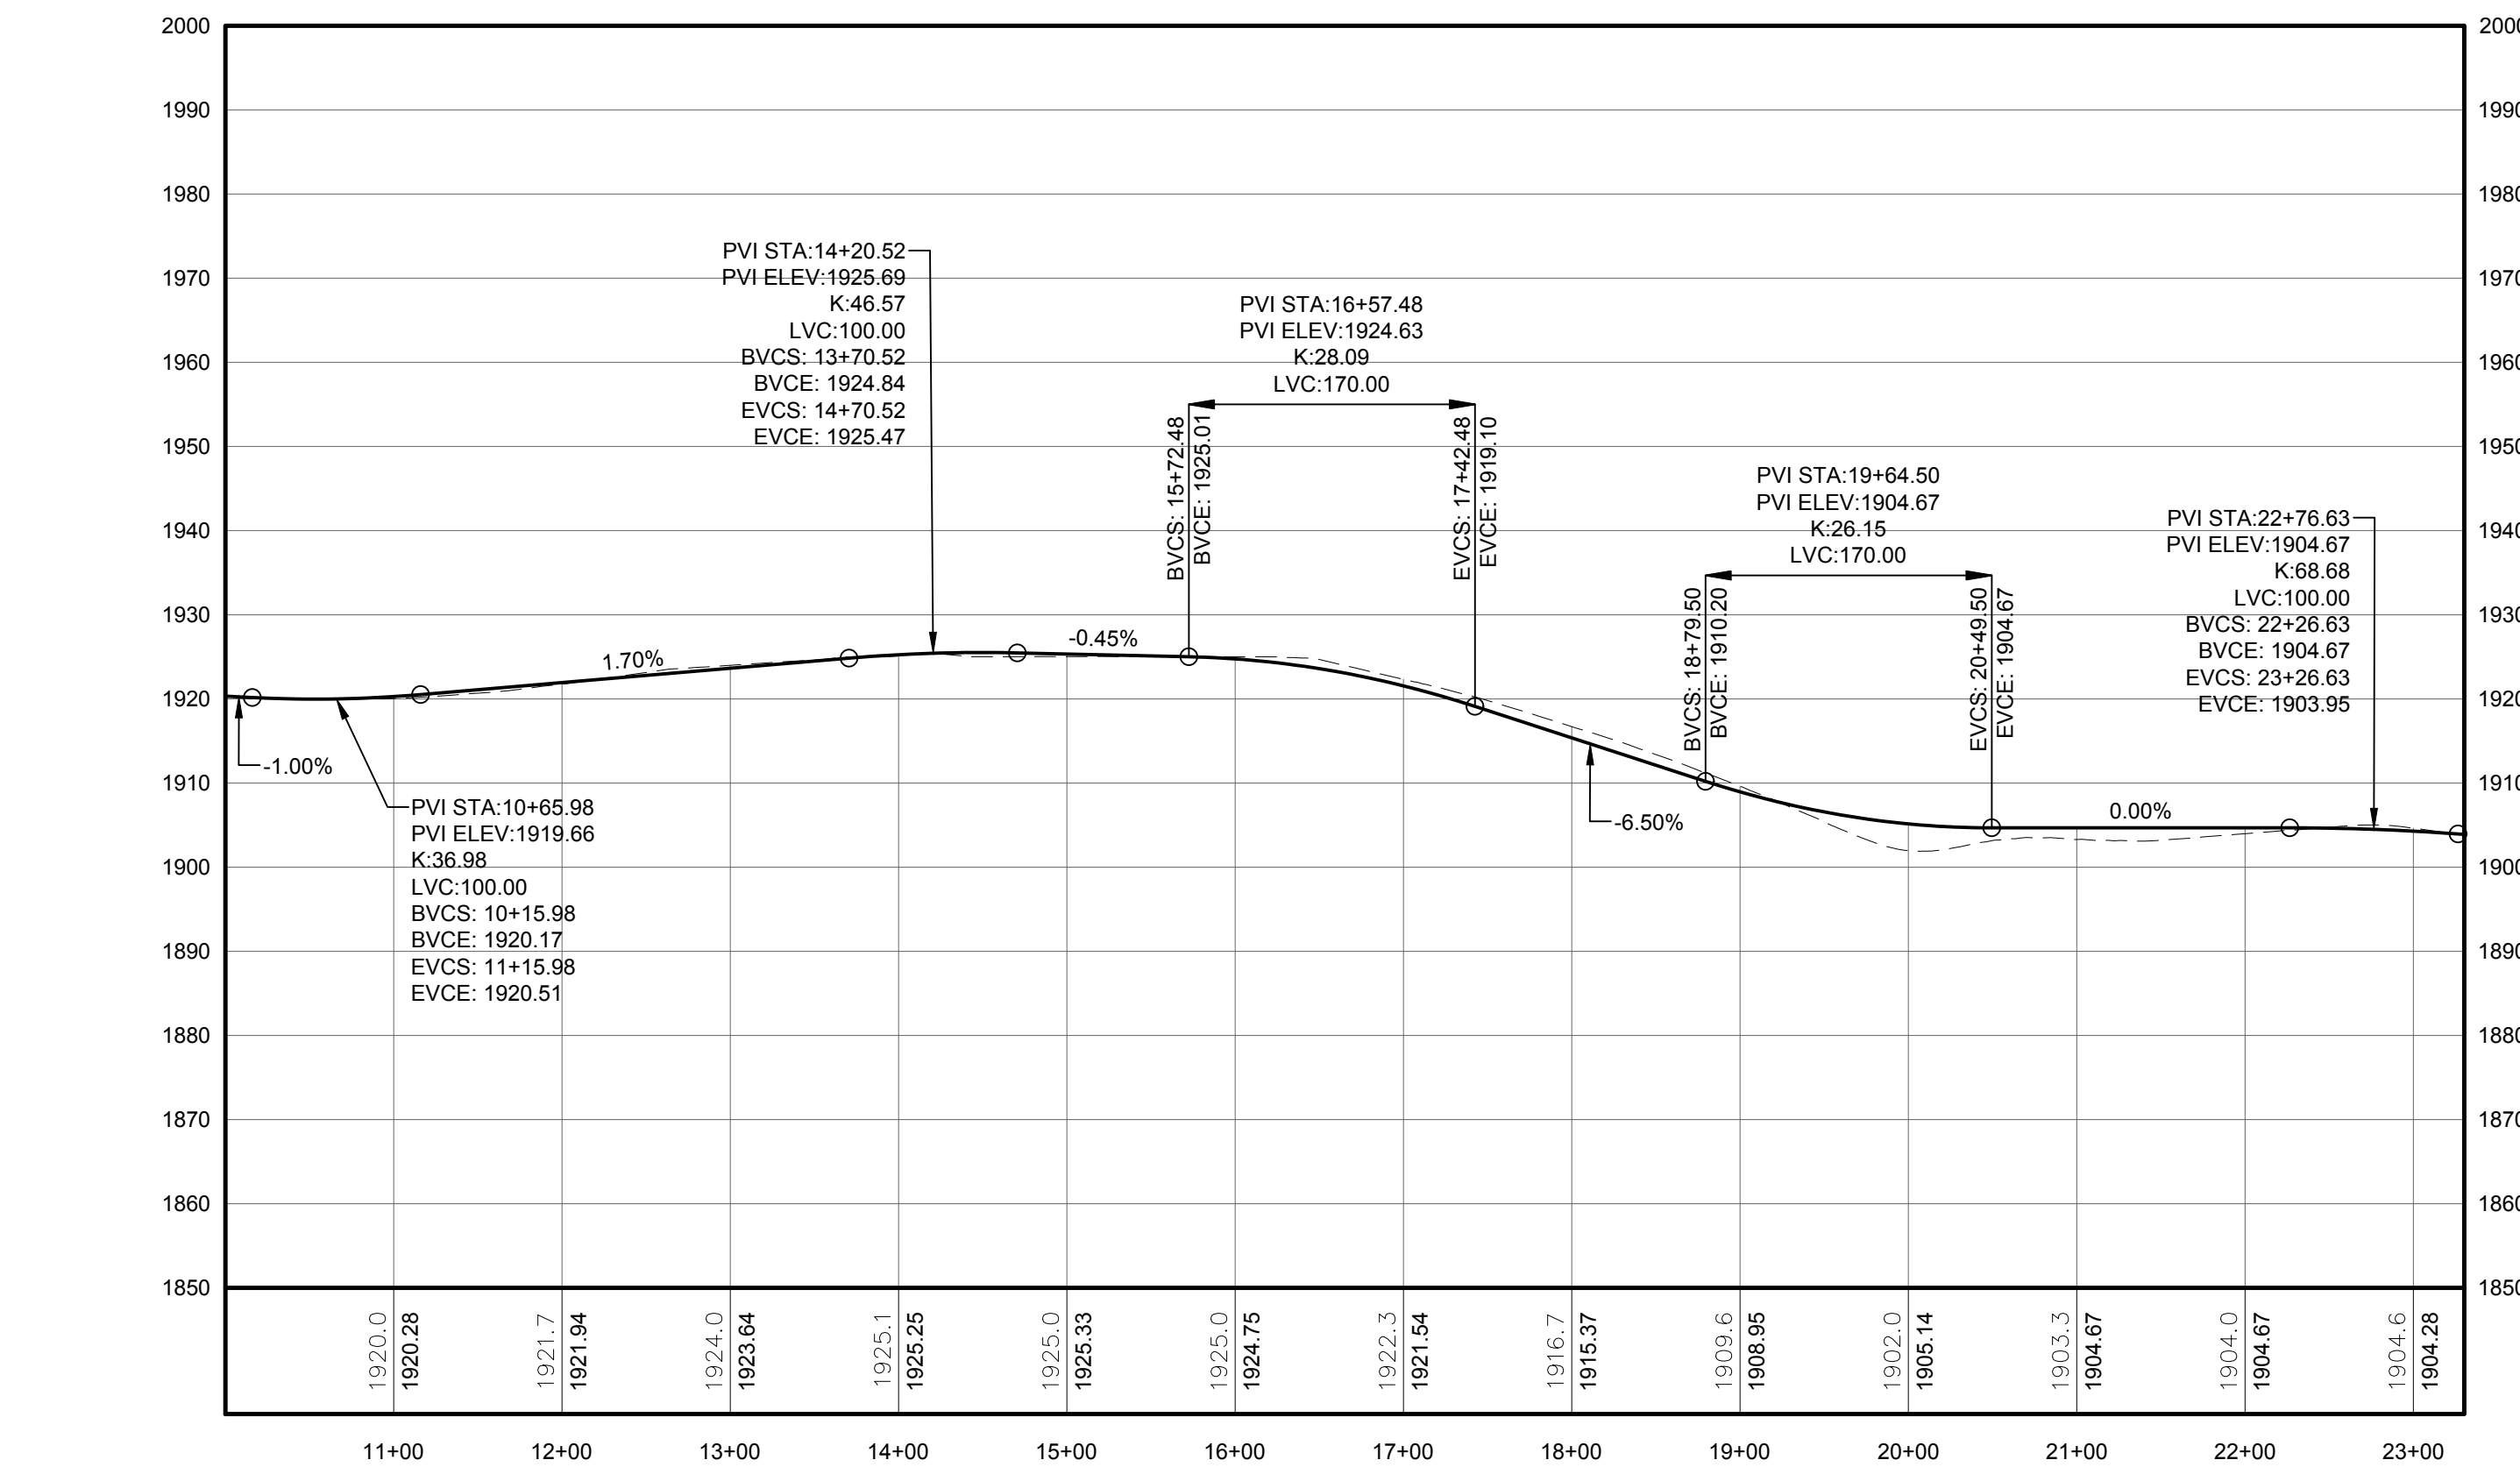


2 ACCESS ROAD PROFILE  
Scale: H:1"=100' V:1"=20'

STORMWATER KEY NOTES	
ITEM	SYMBOL
VEGETATIVE FILTER STRIP	(A)
LEVEL SPREADER	(B)
DRY SWALE	(C)

NOTE: SEE SHEET C-605 FOR DETAILS


LEGEND	
ITEM	SYMBOL
DRAWING SHEET MATCH LINE	--- DRAWING NUMBER ---
WIND TURBINE DESIGNATION	T53
PARCEL BOUNDARY	---
115 KV OVERHEAD GENERATOR LEAD LINE	---
115 KV OVERHEAD GENERATOR LEAD LINE POLE	⊙
UNDERGROUND COLLECTION LINE	---
OVERHEAD COLLECTION LINE	---
EXISTING CONTOUR (2' INTERVAL)	---
EXISTING CONTOUR - INDEX (2' INTERVAL)	---
CONTOUR - FINISHED (2' INTERVAL)	---
CONTOUR - FINISHED - INDEX (2' INTERVAL)	---
ACCESS ROAD CENTERLINE	---
PERMANENT ACCESS ROAD EDGE	---
STORM WAVE / CULVERT	---
NYSDEC WETLAND	---
WETLAND BOUNDARY	---
STREAM BOUNDARY	---
APPROXIMATE WETLAND BOUNDARY	---
APPROXIMATE STREAM BOUNDARY	---
ENVIRONMENTALLY SENSITIVE AREA - RESTRICTED ACCESS	---
ENVIRONMENTALLY SENSITIVE AREA	---
WIND TURBINE CONSTRUCTION SITE	---
ROTOR LAYDOWN	---
WIND TURBINE	---
GRAVEL PAD	---
WORK AREA	---
CRANE PAD	---

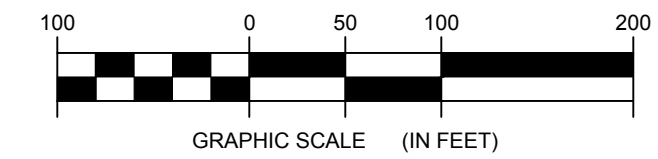

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PROFILE LEGEND	
ITEM	SYMBOL
EXISTING ELEVATION (FT)	1845.3
PROPOSED ELEVATION (FT)	1845.27
EXISTING GRADE	---
PROPOSED GRADE	---

NOTE: ELEVATIONS IN USGS DATUM.

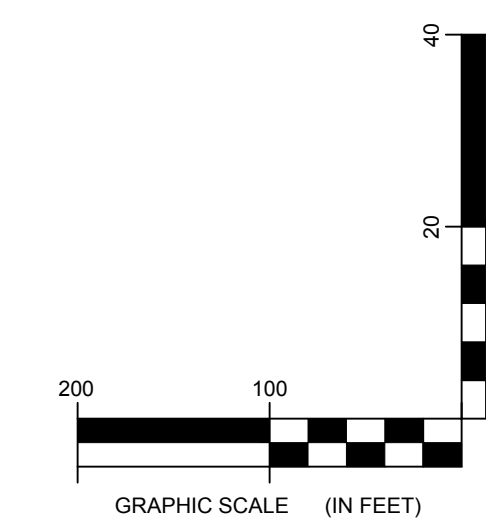

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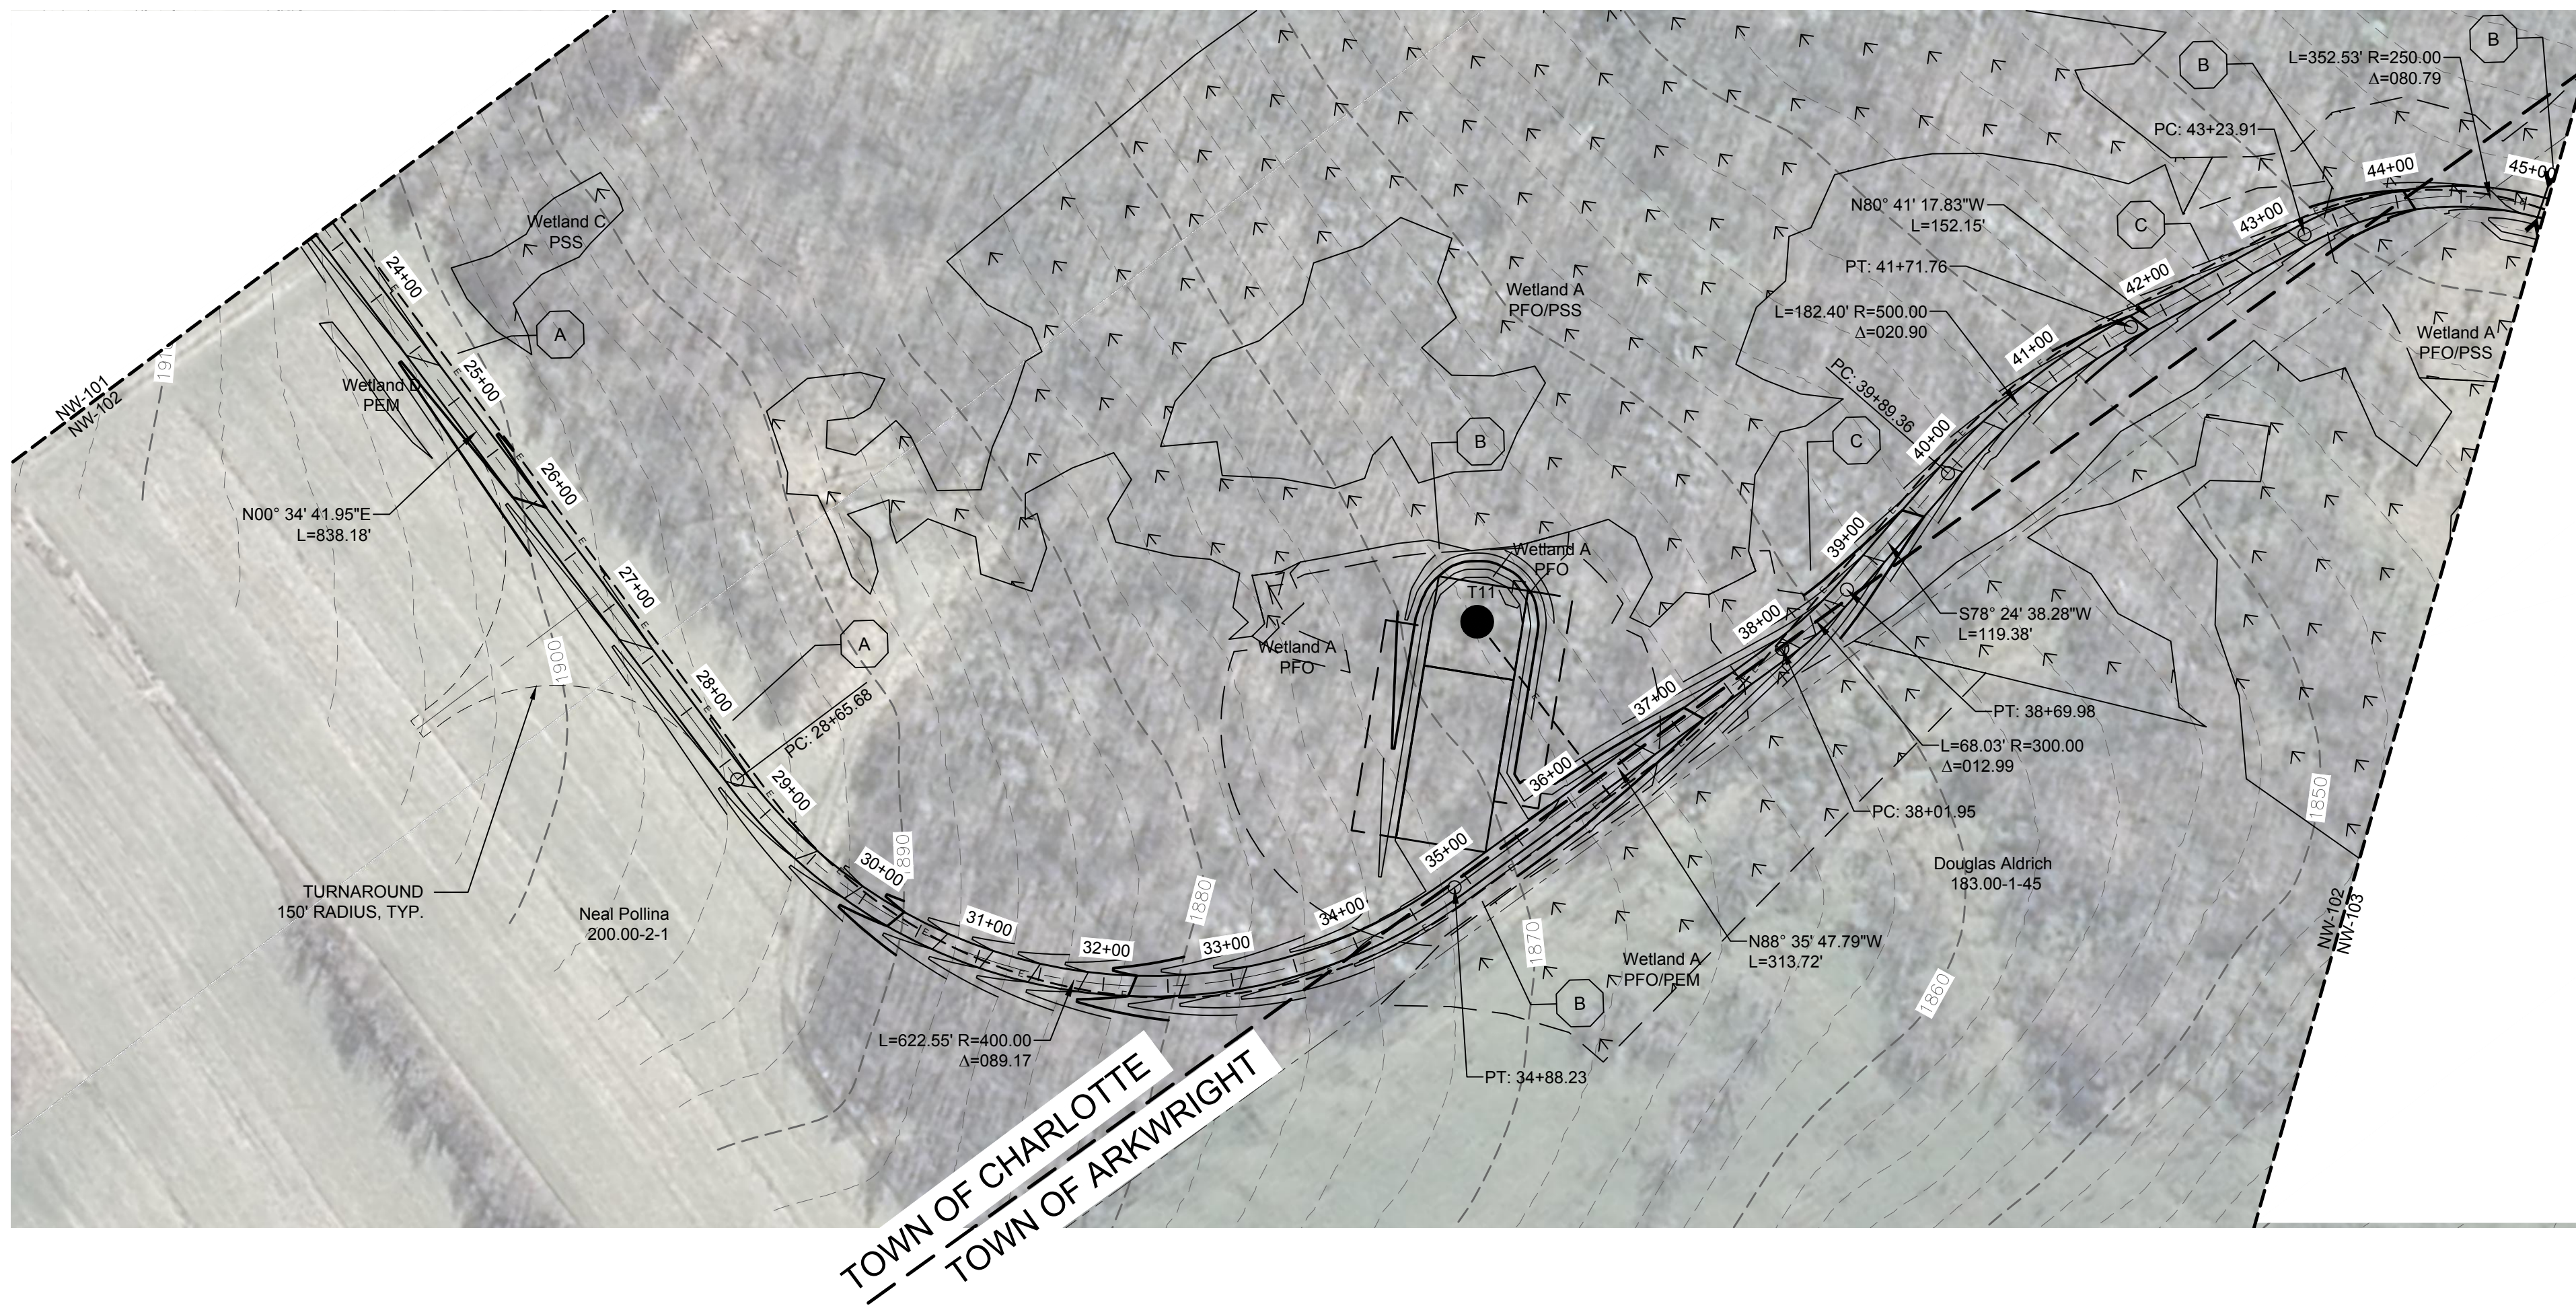


DRAWING REVISIONS	
NO.	DATE

PROJECT TITLE: CASSADAGA WIND PROJECT
TOWNS OF CHARLOTTE, CHERRY CREEK, ARKWRIGHT, AND STOCKTON
PROJECT LOCATION: CHAUTAUGUS COUNTY, NEW YORK
CLIENT: CASSADAGA WIND LLC
DRAWING TITLE: ACCESS ROAD PLAN AND PROFILE

DATE: APRIL 22, 2016
SCALE: AS NOTED
EDR JOB#: 14048
DRAWN BY: AW, CB, ZR
CHECKED BY: TD
FILE NAME: 14048_Working_NW.dwg
DRAWING NUMBER: NW-101






STORMWATER KEY NOTES	
ITEM	SYMBOL
VEGETATIVE FILTER STRIP	(A)
LEVEL SPREADER	(B)
DRY SWALE	(C)


NOTE: SEE SHEET C-605 FOR DETAILS

LEGEND	
ITEM	SYMBOL
DRAWING SHEET MATCH LINE	--- DRAWING NUMBER --- --- DRAWING NUMBER ---
WIND TURBINE DESIGNATION	T53
PARCEL BOUNDARY	---
115 KV OVERHEAD GENERATOR LEAD LINE	---
115 KV OVERHEAD GENERATOR LEAD LINE POLE	⊙
UNDERGROUND COLLECTION LINE	---
OVERHEAD COLLECTION LINE	---
EXISTING CONTOUR (2' INTERVAL)	---
EXISTING CONTOUR - INDEX (2' INTERVAL)	---
CONTOUR - FINISHED (2' INTERVAL)	---
CONTOUR - FINISHED - INDEX (2' INTERVAL)	---
ACCESS ROAD CENTERLINE	---
PERMANENT ACCESS ROAD EDGE	---
STORM PIPE / CULVERT	---
NYSDEC WETLAND	---
WETLAND BOUNDARY	---
STREAM BOUNDARY	---
APPROXIMATE WETLAND BOUNDARY	---
APPROXIMATE STREAM BOUNDARY	---
ENVIRONMENTALLY SENSITIVE AREA - RESTRICTED ACCESS	---
ENVIRONMENTALLY SENSITIVE AREA	---
WIND TURBINE CONSTRUCTION SITE	---
ROTOR LAYDOWN	---
WIND TURBINE	---
GRAVEL PAD	---
WORK AREA	---
CRANE PAD	---

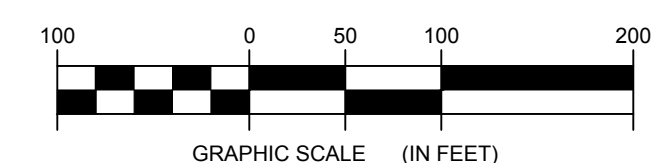


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**1 PLAN VIEW - TRUNK T7 ACCESS ROAD TO T3, T11 AND T7**  
Scale: 1"=100'

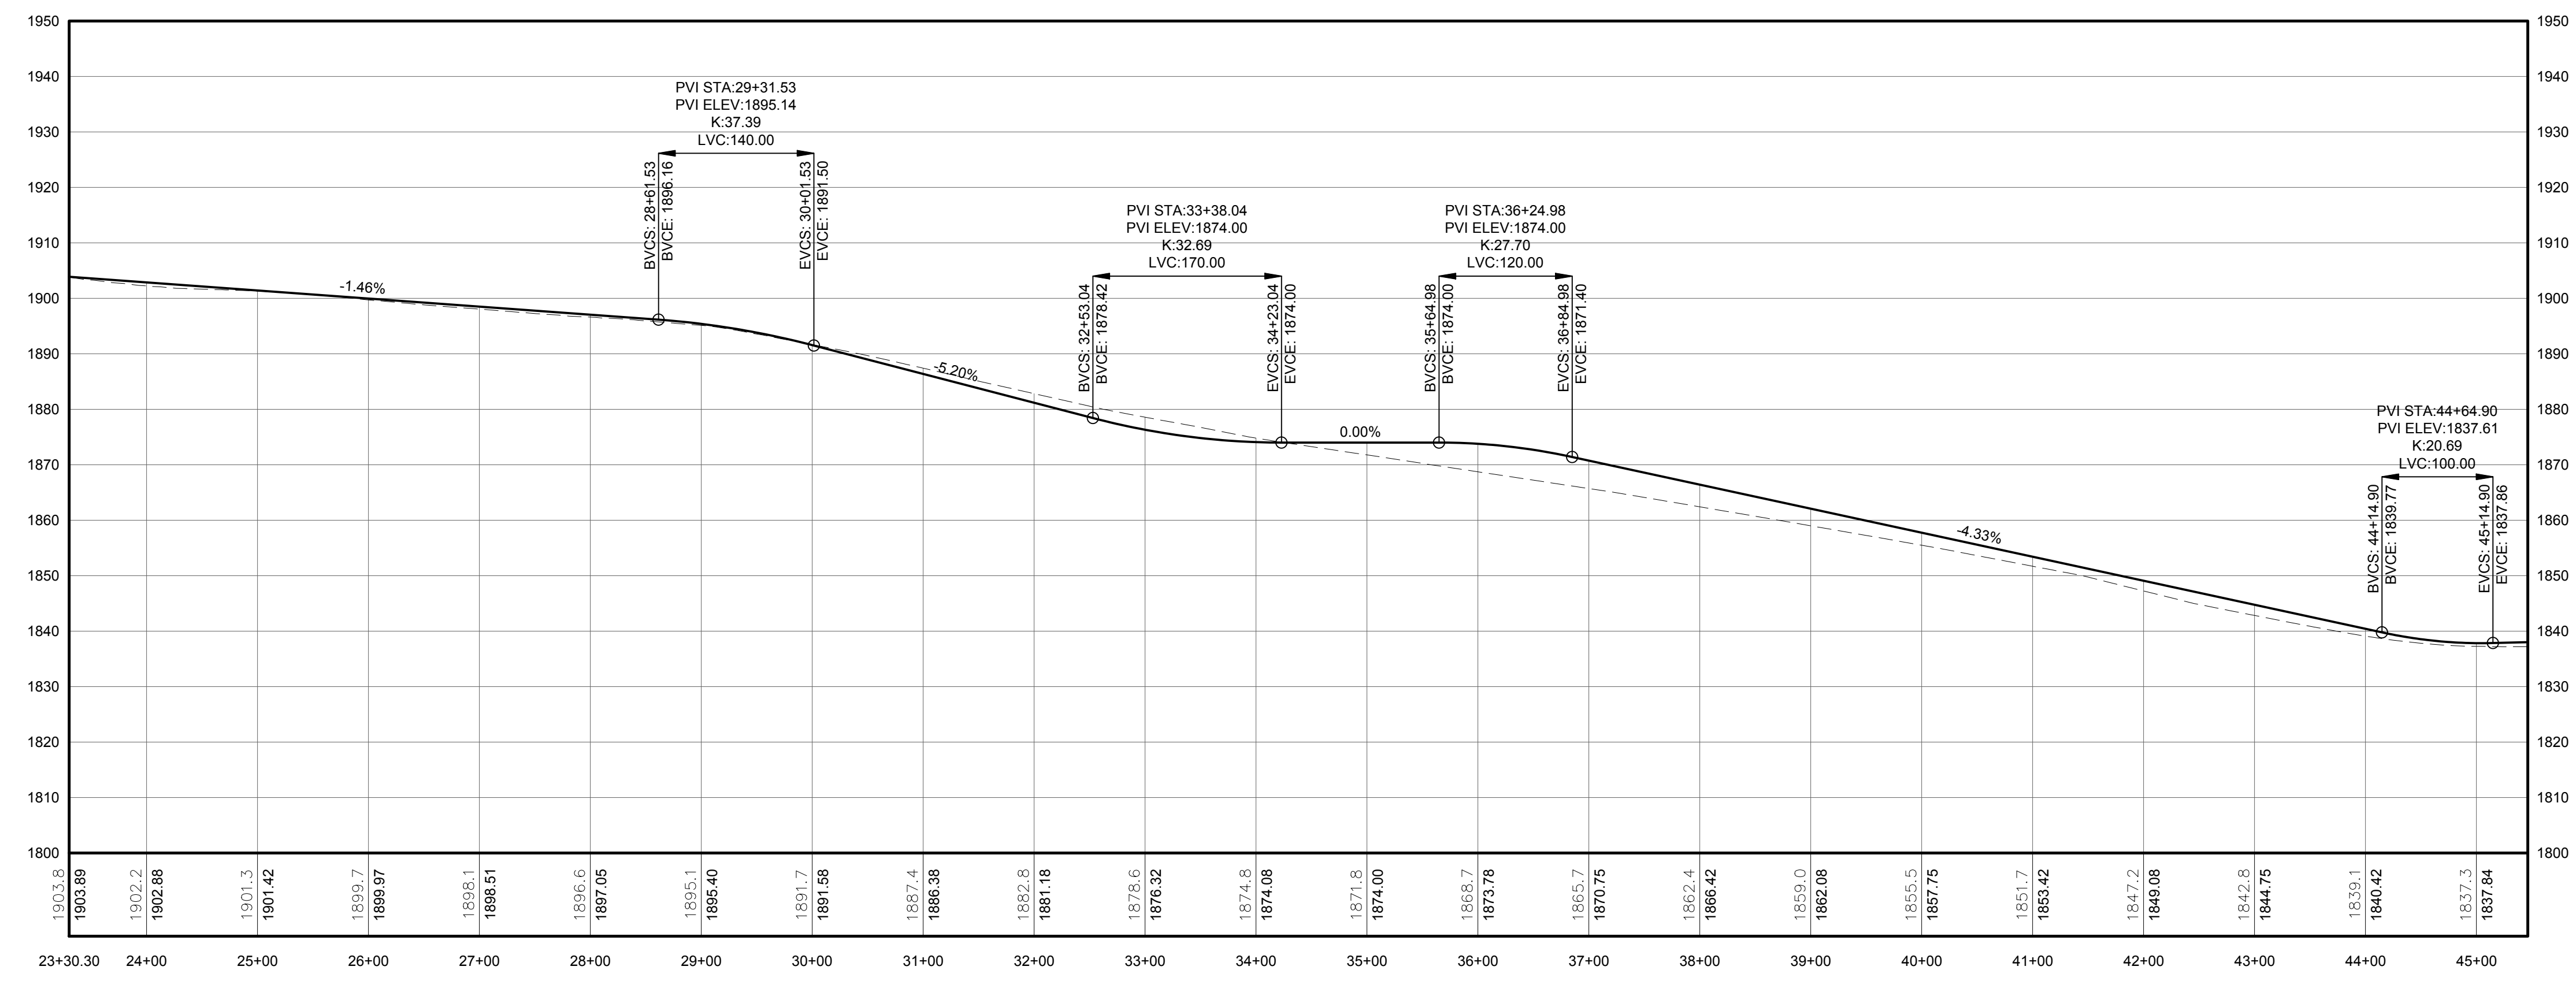


PROFILE LEGEND	
ITEM	SYMBOL
EXISTING ELEVATION (FT)	1845.3
PROPOSED ELEVATION (FT)	1845.27
EXISTING GRADE	---
PROPOSED GRADE	---

NOTE: ELEVATIONS IN USGS DATUM.

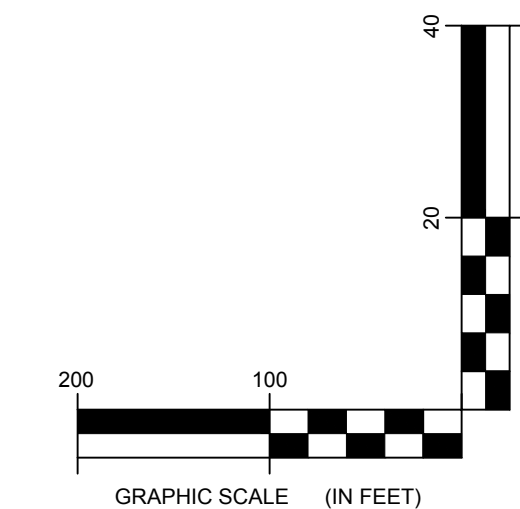

**2 ACCESS ROAD PROFILE**  
Scale: H:1"=100' V:1"=20'

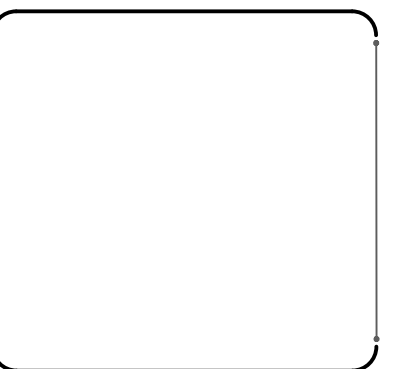


DRAWING REVISIONS	
NO.	DATE

PROJECT TITLE: <b>CASSADAGA WIND PROJECT</b>
TOWNS OF CHARLOTTE, CHERRY CREEK, ARKWRIGHT, AND STOCKTON
PROJECT LOCATION: CHAUTAUGUS COUNTY, NEW YORK
CLIENT: CASSADAGA WIND LLC
DRAWING TITLE: ACCESS ROAD PLAN AND PROFILE

DATE: <b>APRIL 22, 2016</b>
SCALE: <b>AS NOTED</b>
EDR JOB#: <b>14048</b>
DRAWN BY: <b>AW, CB, ZR</b>
CHECKED BY: <b>TD</b>
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DRAWING NUMBER: <b>NW-102</b>




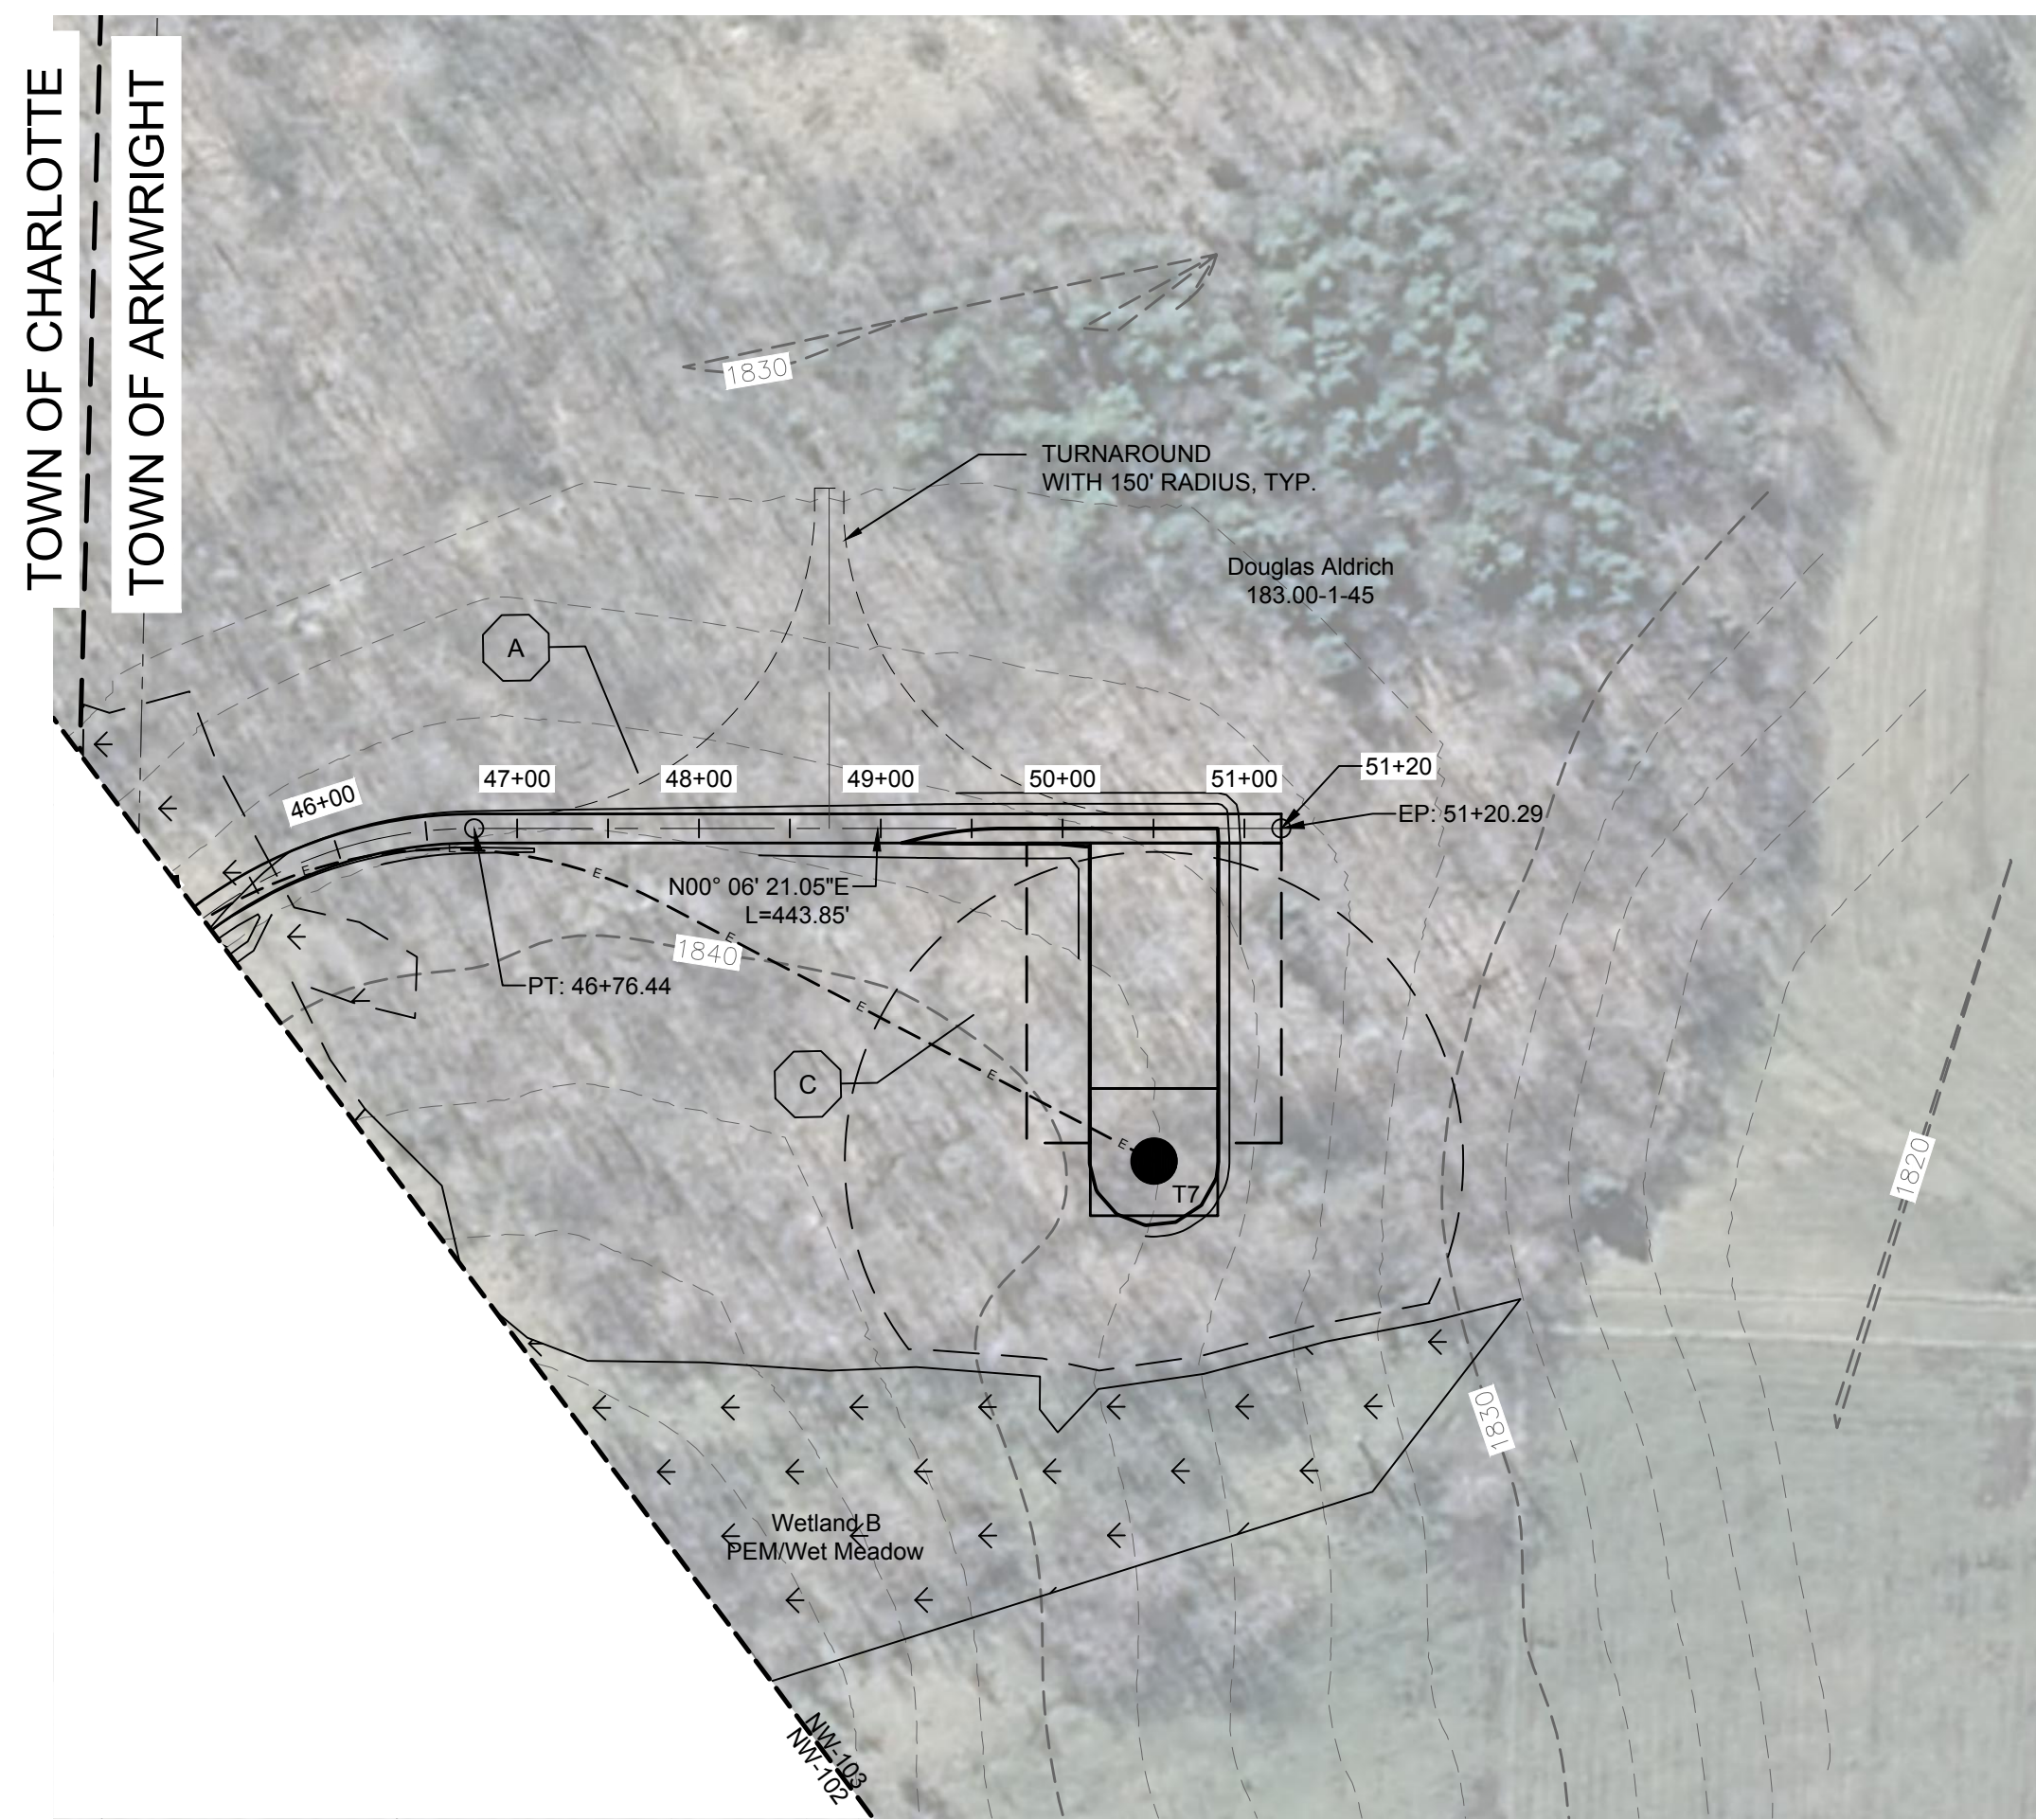

STORMWATER KEY NOTES	
ITEM	SYMBOL
VEGETATIVE FILTER STRIP	(A)
LEVEL SPREADER	(B)
DRY SWALE	(C)

NOTE: SEE SHEET C-605 FOR DETAILS

LEGEND	
ITEM	SYMBOL
DRAWING SHEET MATCH LINE	--- DRAWING NUMBER ---
WIND TURBINE DESIGNATION	T53
PARCEL BOUNDARY	---
115 KV OVERHEAD GENERATOR LEAD LINE	—115KV—
115 KV OVERHEAD GENERATOR LEAD LINE POLE	⊙
UNDERGROUND COLLECTION LINE	---
OVERHEAD COLLECTION LINE	---
EXISTING CONTOUR (2' INTERVAL)	---
EXISTING CONTOUR - INDEX (2' INTERVAL)	---
CONTOUR - FINISHED (2' INTERVAL)	---
CONTOUR - FINISHED - INDEX (2' INTERVAL)	---
ACCESS ROAD CENTERLINE	---
PERMANENT ACCESS ROAD EDGE	---
STORM PIPE / CULVERT	--->---
NYSDEC WETLAND	[Pattern]
WETLAND BOUNDARY	↓ ↓ ↓
STREAM BOUNDARY	[Pattern]
APPROXIMATE WETLAND BOUNDARY	↓ ↓ ↓
APPROXIMATE STREAM BOUNDARY	[Pattern]
ENVIRONMENTALLY SENSITIVE AREA - RESTRICTED ACCESS	[Pattern]
ENVIRONMENTALLY SENSITIVE AREA	[Pattern]
WIND TURBINE CONSTRUCTION SITE	[Diagram]
ROTOR LAYDOWN	[Diagram]
WIND TURBINE	[Diagram]
GRAVEL PAD	[Diagram]
WORK AREA	[Diagram]
CRANE PAD	[Diagram]


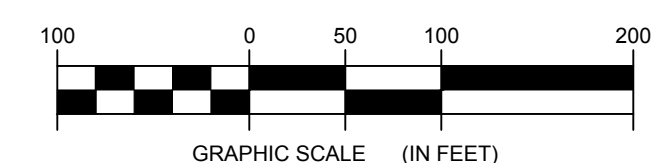


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PROFILE LEGEND	
ITEM	SYMBOL
EXISTING ELEVATION (FT)	1845.3
PROPOSED ELEVATION (FT)	1845.27
EXISTING GRADE	---
PROPOSED GRADE	---

NOTE: ELEVATIONS IN USGS DATUM.

**1 PLAN VIEW - TRUNK T7 ACCESS ROAD TO TURBINES T3, T11 AND T7**  
Scale: 1"=100'

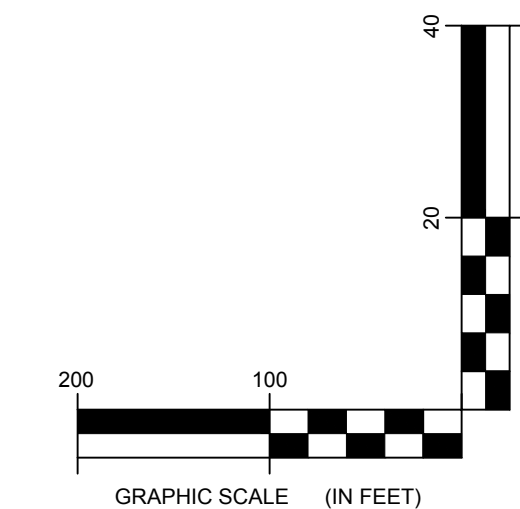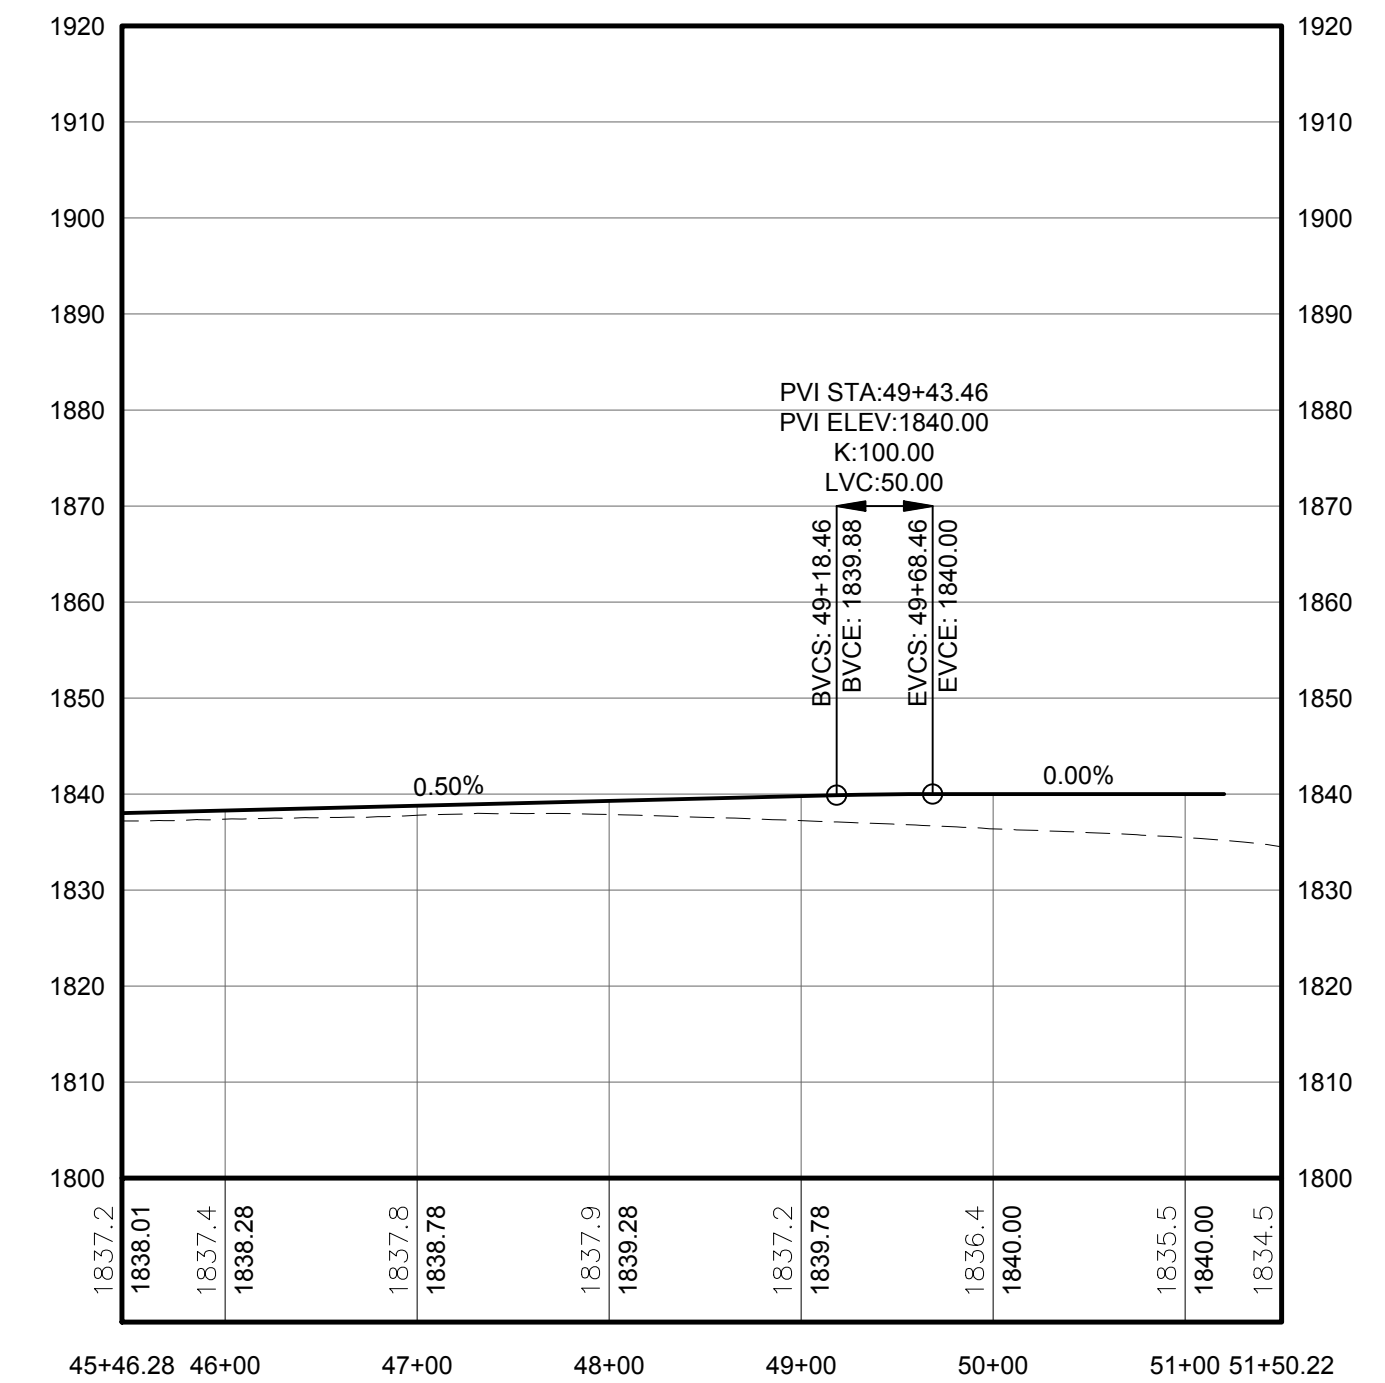

**2 ACCESS ROAD PROFILE**  
Scale: H:1"=100' V:1"=20'



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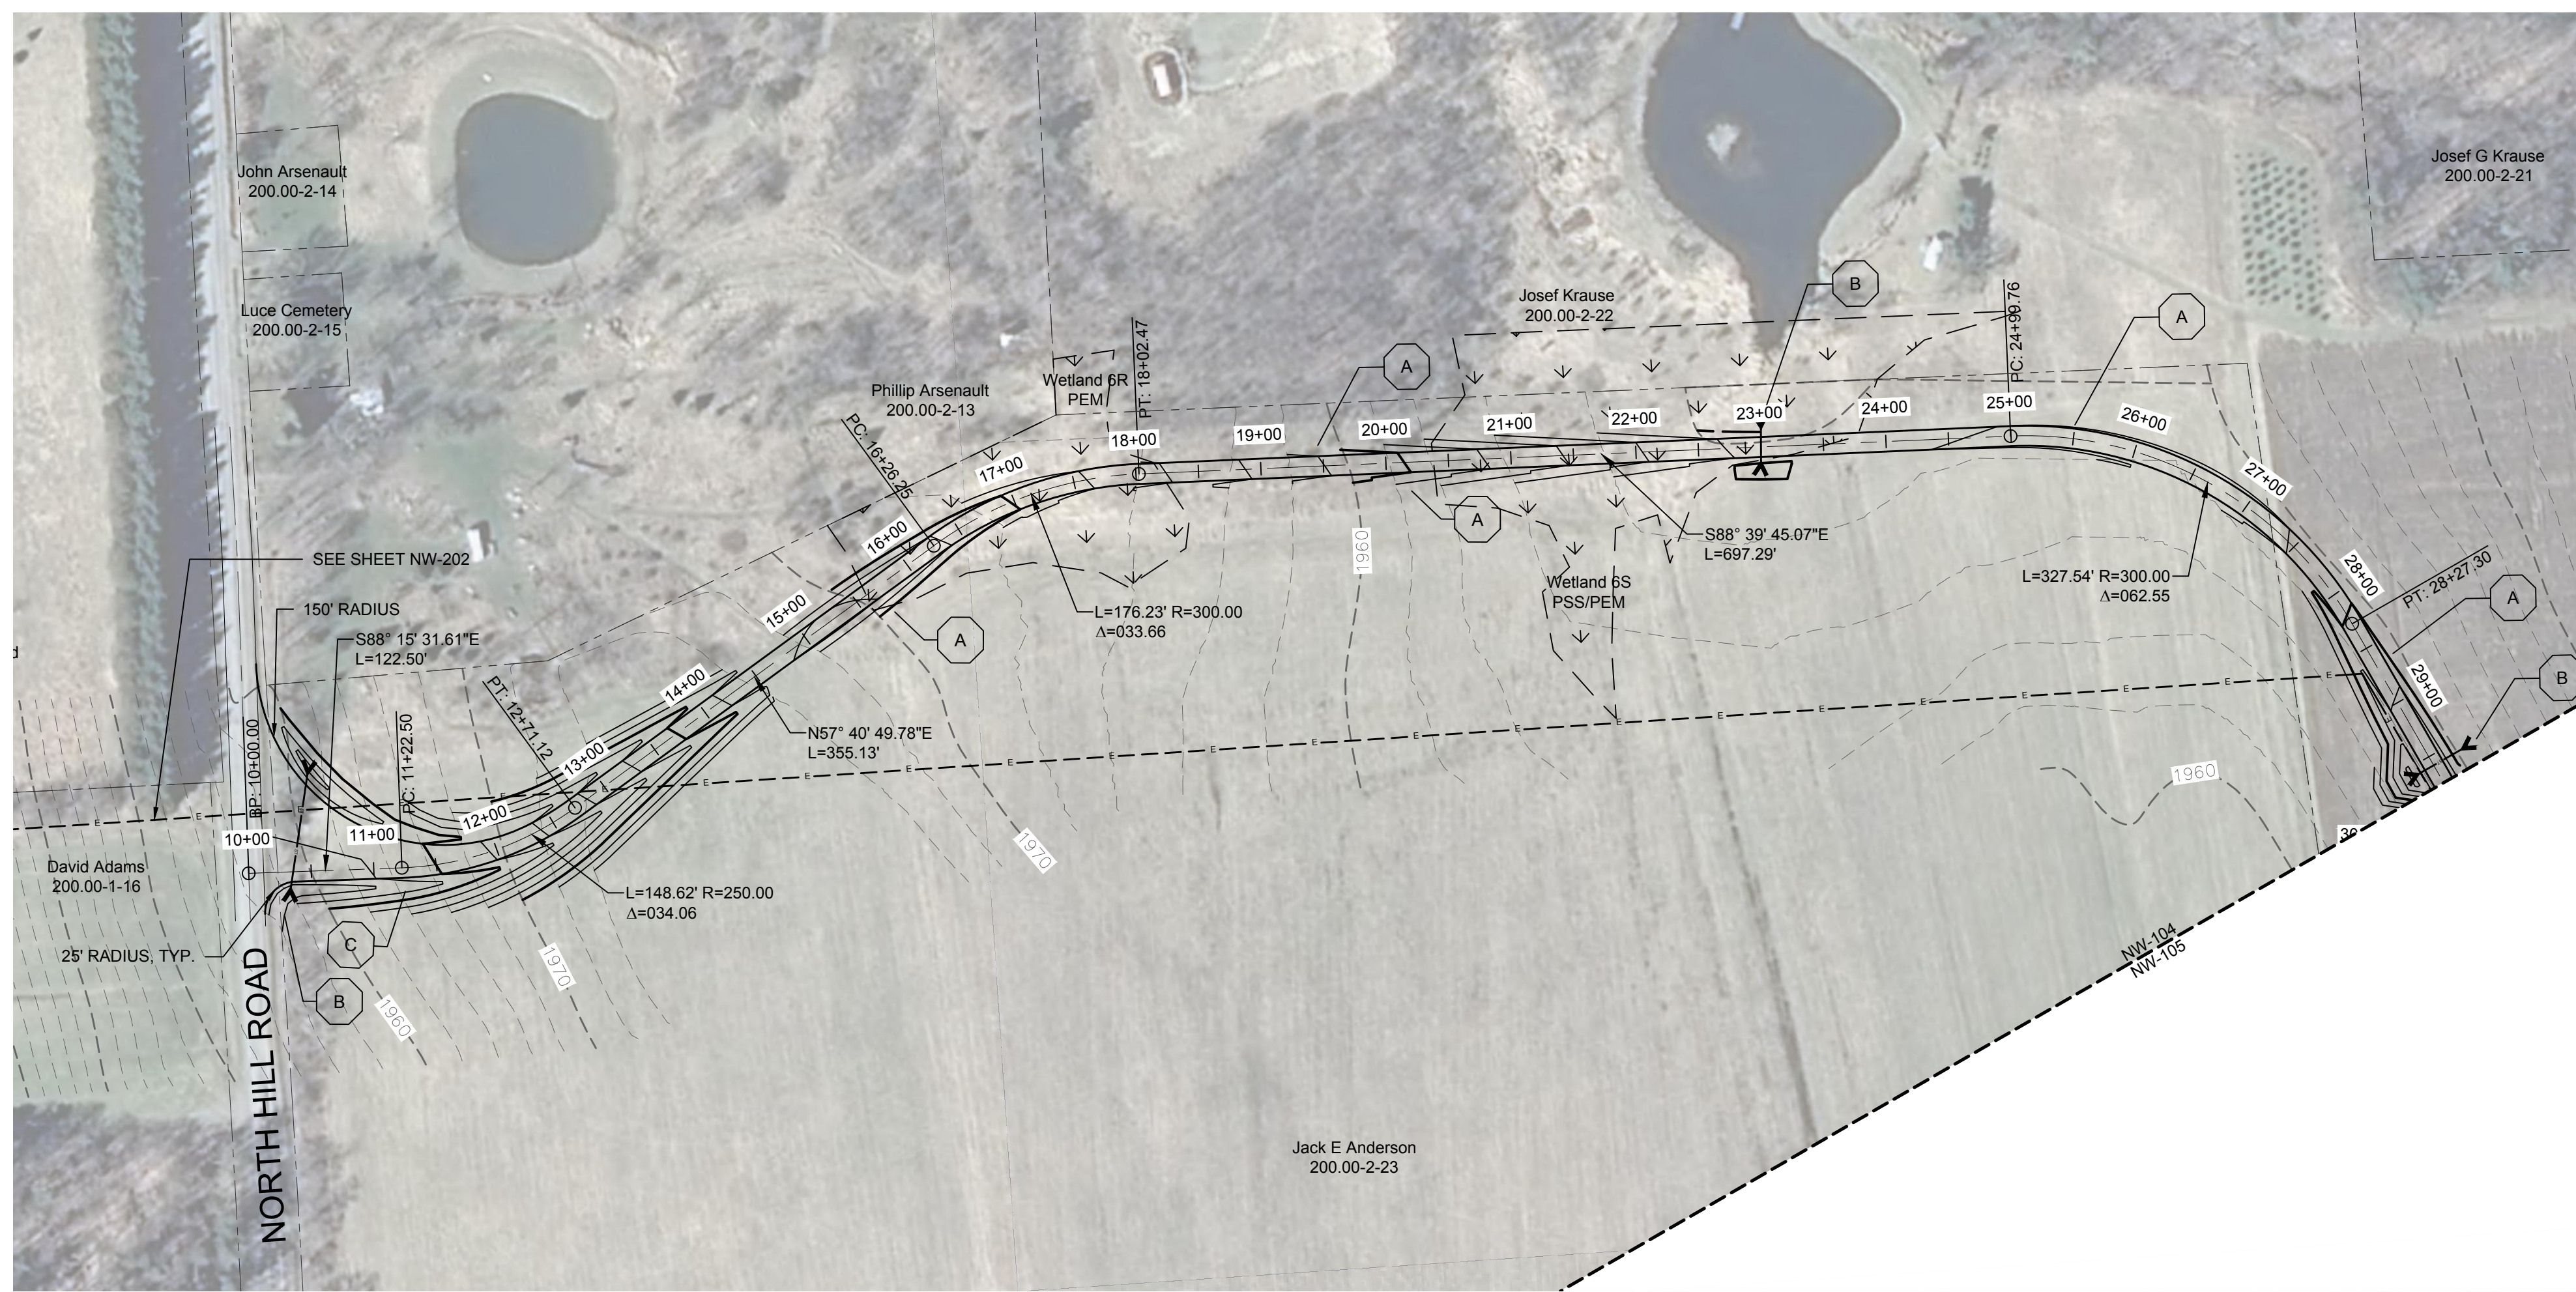
DRAWING REVISIONS	
NO.	DATE

PROJECT TITLE:	<b>CASSADAGA WIND PROJECT</b>
TOWNS OF CHARLOTTE, CHERRY CREEK, ARKWRIGHT, AND STOCKTON	
PROJECT LOCATION:	CHAUTAUGUS COUNTY, NEW YORK
CLIENT:	CASSADAGA WIND LLC
DRAWING TITLE:	ACCESS ROAD PLAN AND PROFILE

DATE:	APRIL 22, 2016
SCALE:	AS NOTED
edr JOB#: 14048	
DRAWN BY:	AW, CB, ZR
CHECKED BY:	TD
FILE NAME:	14048_Working_NW.dwg
DRAWING NUMBER:	<b>NW-103</b>

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STORMWATER KEY NOTES	
ITEM	SYMBOL
VEGETATIVE FILTER STRIP	(A)
LEVEL SPREADER	(B)
DRY SWALE	(C)

NOTE: SEE SHEET C-605 FOR DETAILS

LEGEND	
ITEM	SYMBOL
DRAWING SHEET MATCH LINE	--- DRAWING NUMBER ---
WIND TURBINE DESIGNATION	T53
PARCEL BOUNDARY	---
115 KV OVERHEAD GENERATOR LEAD LINE	---
115 KV OVERHEAD GENERATOR LEAD LINE POLE	⊙
UNDERGROUND COLLECTION LINE	---
OVERHEAD COLLECTION LINE	---
EXISTING CONTOUR (2' INTERVAL)	---
EXISTING CONTOUR - INDEX (2' INTERVAL)	---
CONTOUR - FINISHED (2' INTERVAL)	---
CONTOUR - FINISHED - INDEX (2' INTERVAL)	---
ACCESS ROAD CENTERLINE	---
PERMANENT ACCESS ROAD EDGE	---
STORM PIPE / CULVERT	---
NYSDEC WETLAND	---
WETLAND BOUNDARY	---
STREAM BOUNDARY	---
APPROXIMATE WETLAND BOUNDARY	---
APPROXIMATE STREAM BOUNDARY	---
ENVIRONMENTALLY SENSITIVE AREA - RESTRICTED ACCESS	---
ENVIRONMENTALLY SENSITIVE AREA	---
WIND TURBINE CONSTRUCTION SITE	---
ROTOR LAYDOWN	---
WIND TURBINE	---
GRAVEL PAD	---
WORK AREA	---
CRANE PAD	---



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**1** PLAN VIEW - TRUNK T36 ACCESS ROAD TO TURBINES T19, T20, T21, AND T36  
 104 Scale: 1"=100'

PROFILE LEGEND	
ITEM	SYMBOL
EXISTING ELEVATION (FT)	1845.3
PROPOSED ELEVATION (FT)	1845.27
EXISTING GRADE	---
PROPOSED GRADE	---

NOTE: ELEVATIONS IN USGS DATUM.

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**2** ACCESS ROAD PROFILE  
 104 Scale: H: 1"=100' V: 1"=20'

DRAWING REVISIONS	
NO.	DATE

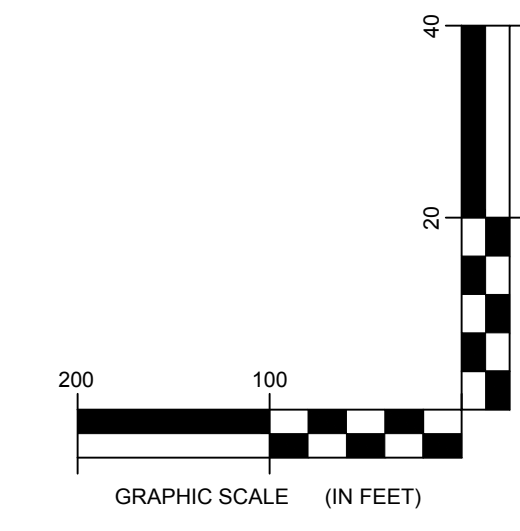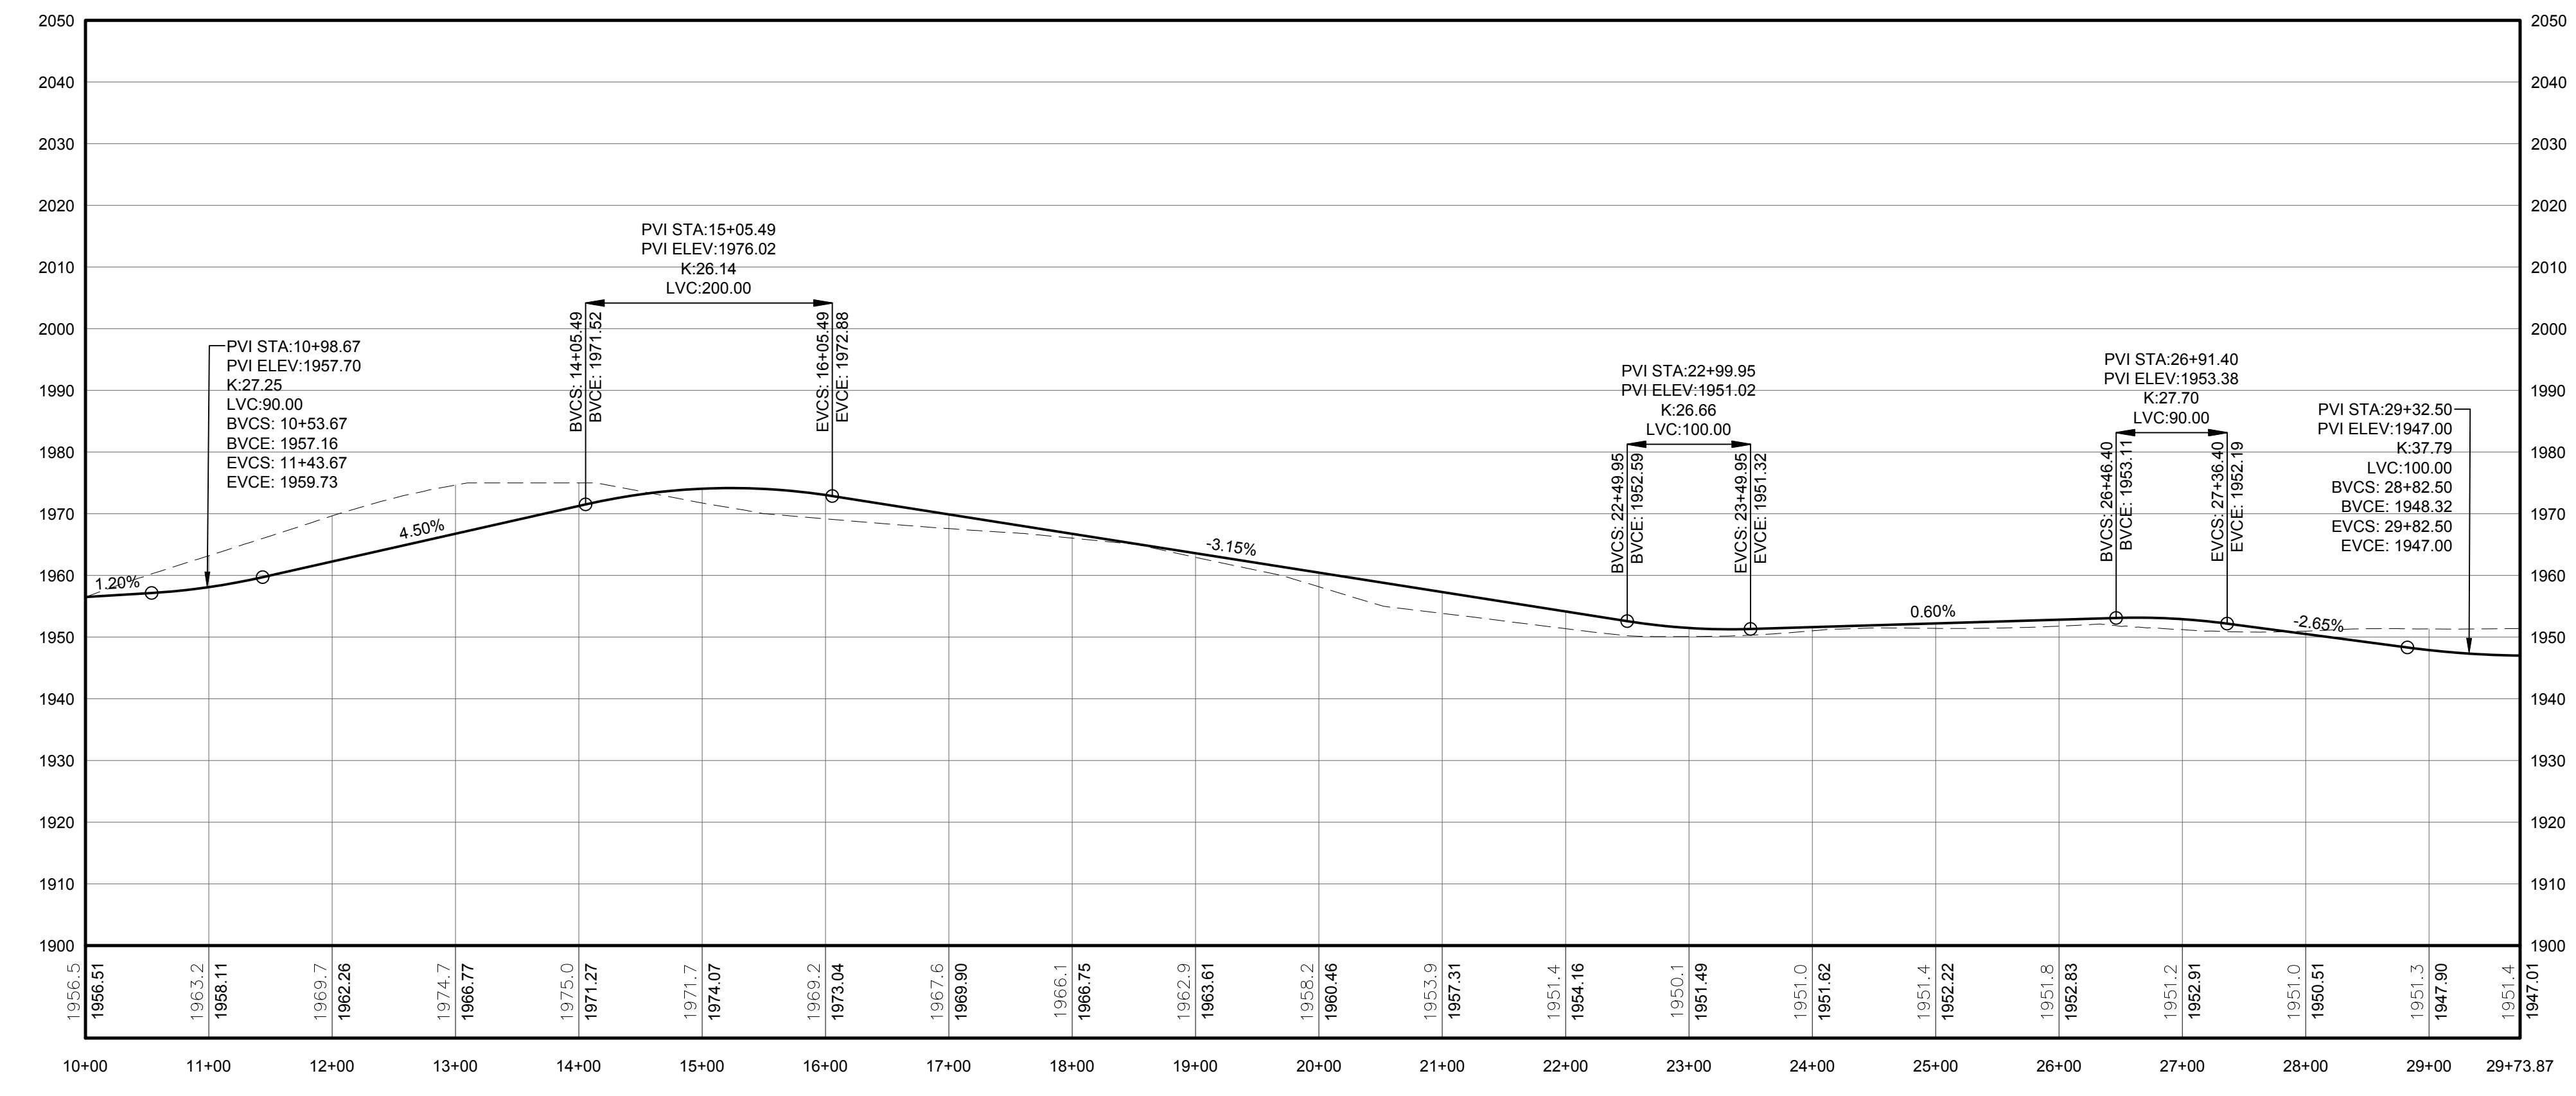**PROJECT TITLE: CASSADAGA WIND PROJECT**  
**TOWNS OF CHARLOTTE, CHERRY CREEK, ARKWRIGHT, AND STOCKTON**  
**PROJECT LOCATION: CHAUTAUGUS COUNTY, NEW YORK**  
**CLIENT: CASSADAGA WIND LLC**  
**DRAWING TITLE: ACCESS ROAD PLAN AND PROFILE**


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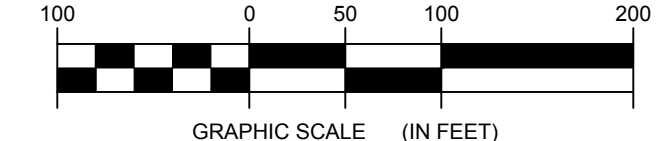
STORMWATER KEY NOTES	
ITEM	SYMBOL
VEGETATIVE FILTER STRIP	(A)
LEVEL SPREADER	(B)
DRY SWALE	(C)

NOTE: SEE SHEET C-605 FOR DETAILS


LEGEND	
ITEM	SYMBOL
DRAWING SHEET MATCH LINE	--- DRAWING NUMBER --- DRAWING NUMBER
WIND TURBINE DESIGNATION	T53
PARCEL BOUNDARY	---
115 KV OVERHEAD GENERATOR LEAD LINE	---
115 KV OVERHEAD GENERATOR LEAD LINE POLE	⊙
UNDERGROUND COLLECTION LINE	---
OVERHEAD COLLECTION LINE	---
EXISTING CONTOUR (2' INTERVAL)	---
EXISTING CONTOUR - INDEX (2' INTERVAL)	---
CONTOUR - FINISHED (2' INTERVAL)	---
CONTOUR - FINISHED - INDEX (2' INTERVAL)	---
ACCESS ROAD CENTERLINE	---
PERMANENT ACCESS ROAD EDGE	---
STORM PIPE / CULVERT	---
NYSDEC WETLAND	---
WETLAND BOUNDARY	---
STREAM BOUNDARY	---
APPROXIMATE WETLAND BOUNDARY	---
APPROXIMATE STREAM BOUNDARY	---
ENVIRONMENTALLY SENSITIVE AREA - RESTRICTED ACCESS	---
ENVIRONMENTALLY SENSITIVE AREA	---
WIND TURBINE CONSTRUCTION SITE	---
ROTOR LAYDOWN	---
WIND TURBINE	---
GRAVEL PAD	---
WORK AREA	---
CRANE PAD	---



1 PLAN VIEW - TRUNK T36 ACCESS ROAD TO TURBINES T20, T19, T21, AND T36  
105 Scale: 1"=100'

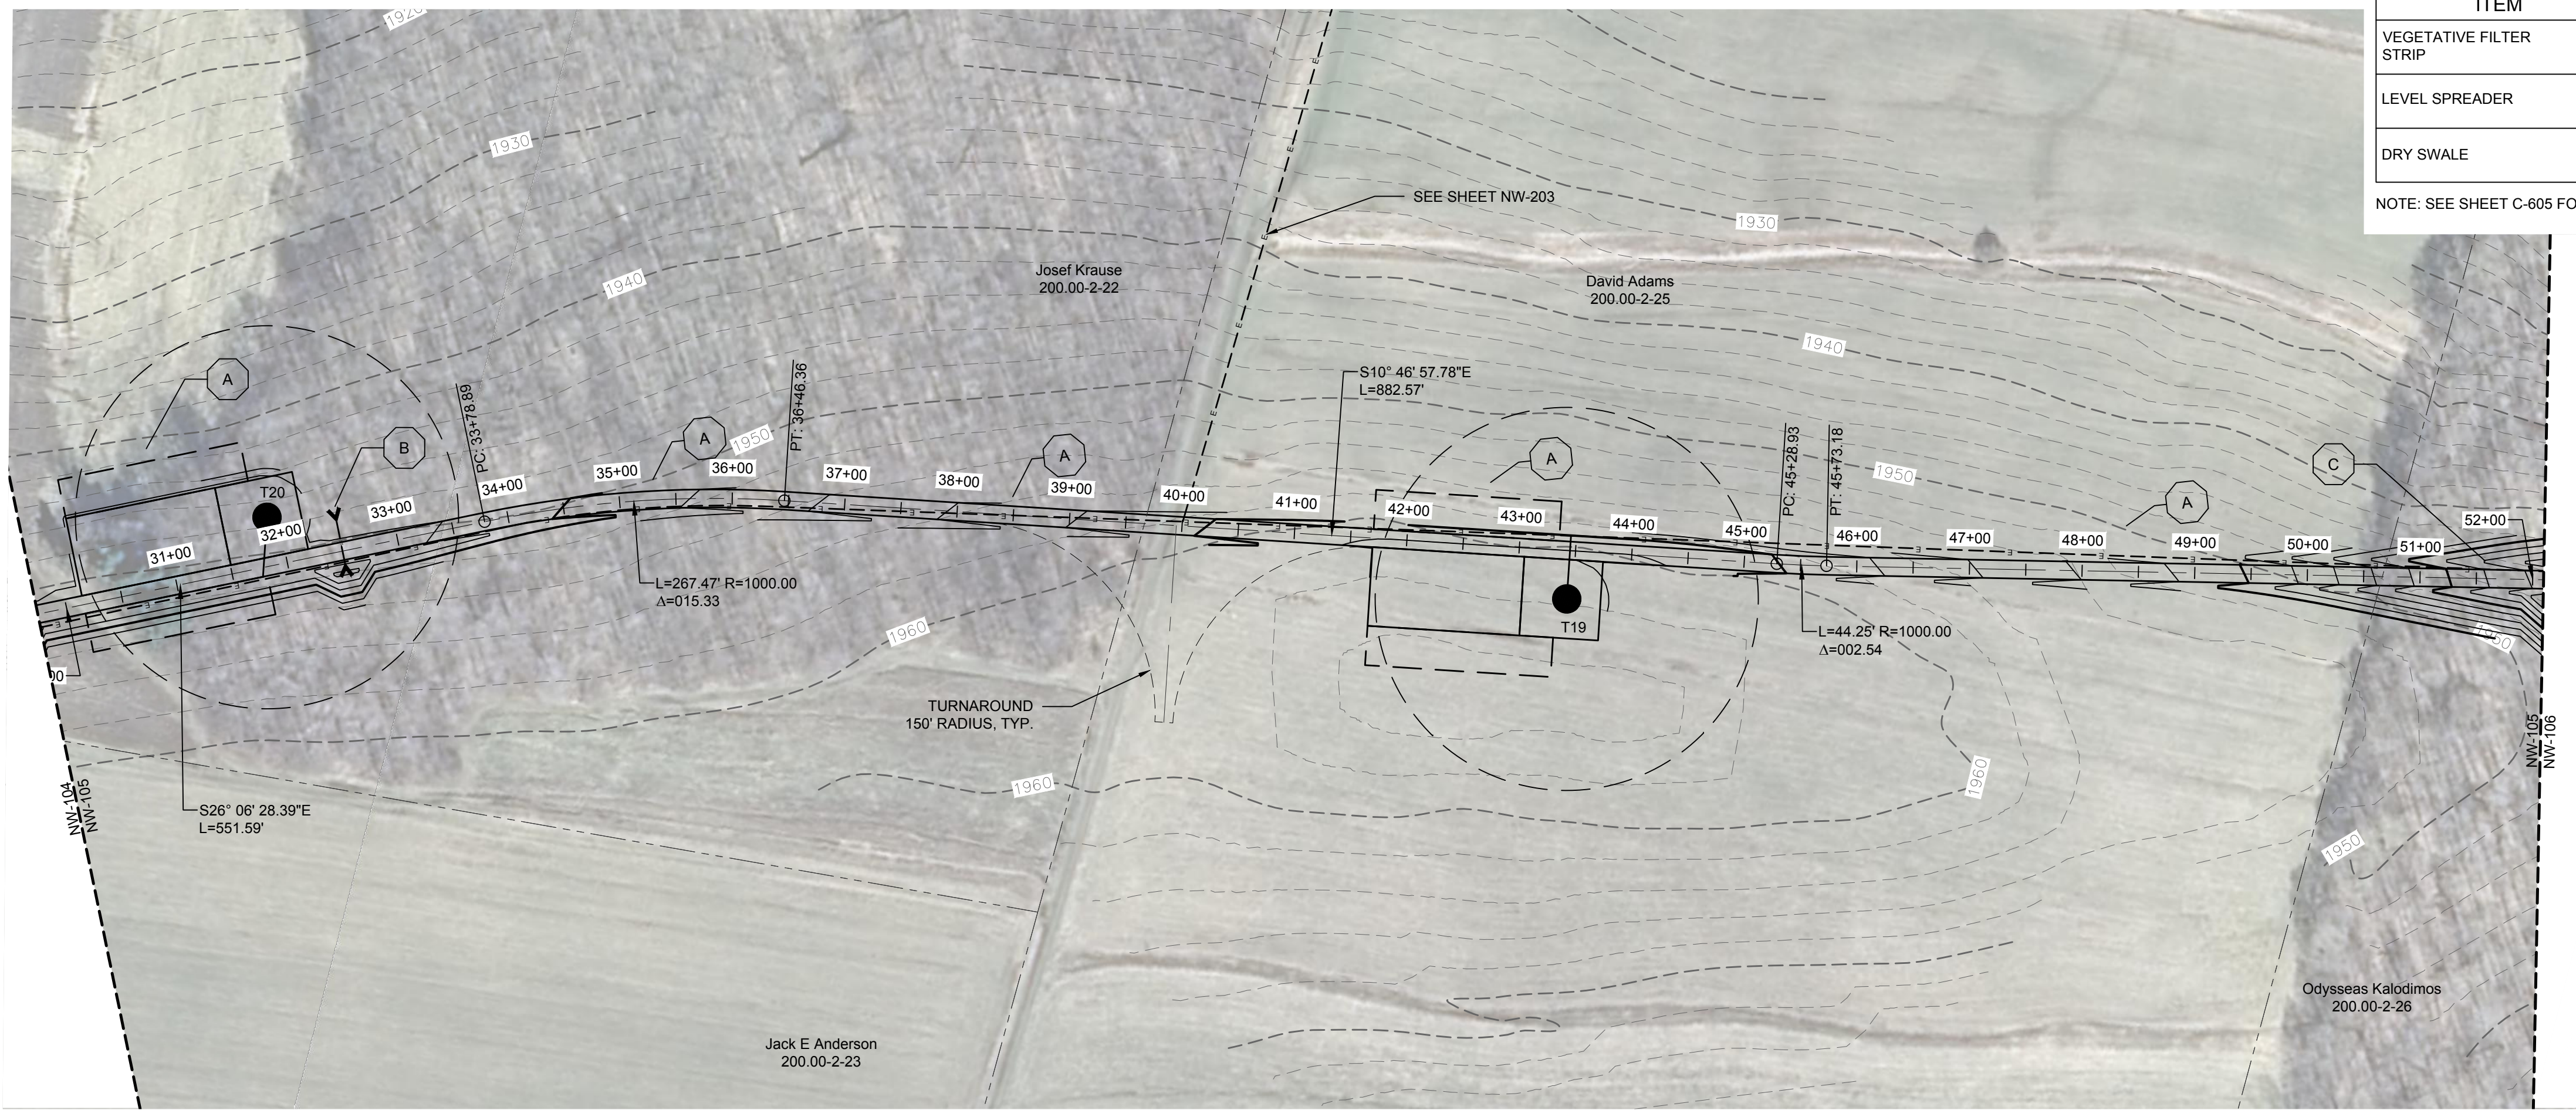


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PROFILE LEGEND	
ITEM	SYMBOL
EXISTING ELEVATION (FT)	1845.3
PROPOSED ELEVATION (FT)	1845.27
EXISTING GRADE	---
PROPOSED GRADE	---

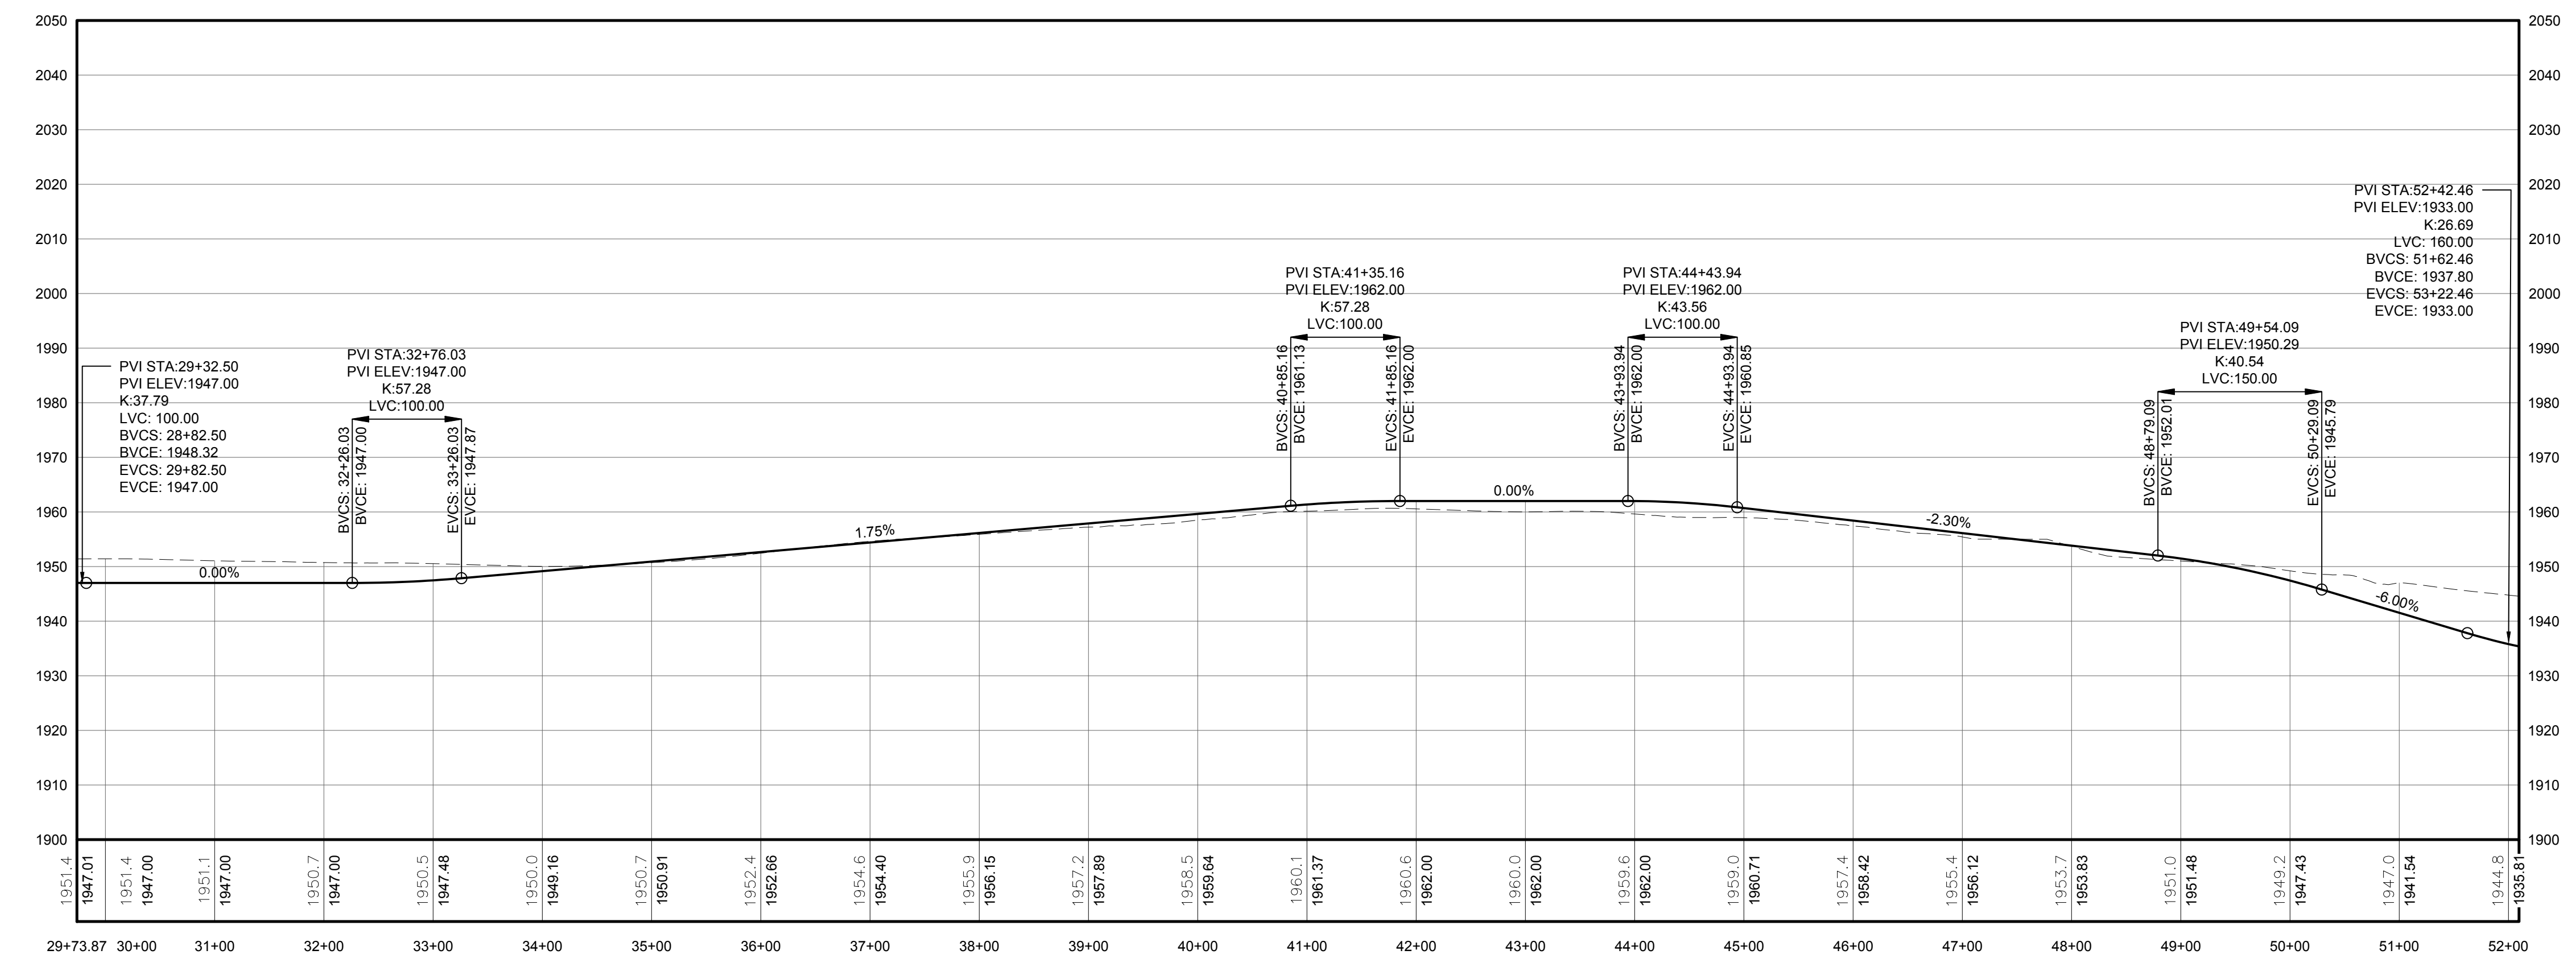NOTE: ELEVATIONS IN USGS DATUM.




2 ACCESS ROAD PROFILE  
105 Scale: H:1"=100' V:1"=20'

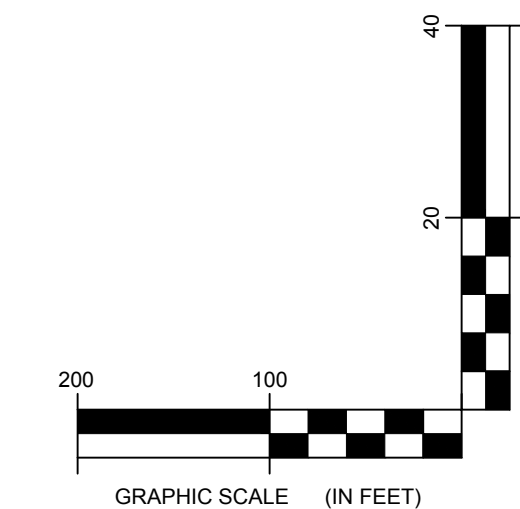DRAWING REVISIONS	
NO.	DATE
1	
2	
3	
4	
5	

PROJECT TITLE: **CASSADAGA WIND PROJECT**  
 TOWNS OF CHARLOTTE, CHERRY CREEK, ARKWRIGHT, AND STOCKTON  
 PROJECT LOCATION: CHAUTAUGUS COUNTY, NEW YORK  
 CLIENT: CASSADAGA WIND LLC  
 DRAWING TITLE: ACCESS ROAD PLAN AND PROFILE

DATE:	APRIL 22, 2016
SCALE:	AS NOTED
EDR JOB#: 14048	
DRAWN BY:	AW, CB, ZR
CHECKED BY:	TD
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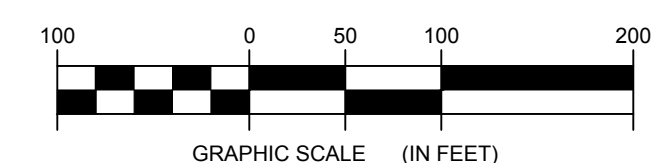


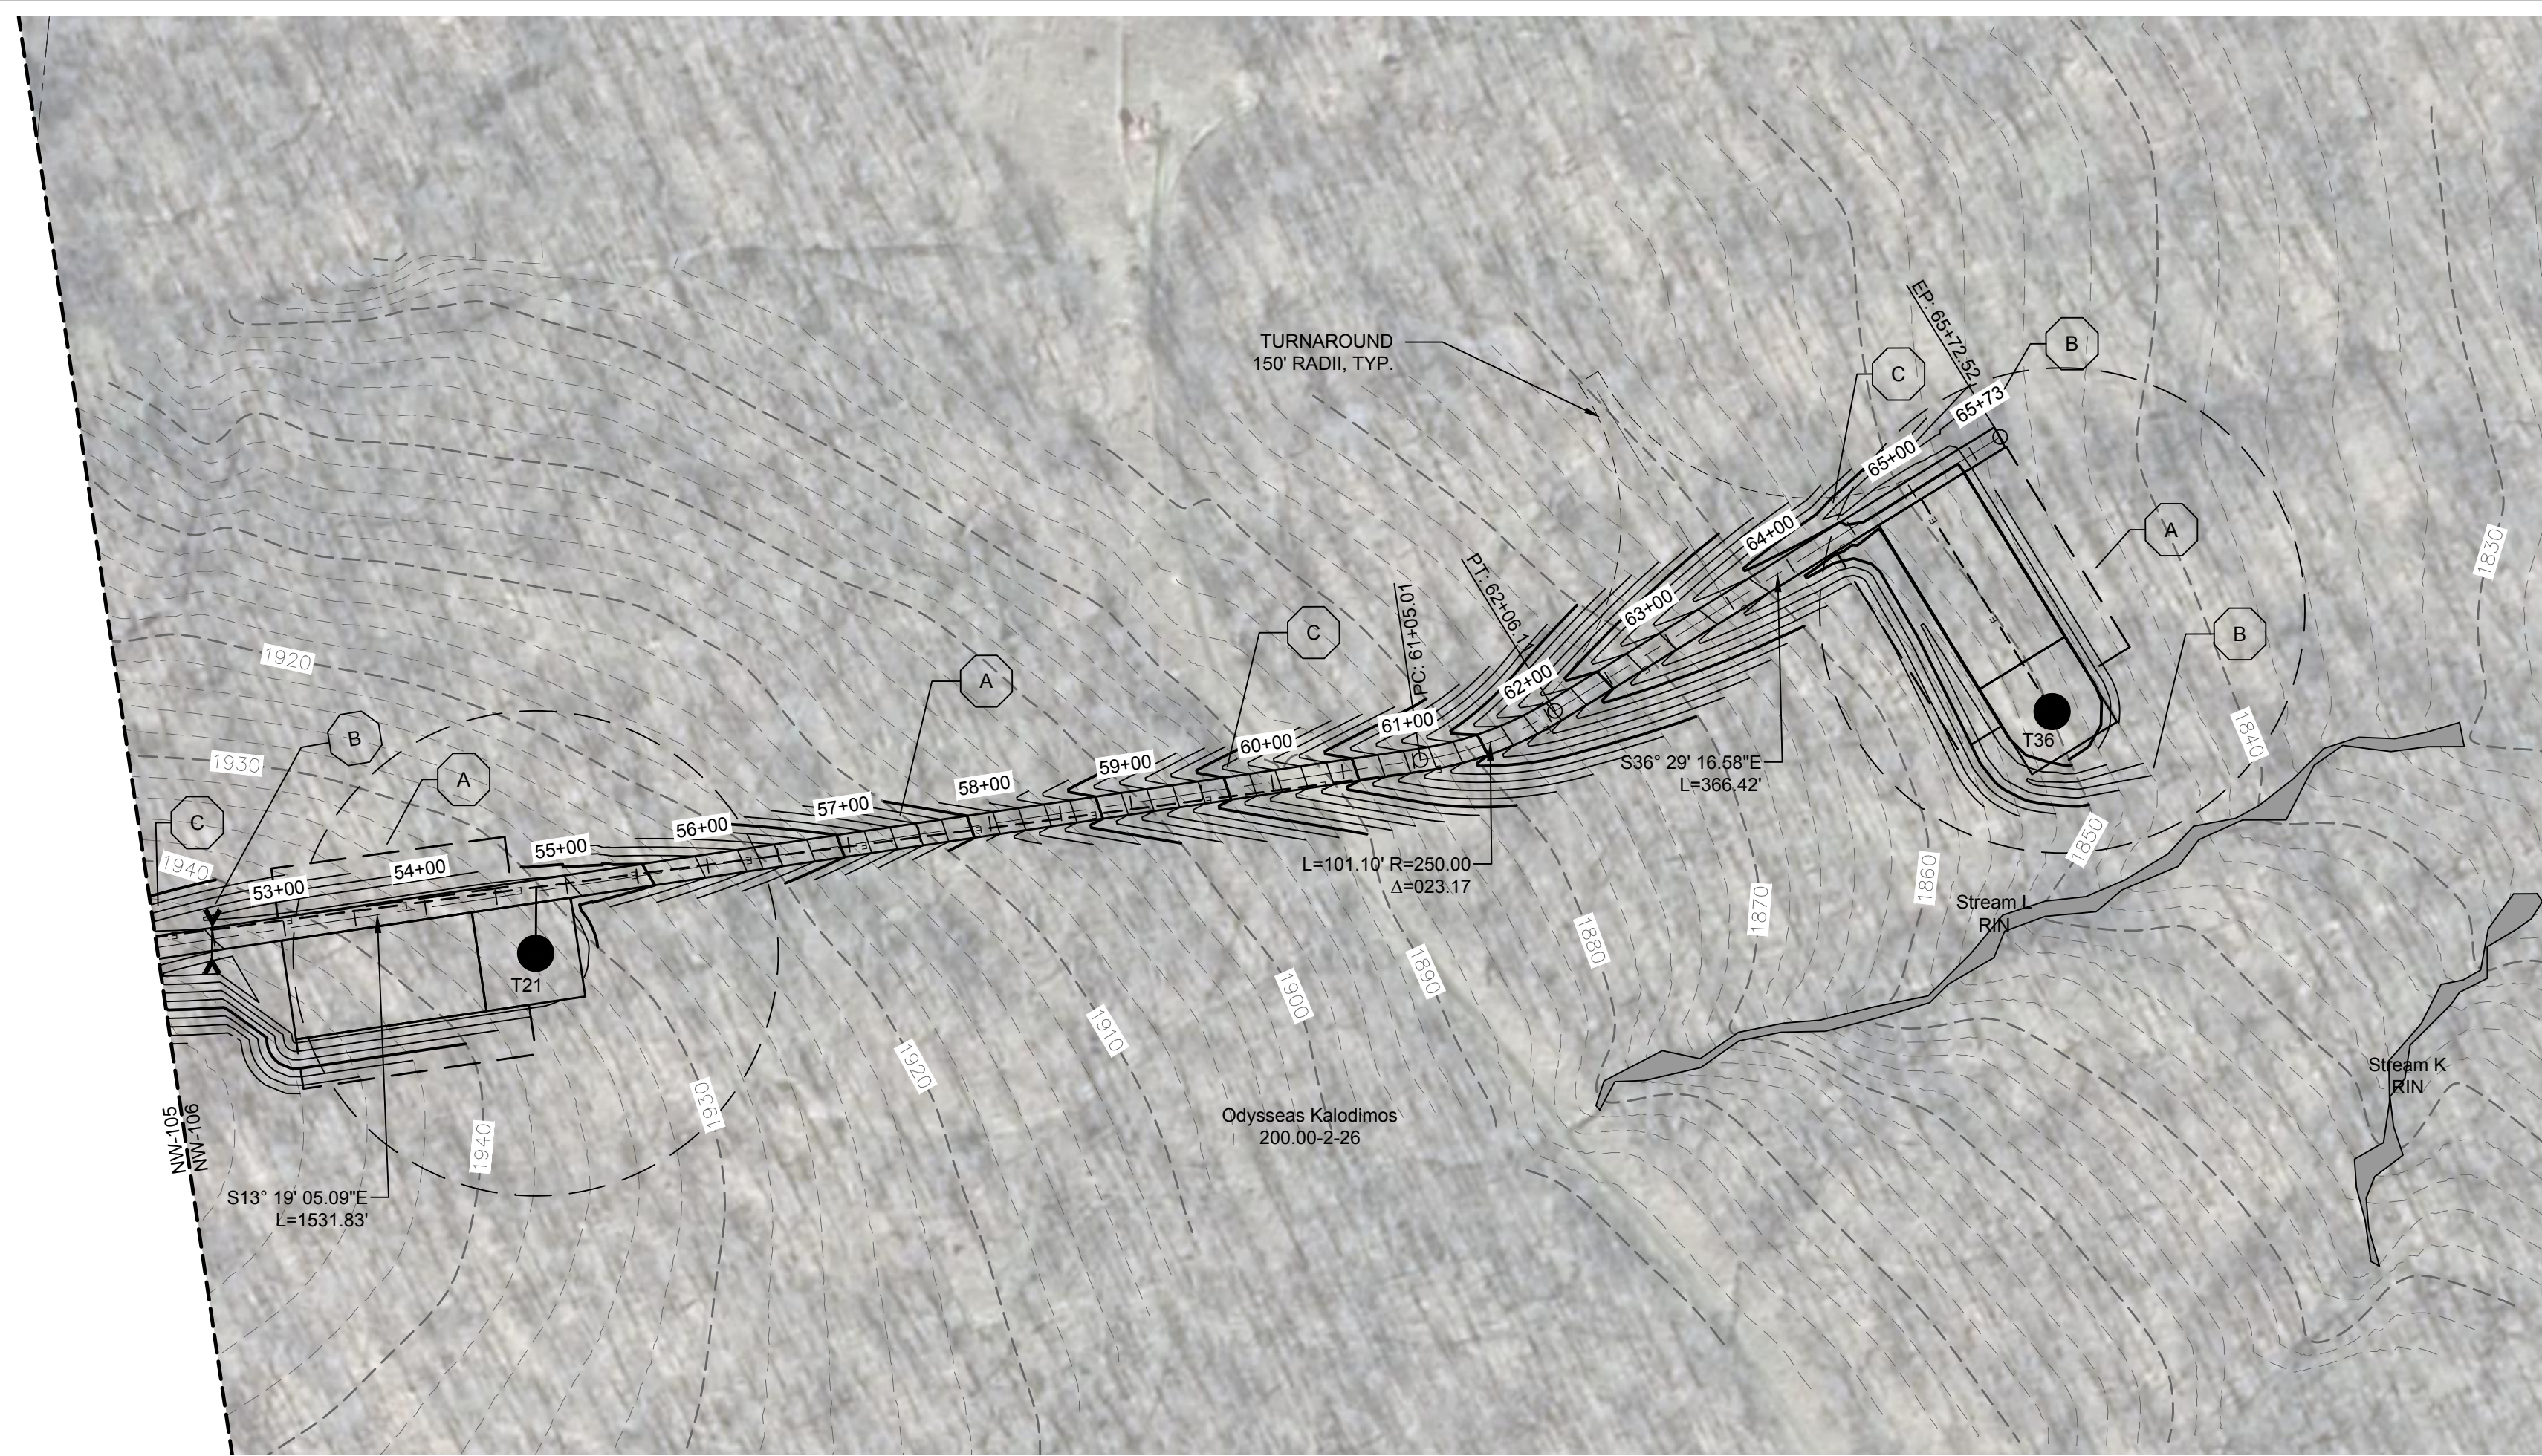

STORMWATER KEY NOTES	
ITEM	SYMBOL
VEGETATIVE FILTER STRIP	(A)
LEVEL SPREADER	(B)
DRY SWALE	(C)

NOTE: SEE SHEET C-605 FOR DETAILS


LEGEND	
ITEM	SYMBOL
DRAWING SHEET MATCH LINE	--- DRAWING NUMBER ---
WIND TURBINE DESIGNATION	T53
PARCEL BOUNDARY	---
115 KV OVERHEAD GENERATOR LEAD LINE	---
115 KV OVERHEAD GENERATOR LEAD LINE POLE	⊙
UNDERGROUND COLLECTION LINE	---
OVERHEAD COLLECTION LINE	---
EXISTING CONTOUR (2' INTERVAL)	---
EXISTING CONTOUR - INDEX (2' INTERVAL)	---
CONTOUR - FINISHED (2' INTERVAL)	---
CONTOUR - FINISHED - INDEX (2' INTERVAL)	---
ACCESS ROAD CENTERLINE	---
PERMANENT ACCESS ROAD EDGE	---
STORM PIPE / CULVERT	---
NYSDEC WETLAND	---
WETLAND BOUNDARY	---
STREAM BOUNDARY	---
APPROXIMATE WETLAND BOUNDARY	---
APPROXIMATE STREAM BOUNDARY	---
ENVIRONMENTALLY SENSITIVE AREA - RESTRICTED ACCESS	---
ENVIRONMENTALLY SENSITIVE AREA	---
WIND TURBINE CONSTRUCTION SITE	---
ROTOR LAYDOWN	---
WIND TURBINE	---
GRAVEL PAD	---
WORK AREA	---
CRANE PAD	---




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PROFILE LEGEND	
ITEM	SYMBOL
EXISTING ELEVATION (FT)	1845.3
PROPOSED ELEVATION (FT)	1845.27
EXISTING GRADE	---
PROPOSED GRADE	---

NOTE: ELEVATIONS IN USGS DATUM.

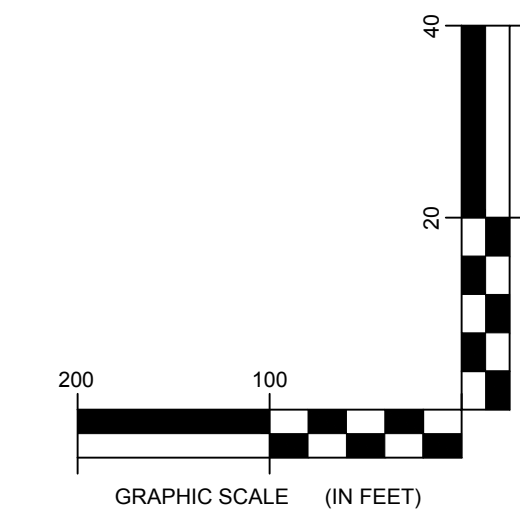

**1 PLAN VIEW - TRUNK T36 ACCESS ROAD TO TURBINES T20, T19, T21, AND T36**  
Scale: 1"=100'


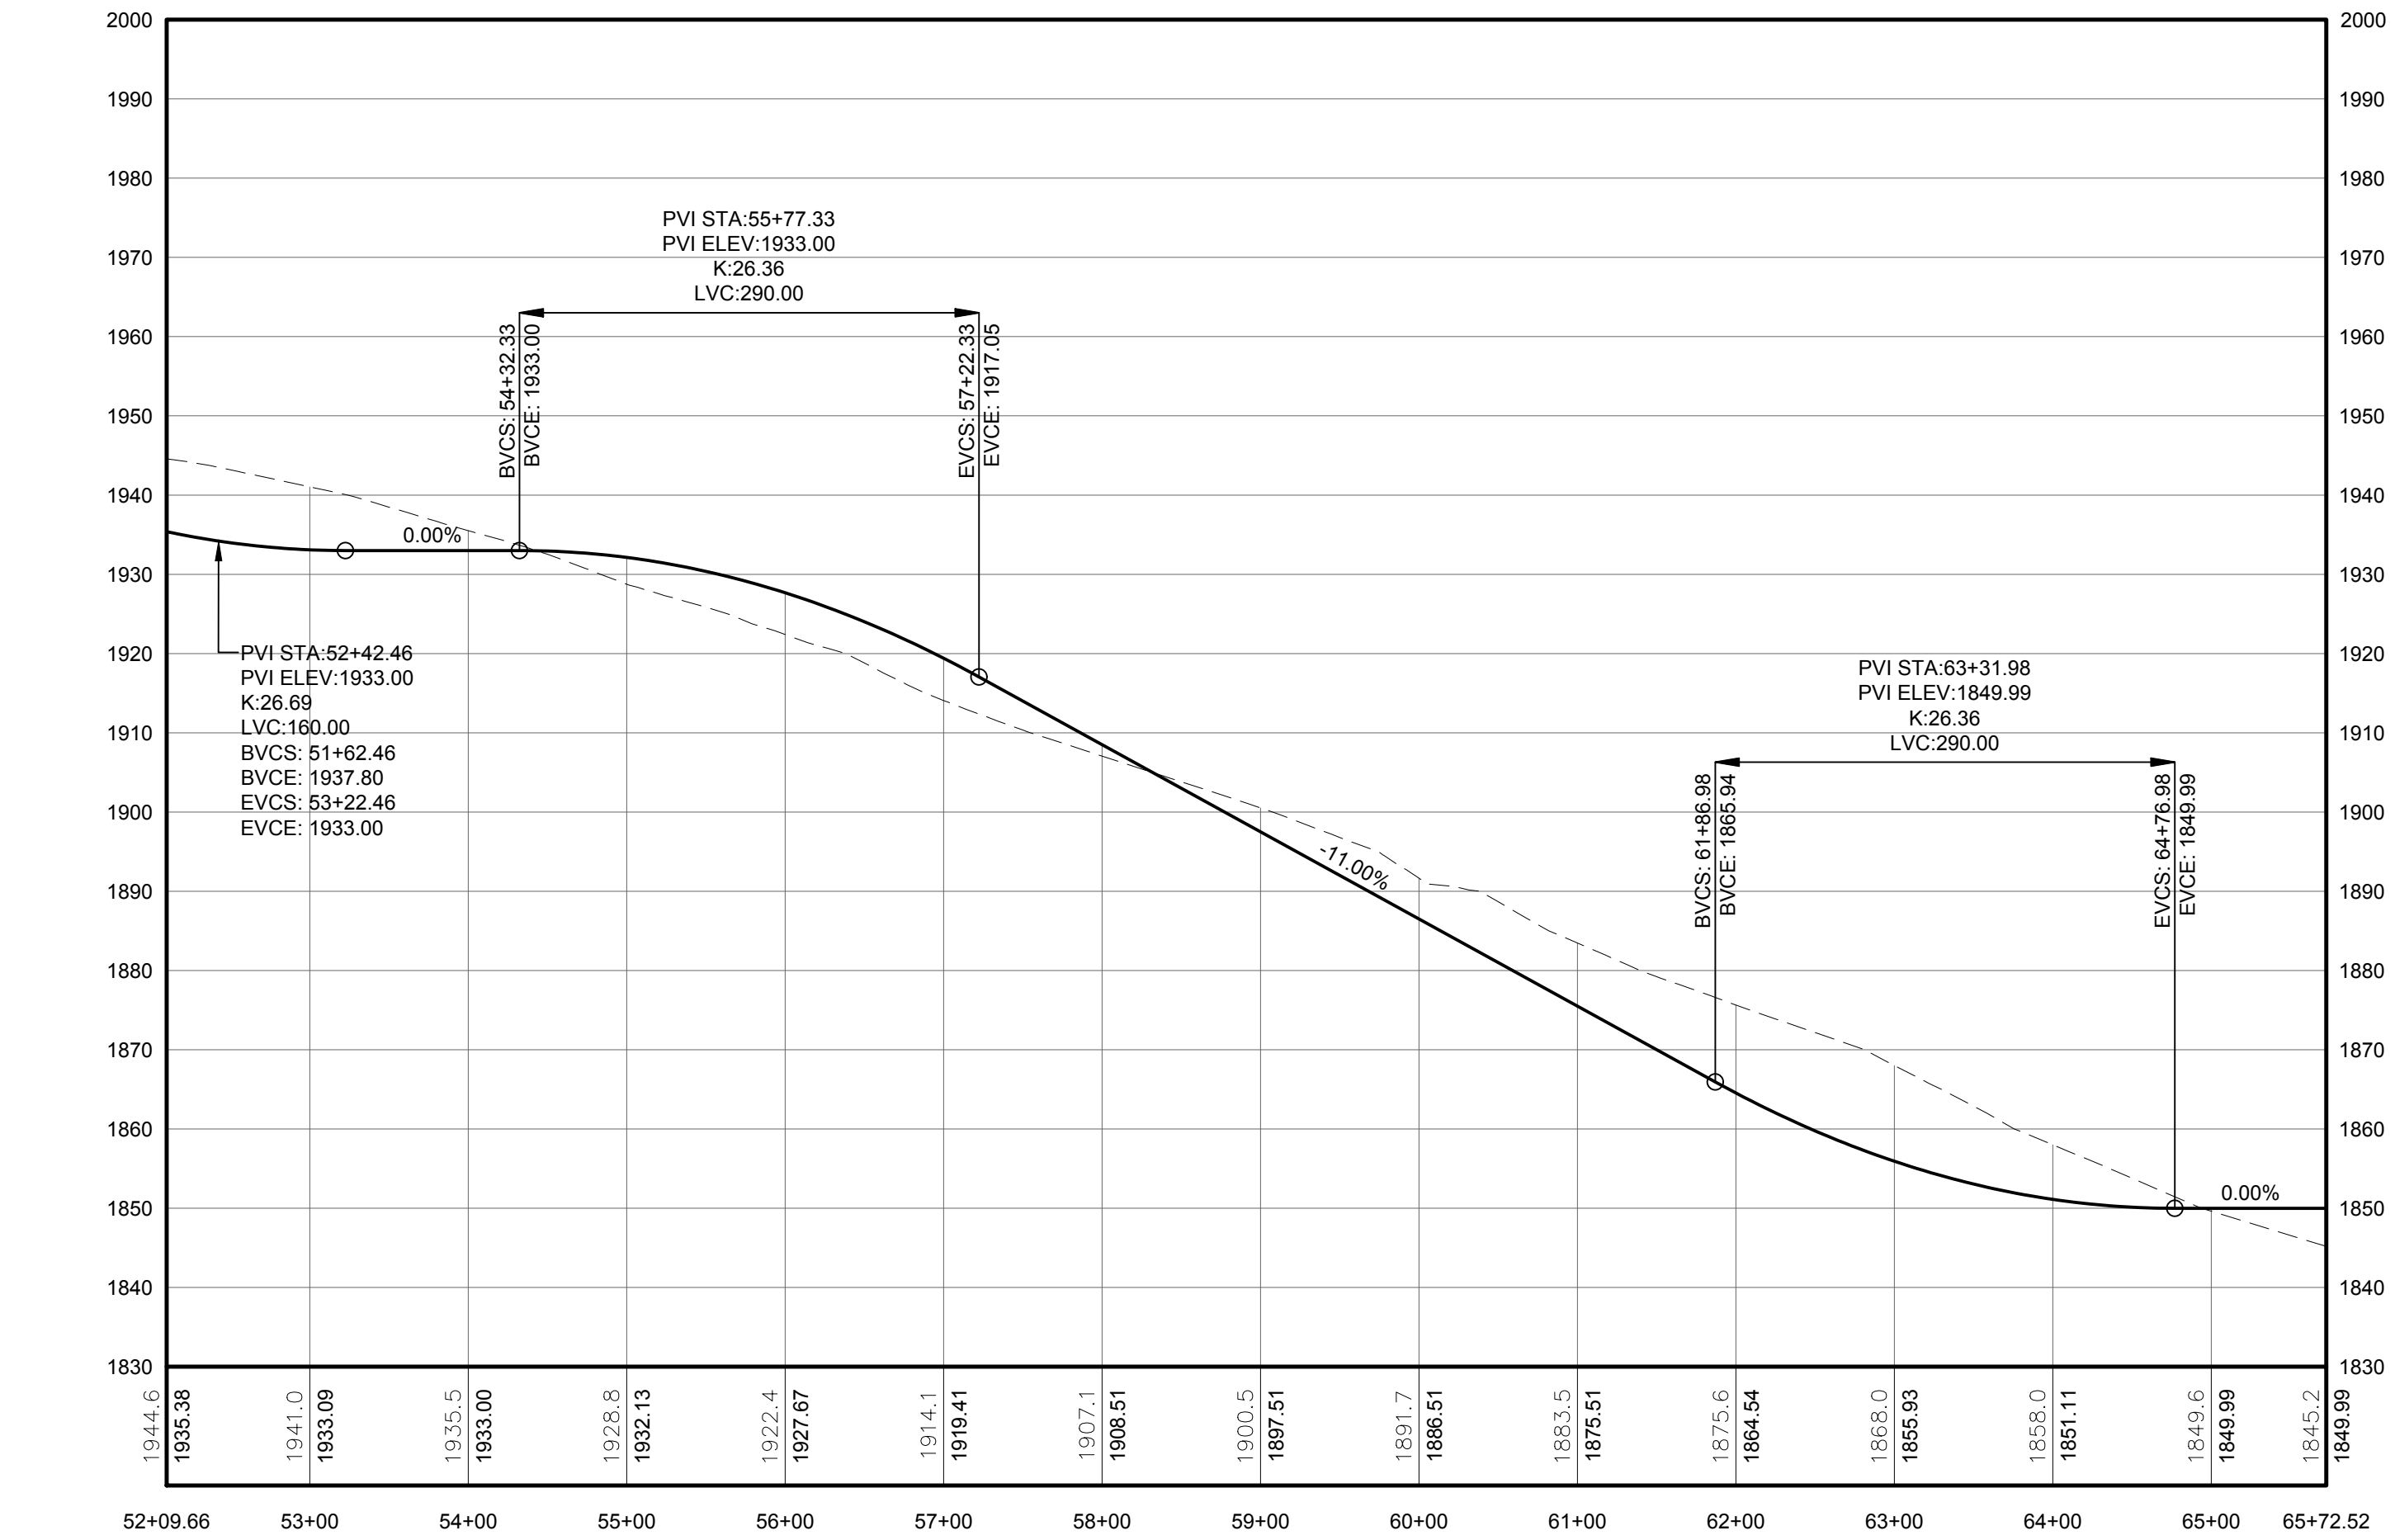


**2 ACCESS ROAD PROFILE**  
Scale: H: 1"=100' V: 1"=20'



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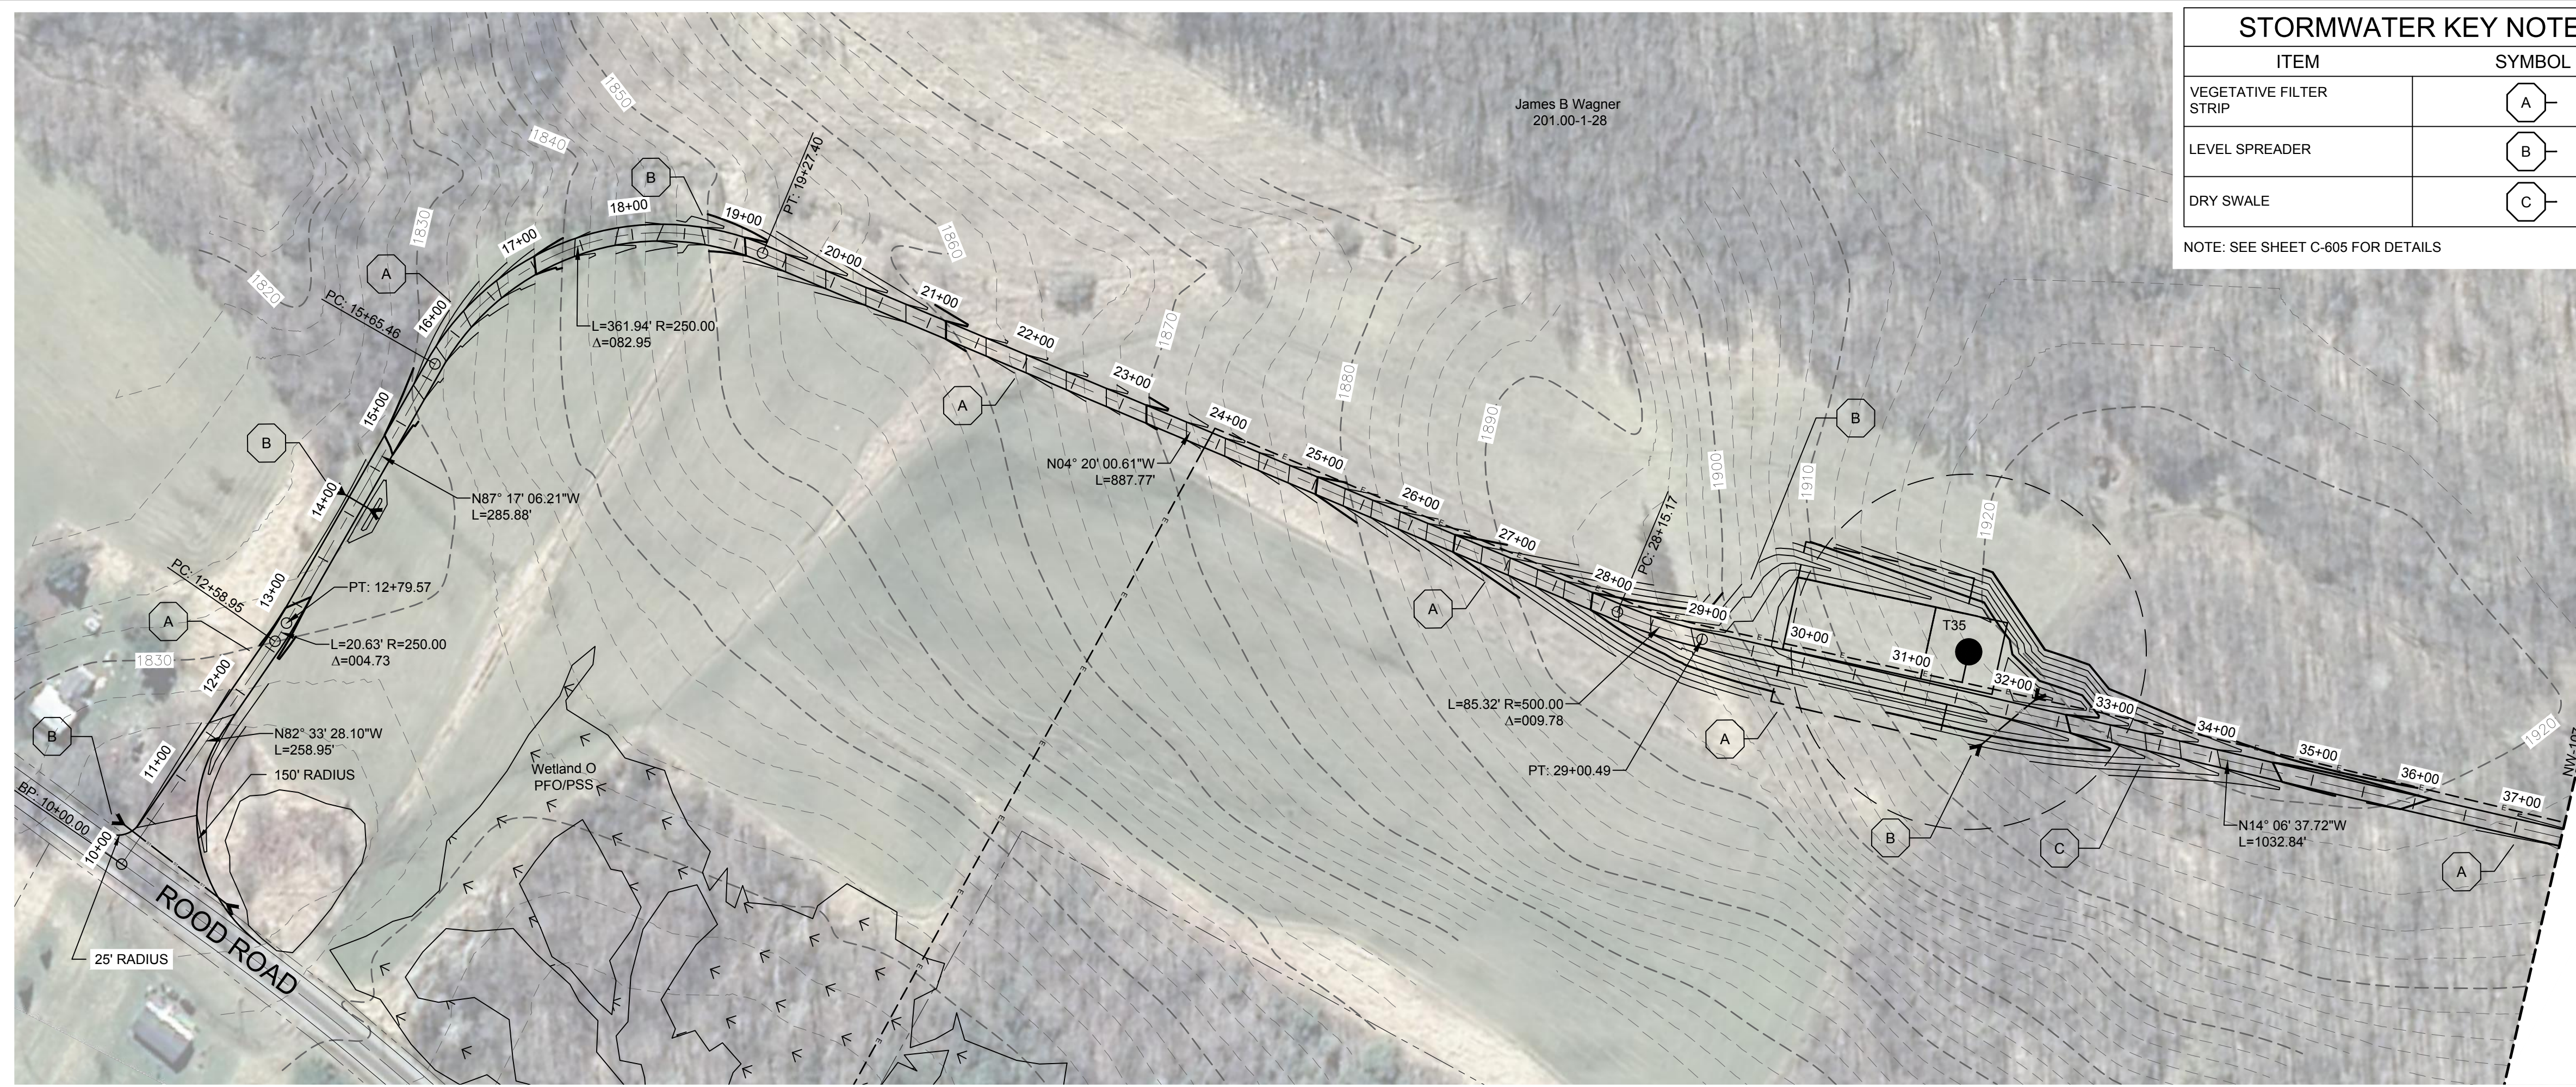
DRAWING REVISIONS	
NO.	DATE

PROJECT TITLE:	<b>CASSADAGA WIND PROJECT</b>
PROJECT LOCATION:	TOWNS OF CHARLOTTE, CHERRY CREEK, ARKWRIGHT, AND STOCKTON CHAUTAUGUS COUNTY, NEW YORK
CLIENT:	CASSADAGA WIND LLC
DRAWING TITLE:	ACCESS ROAD PLAN AND PROFILE

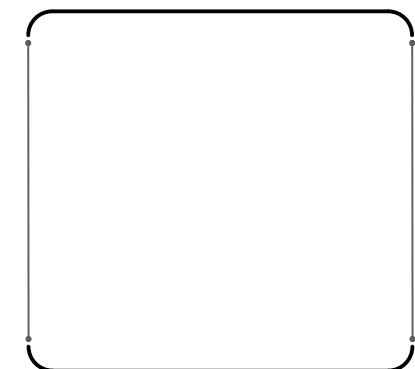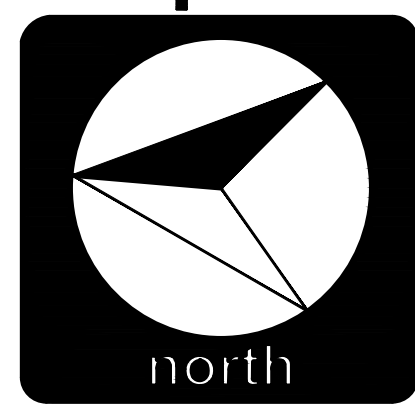DATE:	APRIL 22, 2016
SCALE:	AS NOTED
edr JOB#:	14048
DRAWN BY:	AW, CB, ZR
CHECKED BY:	TD
FILE NAME:	14048_Working_NW.dwg
DRAWING NUMBER:	<b>NW-106</b>

I:\14048\Cassadaga Wind\power\working\drawing\14048\_working\_nw.dwg





### STORMWATER KEY NOTES

ITEM	SYMBOL
VEGETATIVE FILTER STRIP	(A)
LEVEL SPREADER	(B)
DRY SWALE	(C)

NOTE: SEE SHEET C-605 FOR DETAILS


### LEGEND

ITEM	SYMBOL
DRAWING SHEET MATCH LINE	--- DRAWING NUMBER ---
WIND TURBINE DESIGNATION	T53
PARCEL BOUNDARY	---
115 KV OVERHEAD GENERATOR LEAD LINE	---
115 KV OVERHEAD GENERATOR LEAD LINE POLE	⊙
UNDERGROUND COLLECTION LINE	---
OVERHEAD COLLECTION LINE	---
EXISTING CONTOUR (2' INTERVAL)	(490)
EXISTING CONTOUR - INDEX (2' INTERVAL)	(498)
CONTOUR - FINISHED - INDEX (2' INTERVAL)	(490)
ACCESS ROAD CENTERLINE	---
PERMANENT ACCESS ROAD EDGE	---
STORM PIPE / CULVERT	→
NYSDEC WETLAND	▨
WETLAND BOUNDARY	↓ ↓ ↓
STREAM BOUNDARY	▨
APPROXIMATE WETLAND BOUNDARY	↓ ↓ ↓
APPROXIMATE STREAM BOUNDARY	▨
ENVIRONMENTALLY SENSITIVE AREA - RESTRICTED ACCESS	▨
ENVIRONMENTALLY SENSITIVE AREA	▨
WIND TURBINE CONSTRUCTION SITE	⊙
ROTOR LAYDOWN	⊙
WIND TURBINE	⊙
GRAVEL PAD	⊙
WORK AREA	⊙
CRANE PAD	⊙

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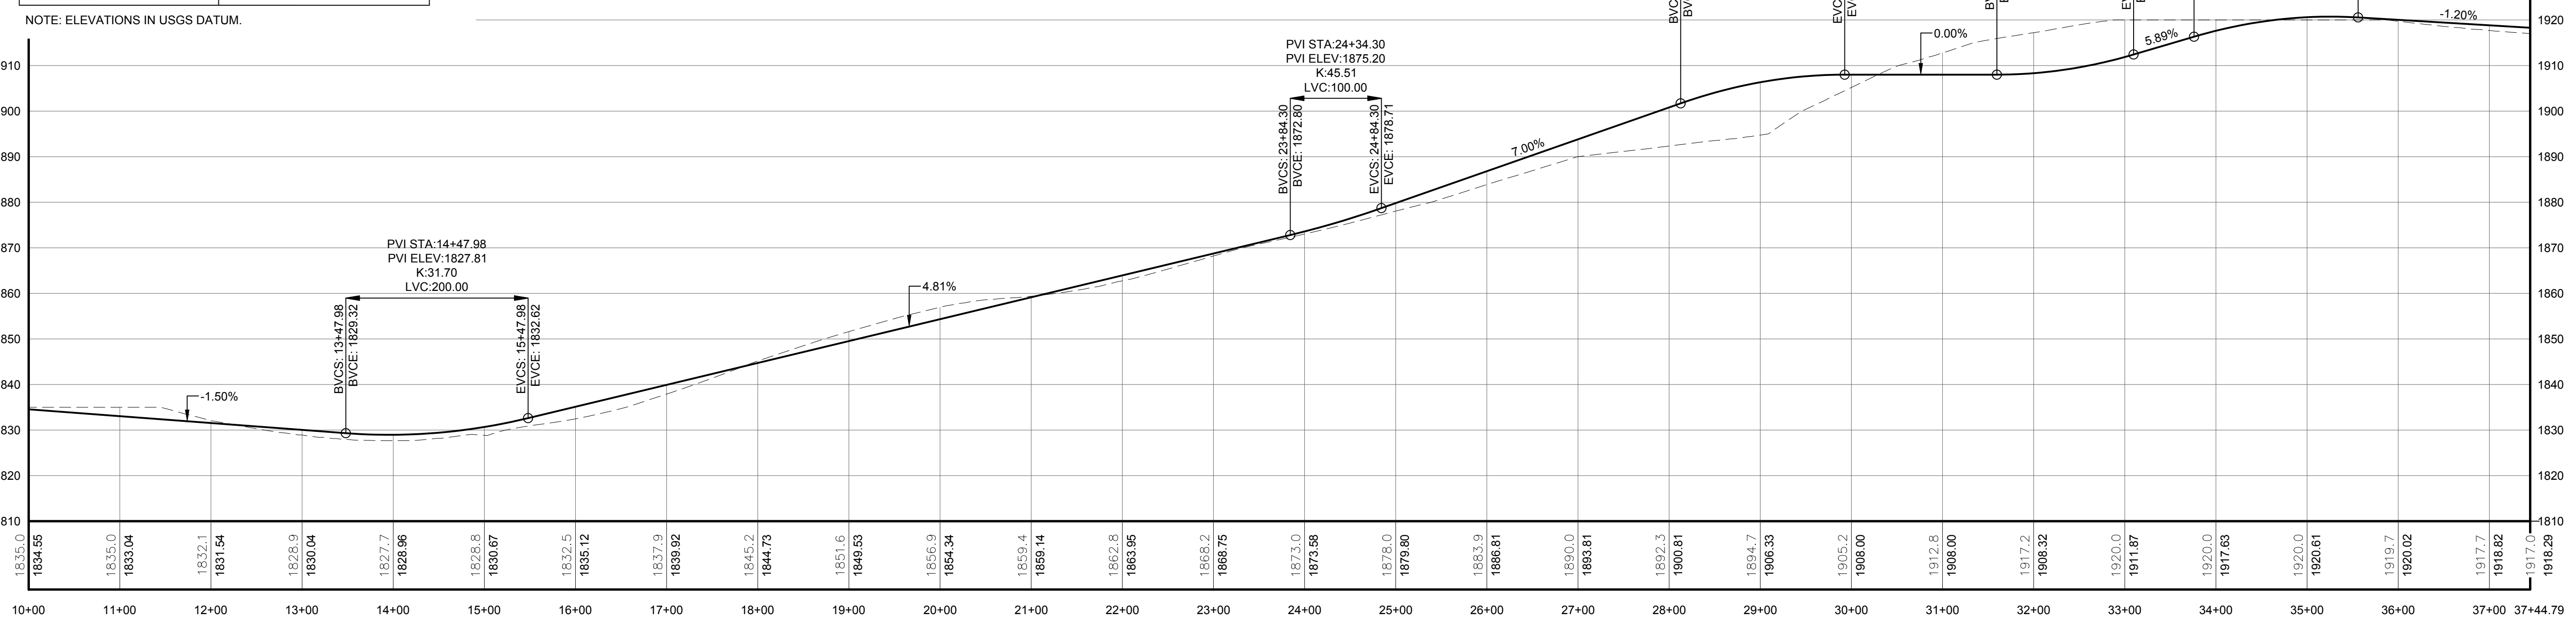
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**1 PLAN VIEW - TRUNK T57 ACCESS ROAD TO TURBINES T35 AND T57**  
 Scale: 1"=100'



### PROFILE LEGEND

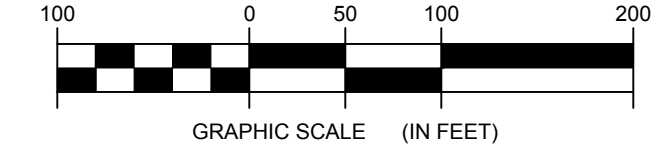
ITEM	SYMBOL
EXISTING ELEVATION (FT)	1845.3
PROPOSED ELEVATION (FT)	1845.27
EXISTING GRADE	---
PROPOSED GRADE	---



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NO.	DATE	REVISION


**2 ACCESS ROAD PROFILE**  
 Scale: H: 1"=100' V: 1"=20'

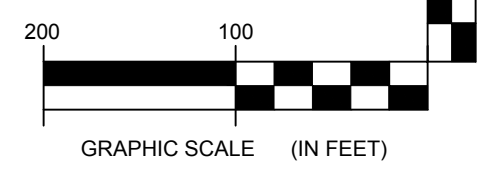

**CASSADAGA WIND PROJECT**  
 TOWNS OF CHARLOTTE, CHERRY CREEK, ARKWRIGHT, AND STOCKTON  
 PROJECT LOCATION: CHAUTAQUA COUNTY, NEW YORK  
 CLIENT: CASSADAGA WIND LLC  
 DRAWING TITLE: ACCESS ROAD PLAN AND PROFILE

DATE: APRIL 22, 2016  
 SCALE: AS NOTED  
 eor JOB#: 14048  
 DRAWN BY: AW, CB, ZR  
 CHECKED BY: TD  
 FILE NAME: 14048\_Working\_NW.dwg  
 DRAWING NUMBER: **NW-107**



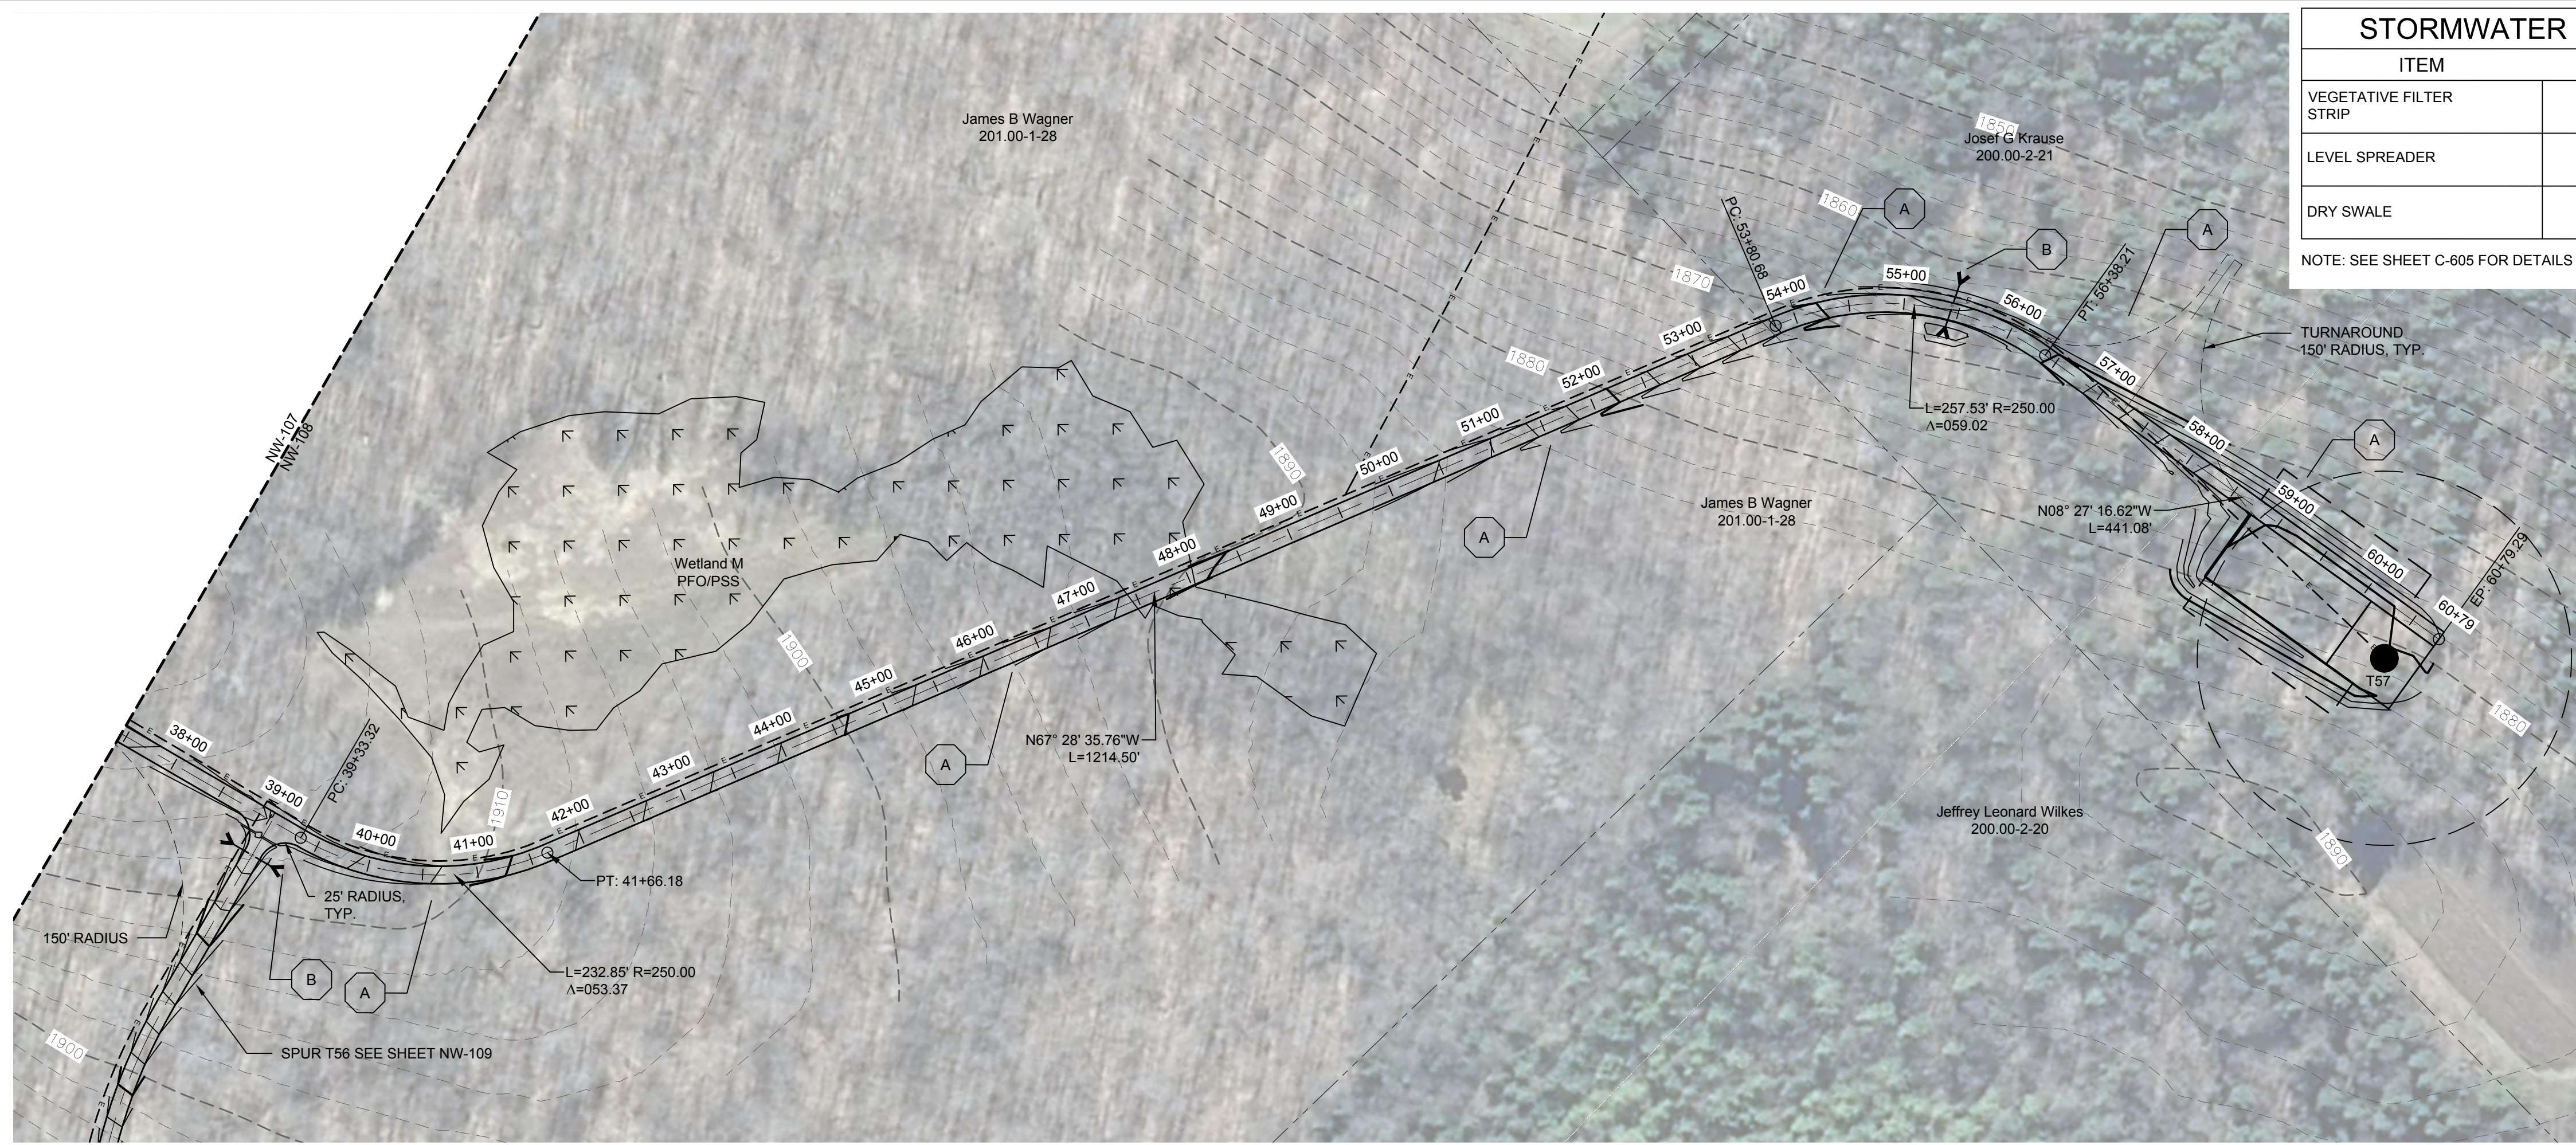

### STORMWATER KEY NOTES

ITEM	SYMBOL
VEGETATIVE FILTER STRIP	(A)
LEVEL SPREADER	(B)
DRY SWALE	(C)


NOTE: SEE SHEET C-605 FOR DETAILS

### LEGEND


ITEM	SYMBOL
DRAWING SHEET MATCH LINE	--- DRAWING NUMBER ---
WIND TURBINE DESIGNATION	T53
PARCEL BOUNDARY	---
115 KV OVERHEAD GENERATOR LEAD LINE	---
115 KV OVERHEAD GENERATOR LEAD LINE POLE	⊙
UNDERGROUND COLLECTION LINE	---
OVERHEAD COLLECTION LINE	---
EXISTING CONTOUR (2' INTERVAL)	---
EXISTING CONTOUR - INDEX (2' INTERVAL)	---
CONTOUR - FINISHED (2' INTERVAL)	---
CONTOUR - FINISHED - INDEX (2' INTERVAL)	---
ACCESS ROAD CENTERLINE	---
PERMANENT ACCESS ROAD EDGE	---
STORM PIPE / CULVERT	---
NYSDEC WETLAND	---
WETLAND BOUNDARY	---
STREAM BOUNDARY	---
APPROXIMATE WETLAND BOUNDARY	---
APPROXIMATE STREAM BOUNDARY	---
ENVIRONMENTALLY SENSITIVE AREA - RESTRICTED ACCESS	---
ENVIRONMENTALLY SENSITIVE AREA	---
WIND TURBINE CONSTRUCTION SITE	---
ROTOR LAYDOWN	---
WIND TURBINE	---
GRAVEL PAD	---
WORK AREA	---
CRANE PAD	---



1 PLAN VIEW - TRUNK T57 ACCESS ROAD TO TURBINES T35 AND T57  
108 Scale: 1"=100'

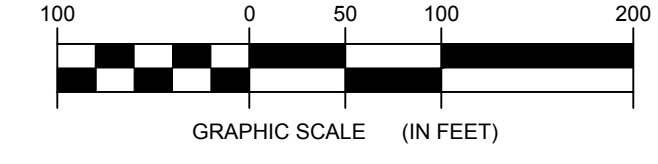


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### PROFILE LEGEND

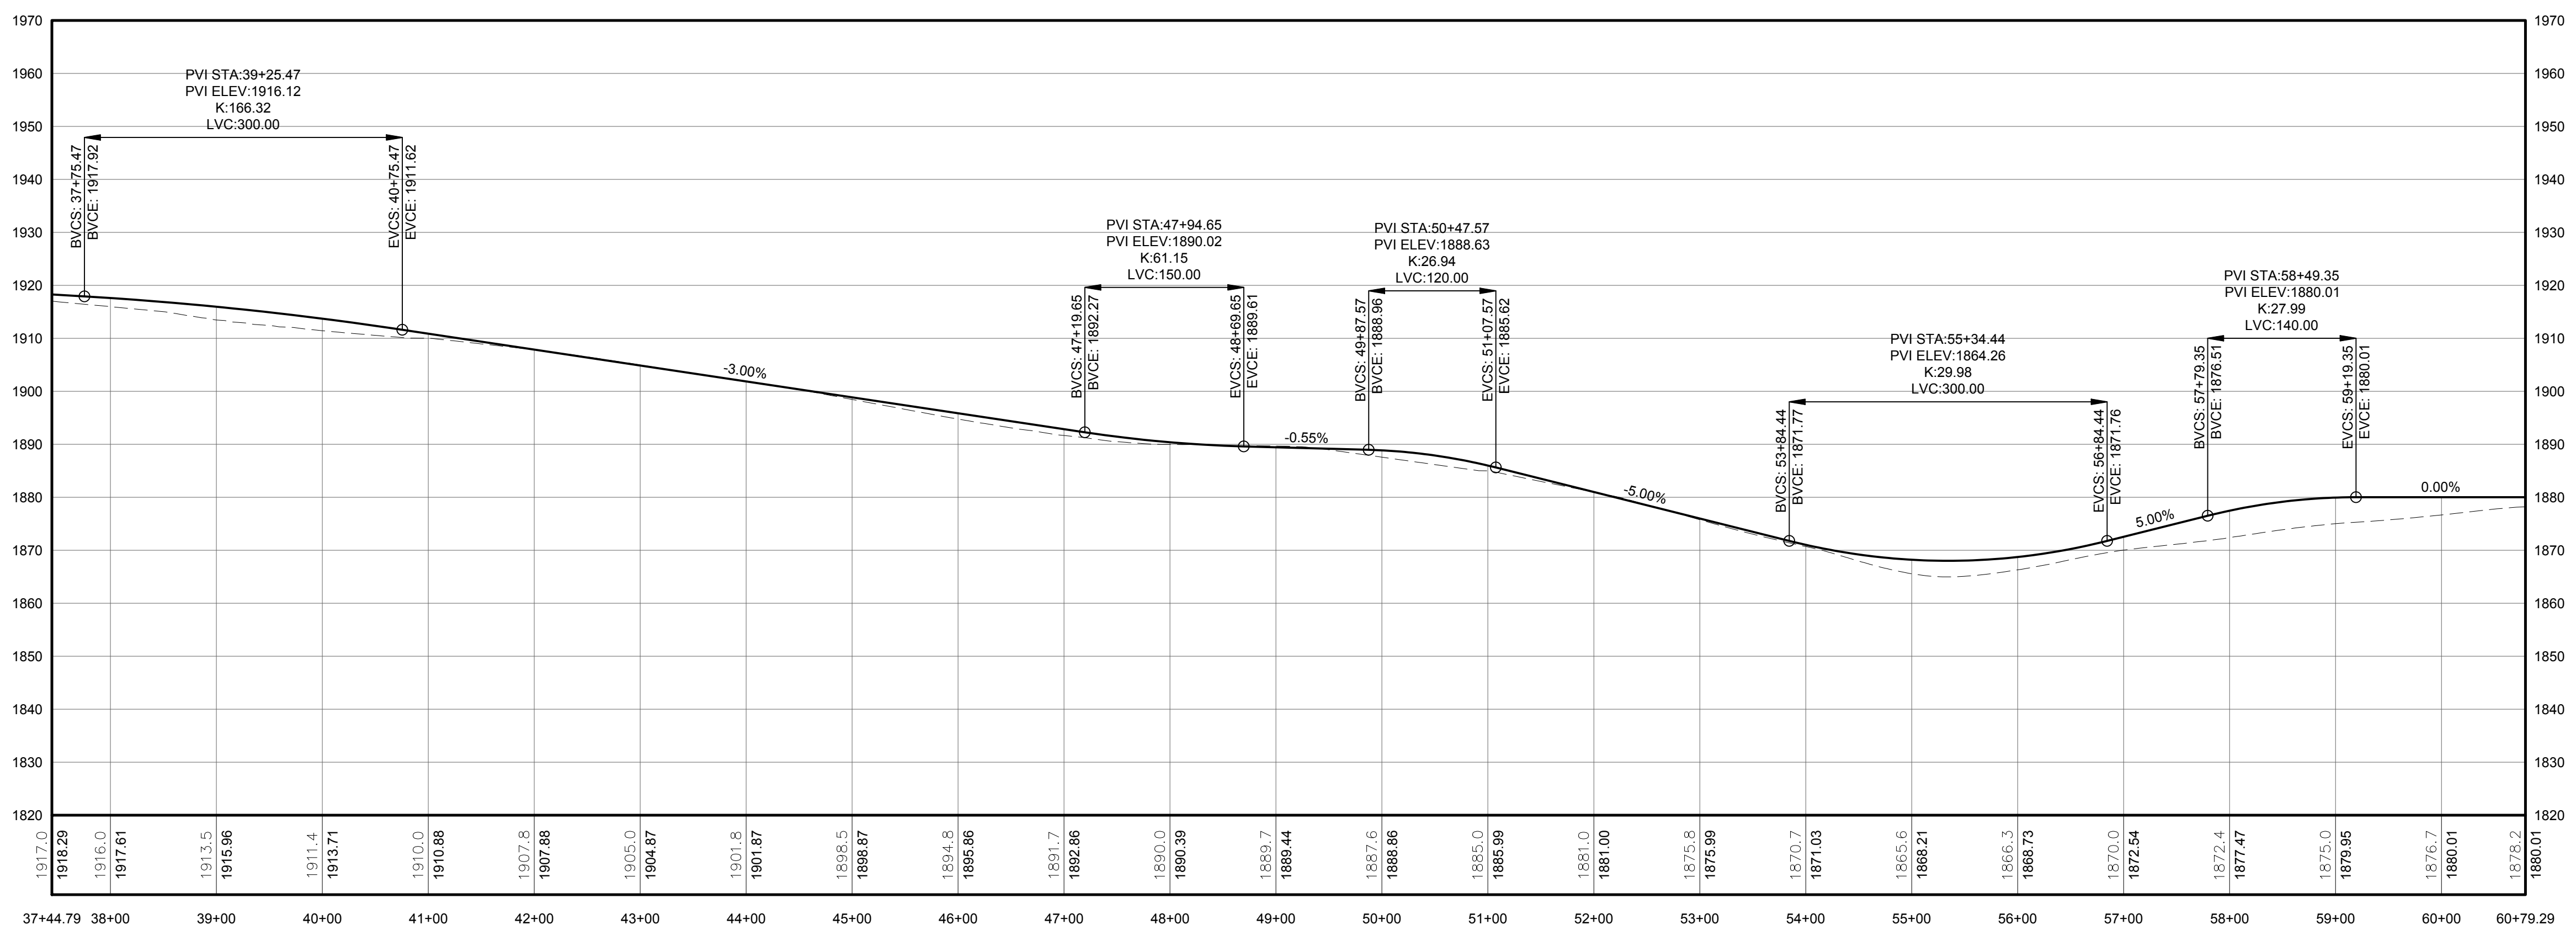ITEM	SYMBOL
EXISTING ELEVATION (FT)	1845.3
PROPOSED ELEVATION (FT)	1845.27
EXISTING GRADE	---
PROPOSED GRADE	---

NOTE: ELEVATIONS IN USGS DATUM.



2 ACCESS ROAD PROFILE  
108 Scale: H:1"=100' V:1"=20'

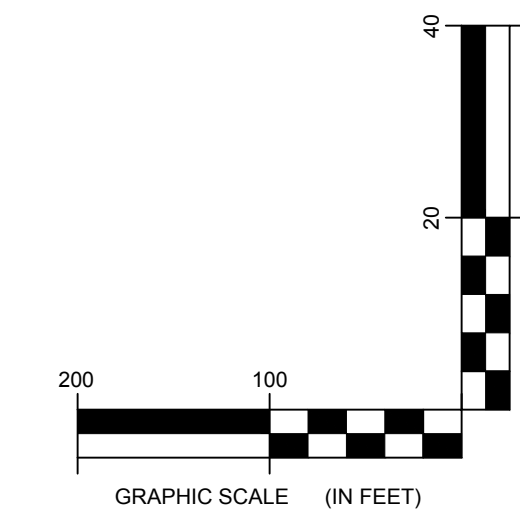
151001 Cassadaga Wind Power/Access Road/14048\_Working\_NW.dwg

NO.	DATE	REVISION


PROJECT TITLE: **CASSADAGA WIND PROJECT**  
 TOWNS OF CHARLOTTE, CHERRY CREEK, ARKWRIGHT, AND STOCKTON  
 PROJECT LOCATION: CHAUTAUGUS COUNTY, NEW YORK  
 CLIENT: CASSADAGA WIND LLC  
 DRAWING TITLE: ACCESS ROAD PLAN AND PROFILE

DATE	APRIL 22, 2016
SCALE	AS NOTED
JOB NO.	14048
DRAWN BY	AW, CB, ZR
CHECKED BY	TD
FILE NAME	14048_Working_NW.dwg
DRAWING NUMBER	NW-108



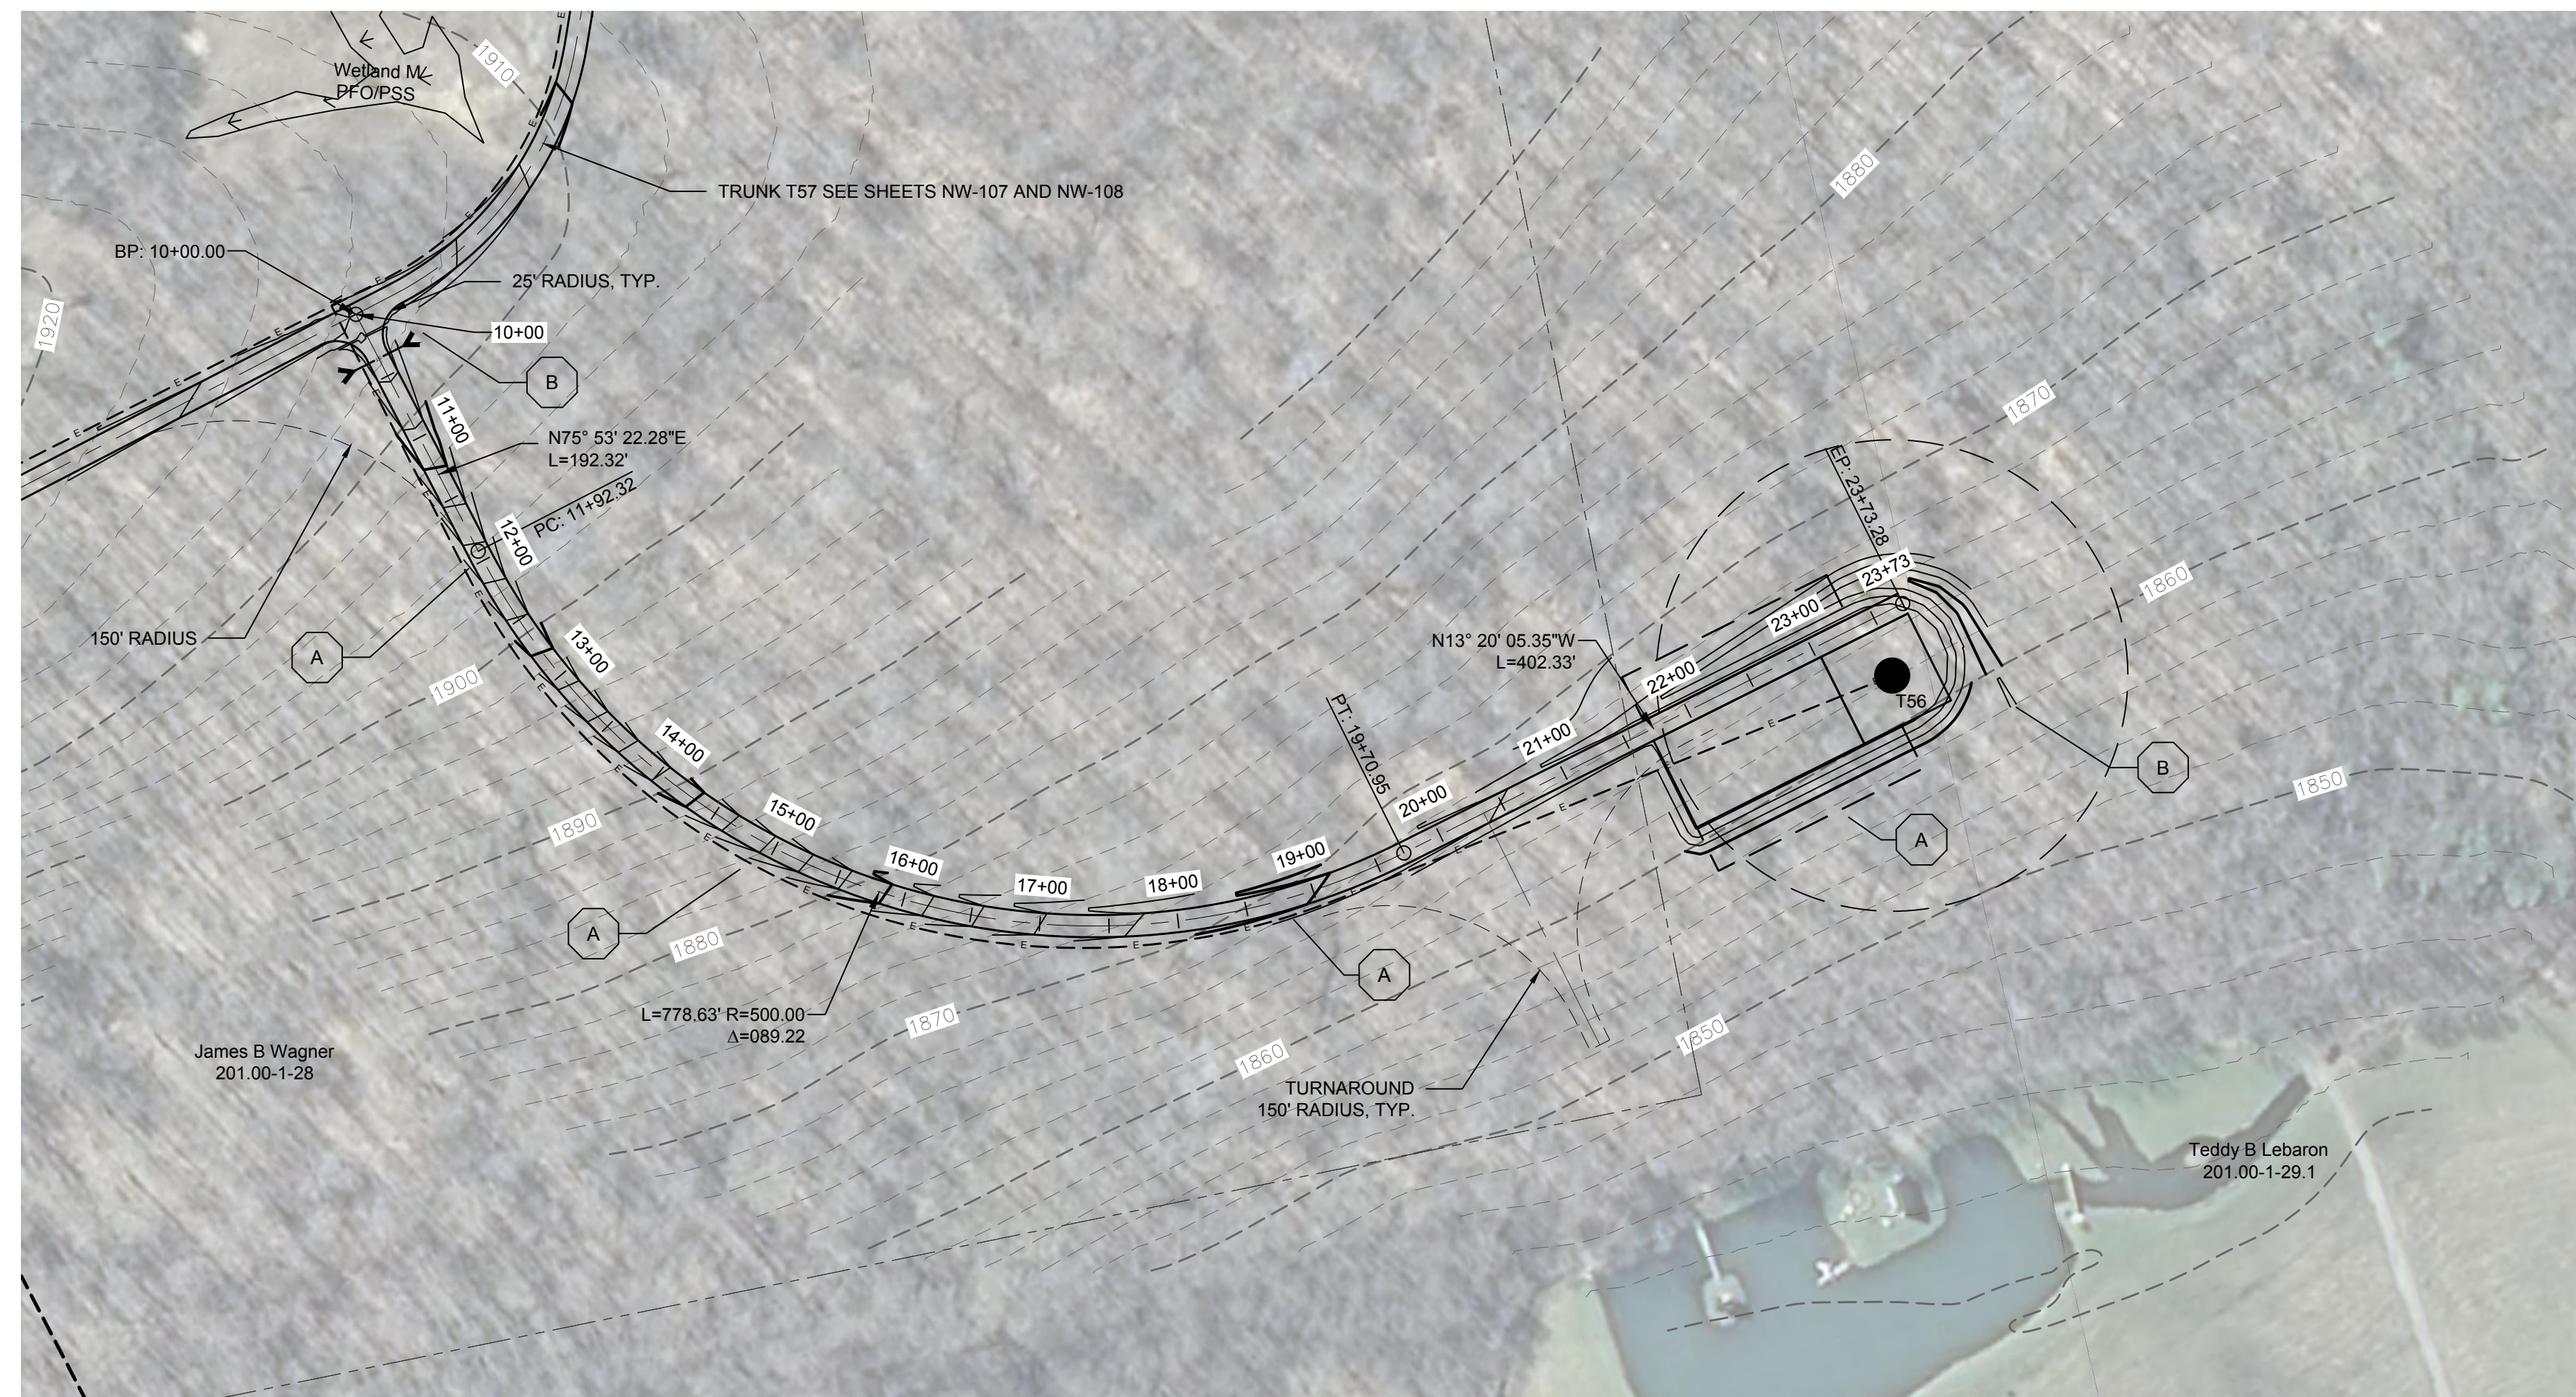

1 PLAN VIEW - SPUR T56 ACCESS ROAD  
Scale: 1"=100'

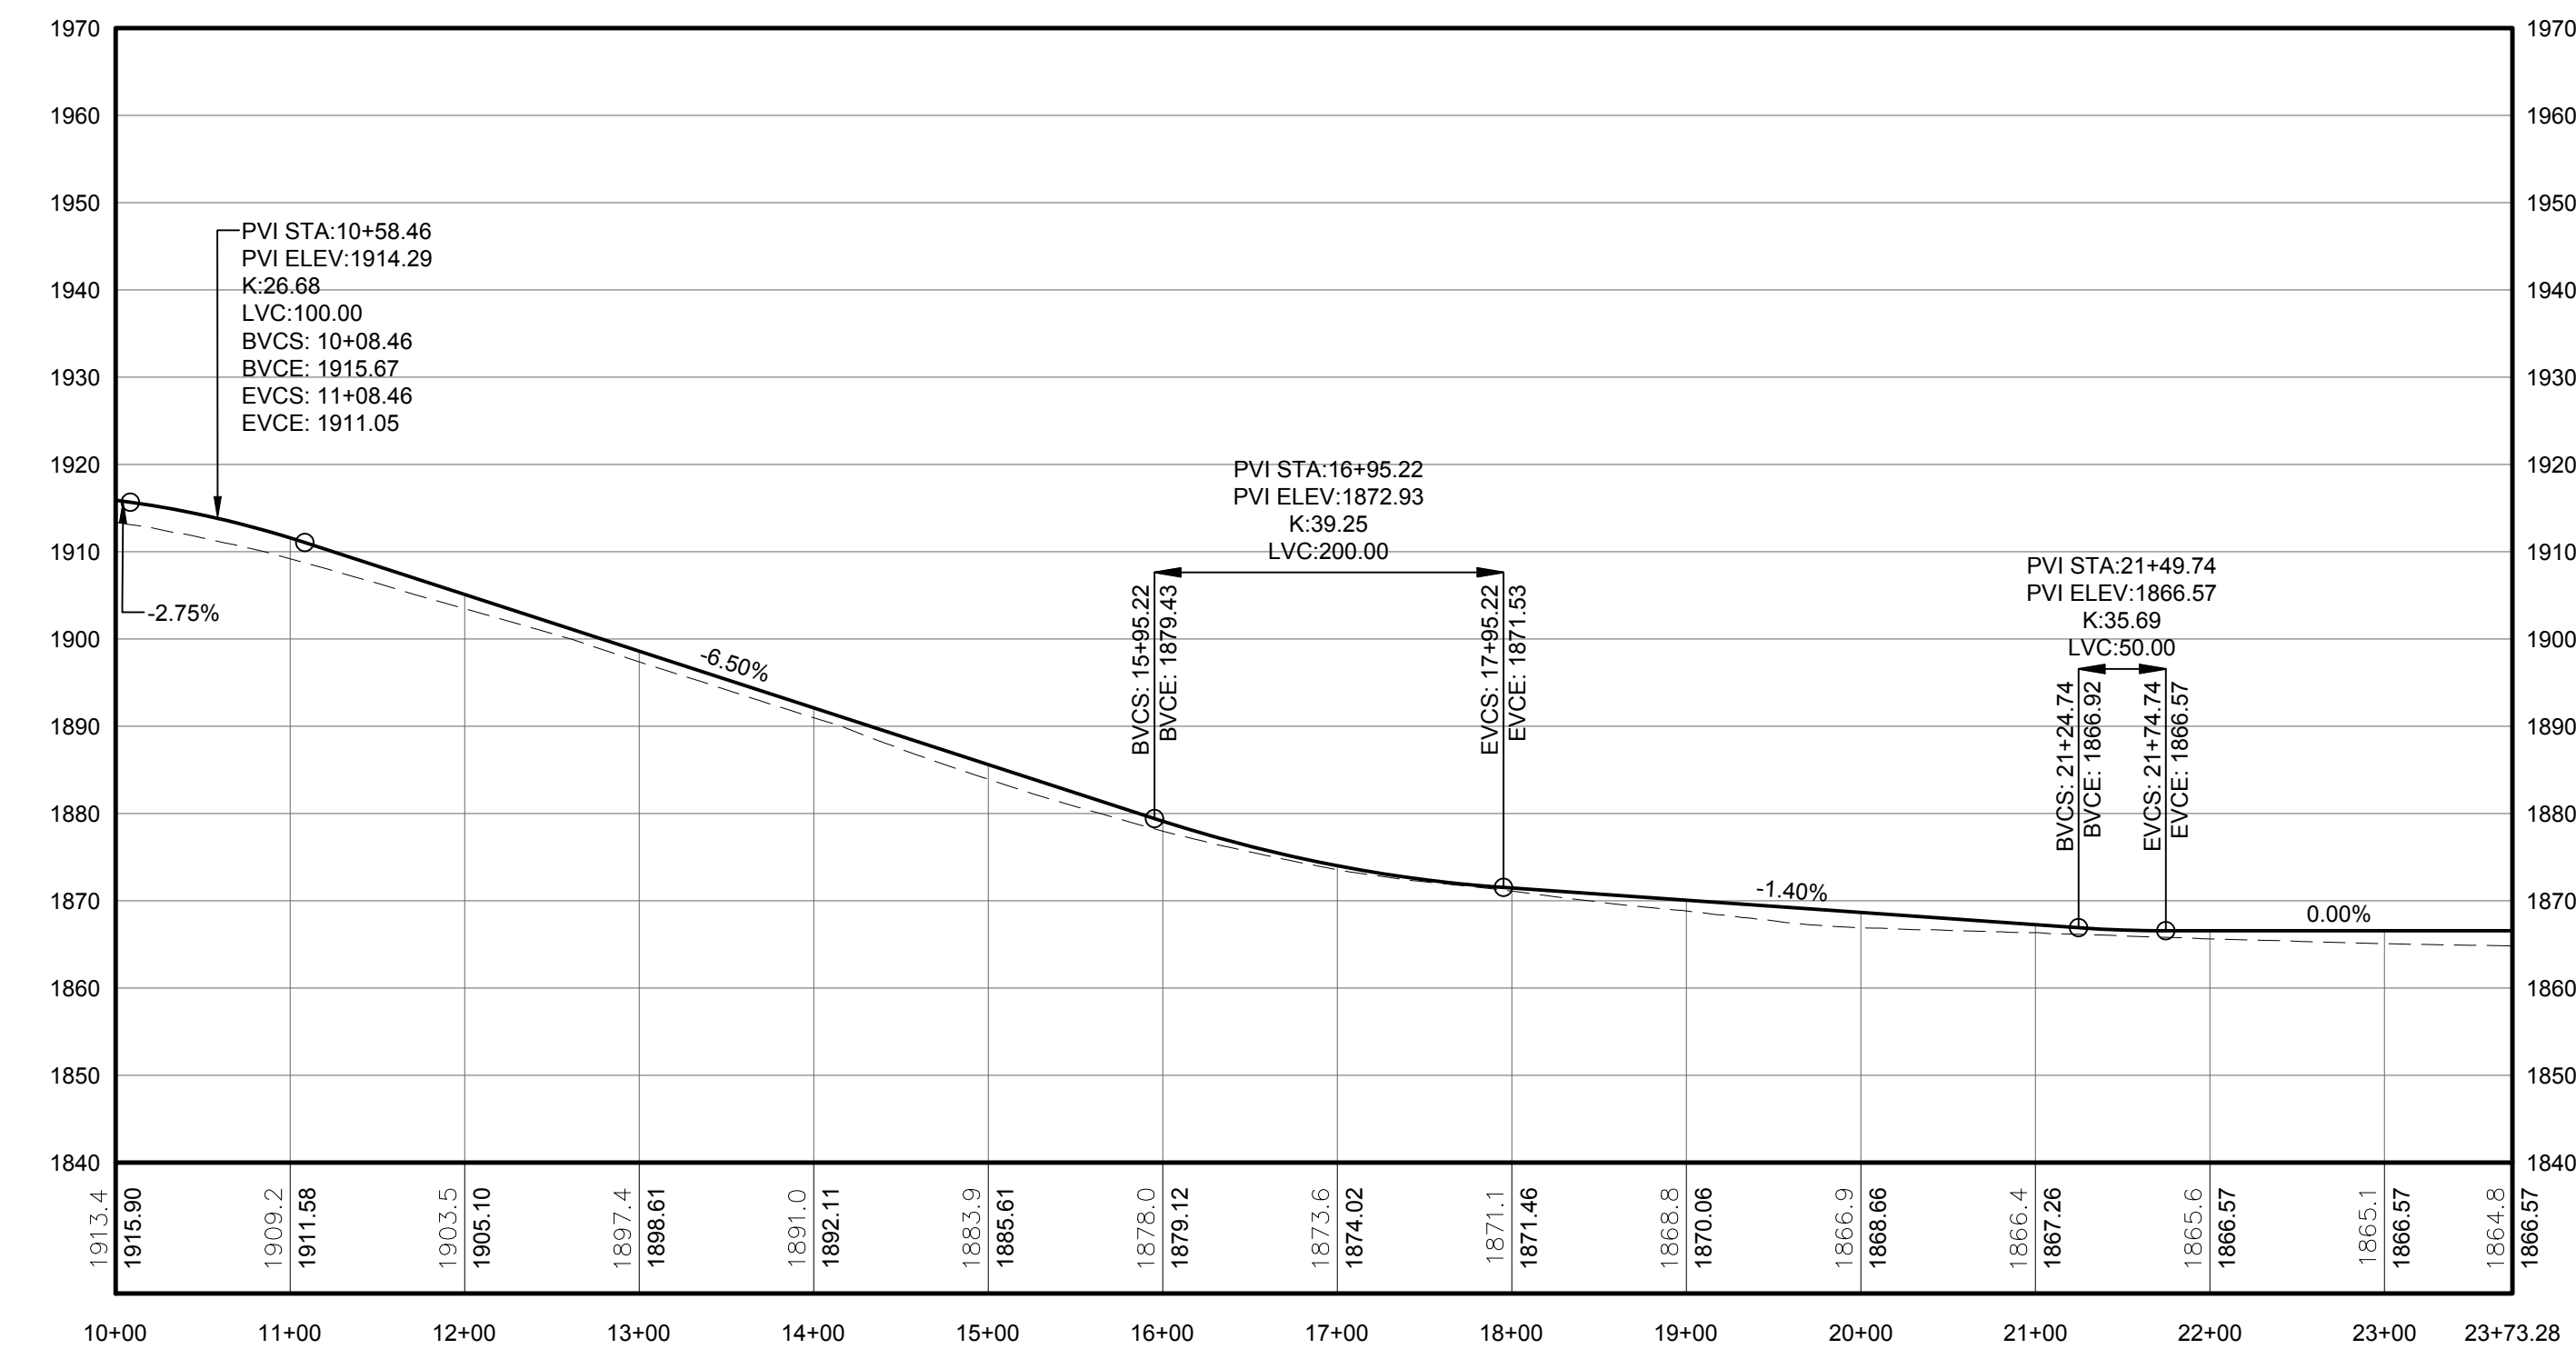


2 ACCESS ROAD PROFILE  
Scale: H:1"=100' V:1"=20'

STORMWATER KEY NOTES	
ITEM	SYMBOL
VEGETATIVE FILTER STRIP	(A)
LEVEL SPREADER	(B)
DRY SWALE	(C)

NOTE: SEE SHEET C-605 FOR DETAILS


LEGEND	
ITEM	SYMBOL
DRAWING SHEET MATCH LINE	--- DRAWING NUMBER --- DRAWING NUMBER
WIND TURBINE DESIGNATION	T53
PARCEL BOUNDARY	---
115 KV OVERHEAD GENERATOR LEAD LINE	---
115 KV OVERHEAD GENERATOR LEAD LINE POLE	o
UNDERGROUND COLLECTION LINE	---
OVERHEAD COLLECTION LINE	---
EXISTING CONTOUR (2' INTERVAL)	---
EXISTING CONTOUR - INDEX (2' INTERVAL)	---
CONTOUR - FINISHED (2' INTERVAL)	---
CONTOUR - FINISHED - INDEX (2' INTERVAL)	---
ACCESS ROAD CENTERLINE	---
PERMANENT ACCESS ROAD EDGE	---
STORM PIPE / CULVERT	--->---
NYSDEC WETLAND	---
WETLAND BOUNDARY	---
STREAM BOUNDARY	---
APPROXIMATE WETLAND BOUNDARY	---
APPROXIMATE STREAM BOUNDARY	---
ENVIRONMENTALLY SENSITIVE AREA - RESTRICTED ACCESS	---
ENVIRONMENTALLY SENSITIVE AREA	---
WIND TURBINE CONSTRUCTION SITE	---
ROTOR LAYDOWN	---
WIND TURBINE	o
GRAVEL PAD	---
WORK AREA	---
CRANE PAD	---

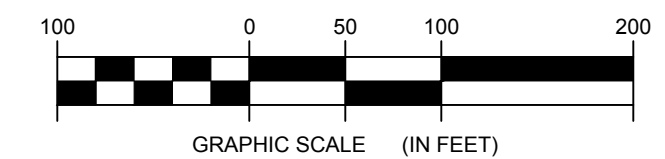

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PROFILE LEGEND	
ITEM	SYMBOL
EXISTING ELEVATION (FT)	1845.3
PROPOSED ELEVATION (FT)	1845.27
EXISTING GRADE	---
PROPOSED GRADE	---

NOTE: ELEVATIONS IN USGS DATUM.

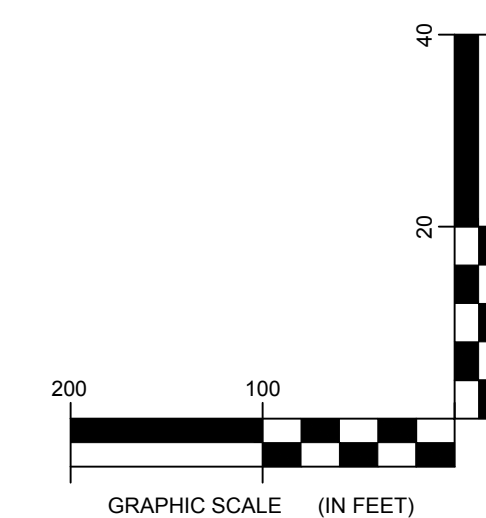

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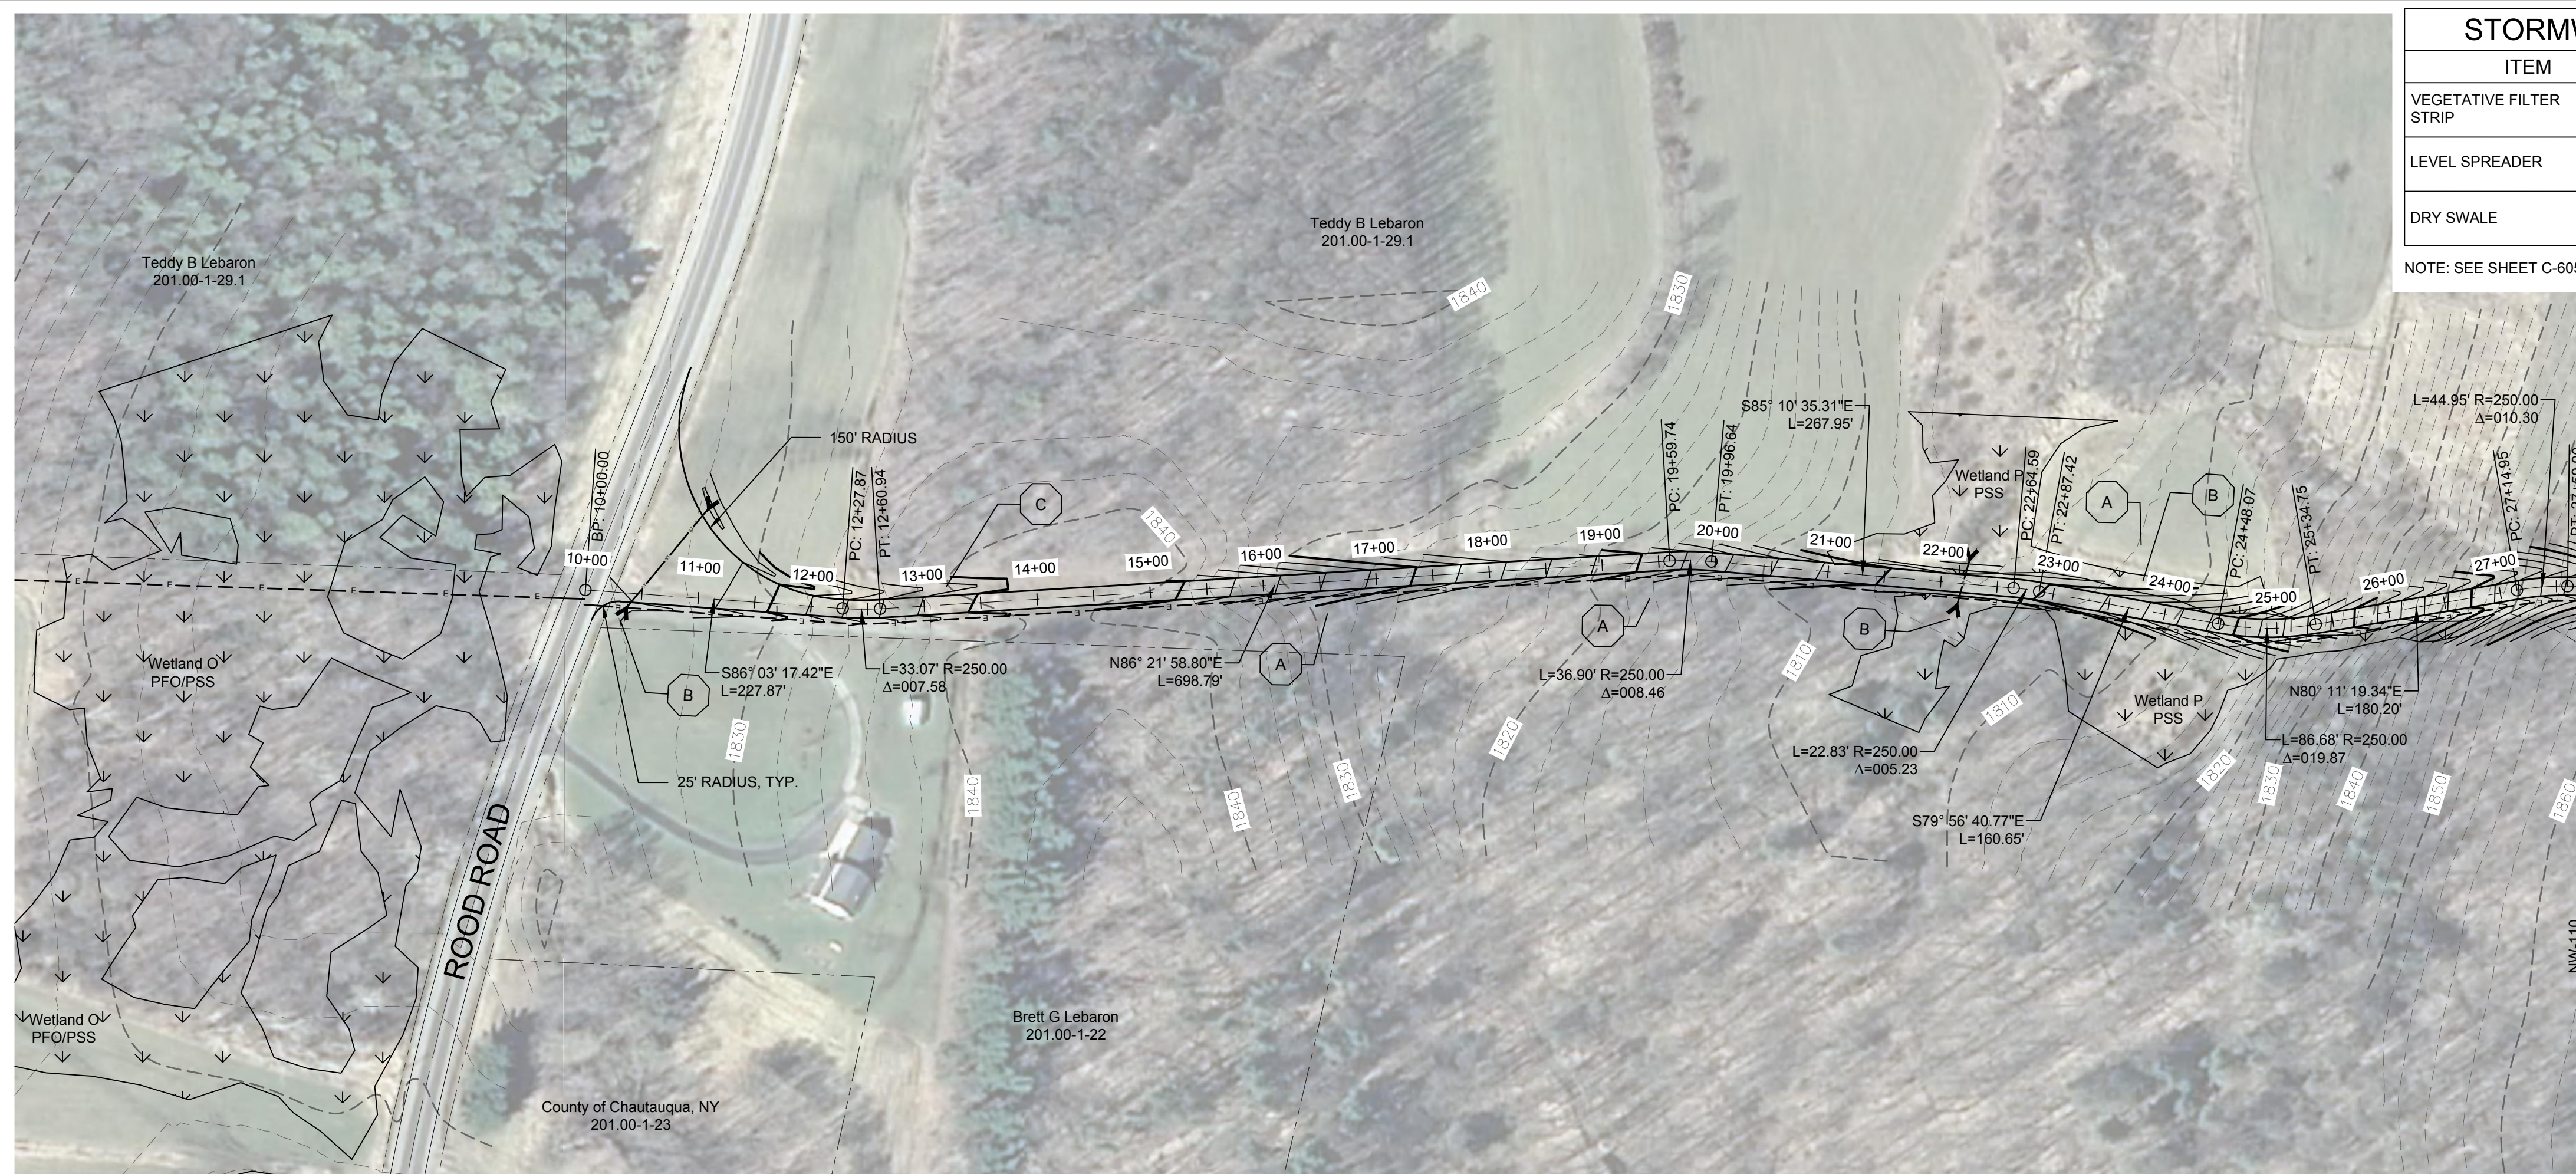


DRAWING REVISIONS	
NO.	DATE

PROJECT TITLE: <b>CASSADAGA WIND PROJECT</b>
TOWNS OF CHARLOTTE, CHERRY CREEK, ARKWRIGHT, AND STOCKTON
PROJECT LOCATION: CHAUTAQUA COUNTY, NEW YORK
CLIENT: CASSADAGA WIND LLC
DRAWING TITLE: ACCESS ROAD PLAN AND PROFILE

DATE: APRIL 22, 2016
SCALE: AS NOTED
JOB NO: 14048
DRAWN BY: AW, CB, ZR
CHECKED BY: TD
FILE NAME: 14048_Working_NW.dwg
DRAWING NUMBER: <b>NW-109</b>






STORMWATER KEY NOTES	
ITEM	SYMBOL
VEGETATIVE FILTER STRIP	(A)
LEVEL SPREADER	(B)
DRY SWALE	(C)

NOTE: SEE SHEET C-605 FOR DETAILS

LEGEND	
ITEM	SYMBOL
DRAWING SHEET MATCH LINE	--- DRAWING NUMBER --- --- DRAWING NUMBER ---
WIND TURBINE DESIGNATION	T53
PARCEL BOUNDARY	---
115 KV OVERHEAD GENERATOR LEAD LINE	---
115 KV OVERHEAD GENERATOR LEAD LINE POLE	⊙
UNDERGROUND COLLECTION LINE	---
OVERHEAD COLLECTION LINE	---
EXISTING CONTOUR (2' INTERVAL)	---
EXISTING CONTOUR - INDEX (2' INTERVAL)	---
CONTOUR - FINISHED (2' INTERVAL)	---
CONTOUR - FINISHED - INDEX (2' INTERVAL)	---
ACCESS ROAD CENTERLINE	---
PERMANENT ACCESS ROAD EDGE	---
STORM PIPE / CULVERT	---
NYSDEC WETLAND	---
WETLAND BOUNDARY	---
STREAM BOUNDARY	---
APPROXIMATE WETLAND BOUNDARY	---
APPROXIMATE STREAM BOUNDARY	---
ENVIRONMENTALLY SENSITIVE AREA - RESTRICTED ACCESS	---
ENVIRONMENTALLY SENSITIVE AREA	---
WIND TURBINE CONSTRUCTION SITE	---
ROTOR LAYDOWN	---
WIND TURBINE	---
GRAVEL PAD	---
WORK AREA	---
CRANE PAD	---


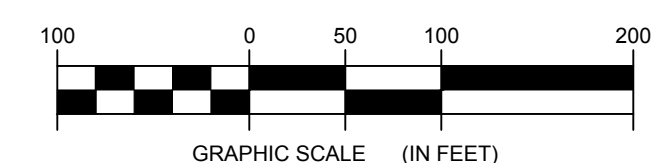


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PROFILE LEGEND	
ITEM	SYMBOL
EXISTING ELEVATION (FT)	1845.3
PROPOSED ELEVATION (FT)	1845.27
EXISTING GRADE	---
PROPOSED GRADE	---

NOTE: ELEVATIONS IN USGS DATUM.

**1 PLAN VIEW - TRUNK 53 ACCESS ROAD TO TURBINES T48 AND T53**  
Scale: 1"=100'

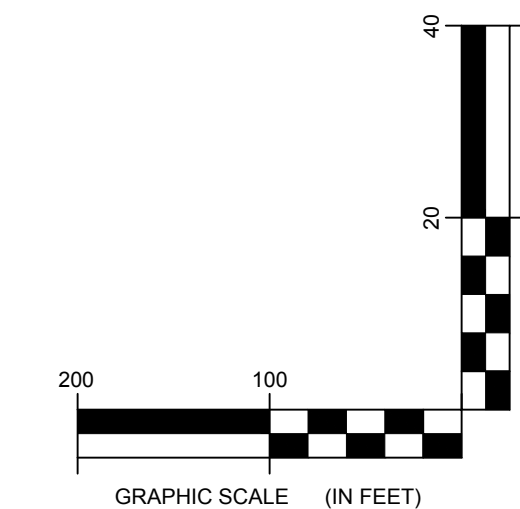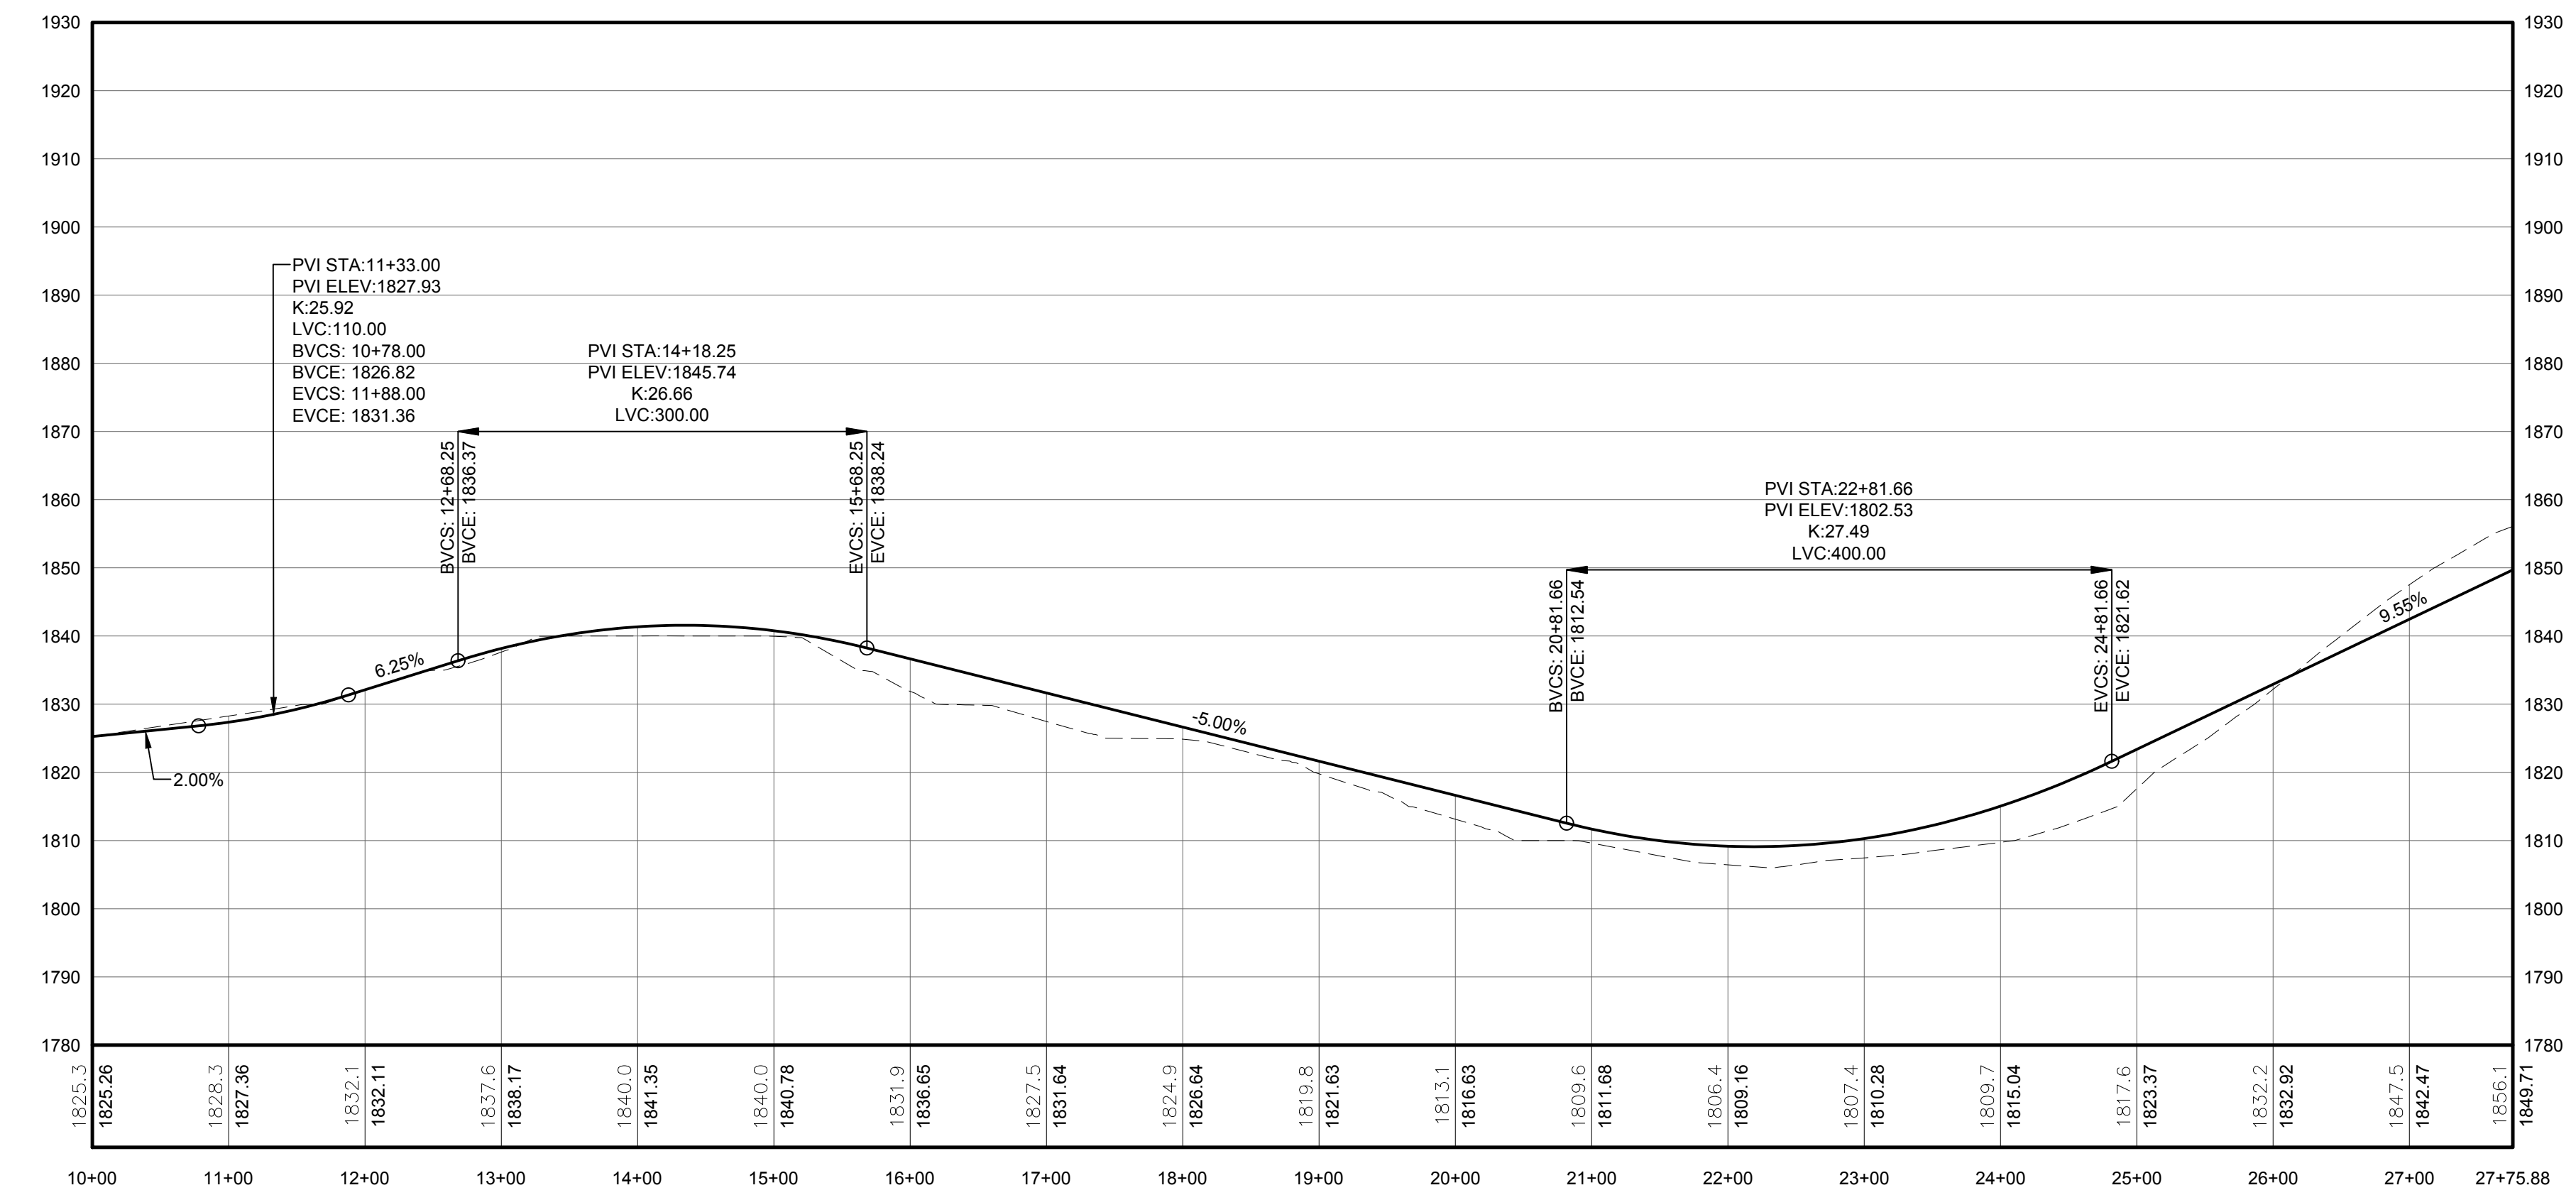

**2 ACCESS ROAD PROFILE**  
Scale: H:1"=100' V:1"=20'



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NO.	DATE	REVISION

PROJECT TITLE: **CASSADAGA WIND PROJECT**  
TOWNS OF CHARLOTTE, CHERRY CREEK, ARKWRIGHT, AND STOCKTON  
PROJECT LOCATION: CHAUTAUGUA COUNTY, NEW YORK  
CLIENT: CASSADAGA WIND LLC  
DRAWING TITLE: **ACCESS ROAD PLAN AND PROFILE**

DATE:	APRIL 22, 2016
SCALE:	AS NOTED
EDR JOB#:	14048
DRAWN BY:	AW, CB, ZR
CHECKED BY:	TD
FILE NAME:	14048_Working_NW.dwg
DRAWING NUMBER:	<b>NW-110</b>






STORMWATER KEY NOTES	
ITEM	SYMBOL
VEGETATIVE FILTER STRIP	(A)
LEVEL SPREADER	(B)
DRY SWALE	(C)


NOTE: SEE SHEET C-605 FOR DETAILS

LEGEND	
ITEM	SYMBOL
DRAWING SHEET MATCH LINE	--- DRAWING NUMBER --- DRAWING NUMBER
WIND TURBINE DESIGNATION	T53
PARCEL BOUNDARY	---
115 kV OVERHEAD GENERATOR LEAD LINE	---
115 kV OVERHEAD GENERATOR LEAD LINE POLE	⊙
UNDERGROUND COLLECTION LINE	---
OVERHEAD COLLECTION LINE	---
EXISTING CONTOUR (2' INTERVAL)	---
EXISTING CONTOUR - INDEX (2' INTERVAL)	---
CONTOUR - FINISHED (2' INTERVAL)	---
CONTOUR - FINISHED - INDEX (2' INTERVAL)	---
ACCESS ROAD CENTERLINE	---
PERMANENT ACCESS ROAD EDGE	---
STORM PIPE / CULVERT	---
NYSDEC WETLAND	---
WETLAND BOUNDARY	---
STREAM BOUNDARY	---
APPROXIMATE WETLAND BOUNDARY	---
APPROXIMATE STREAM BOUNDARY	---
ENVIRONMENTALLY SENSITIVE AREA - RESTRICTED ACCESS	---
ENVIRONMENTALLY SENSITIVE AREA	---
WIND TURBINE CONSTRUCTION SITE	---
ROTOR LAYDOWN	---
WIND TURBINE	---
GRAVEL PAD	---
WORK AREA	---
CRANE PAD	---

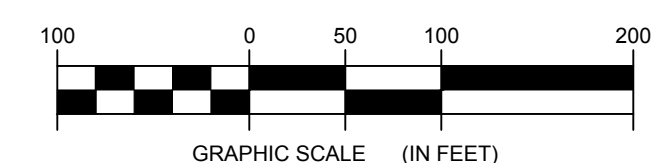


**FOR PERMITTING ONLY  
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**1 PLAN VIEW - TRUNK 53 ACCESS ROAD TO TURBINES T48 AND T53**  
Scale: 1"=100'

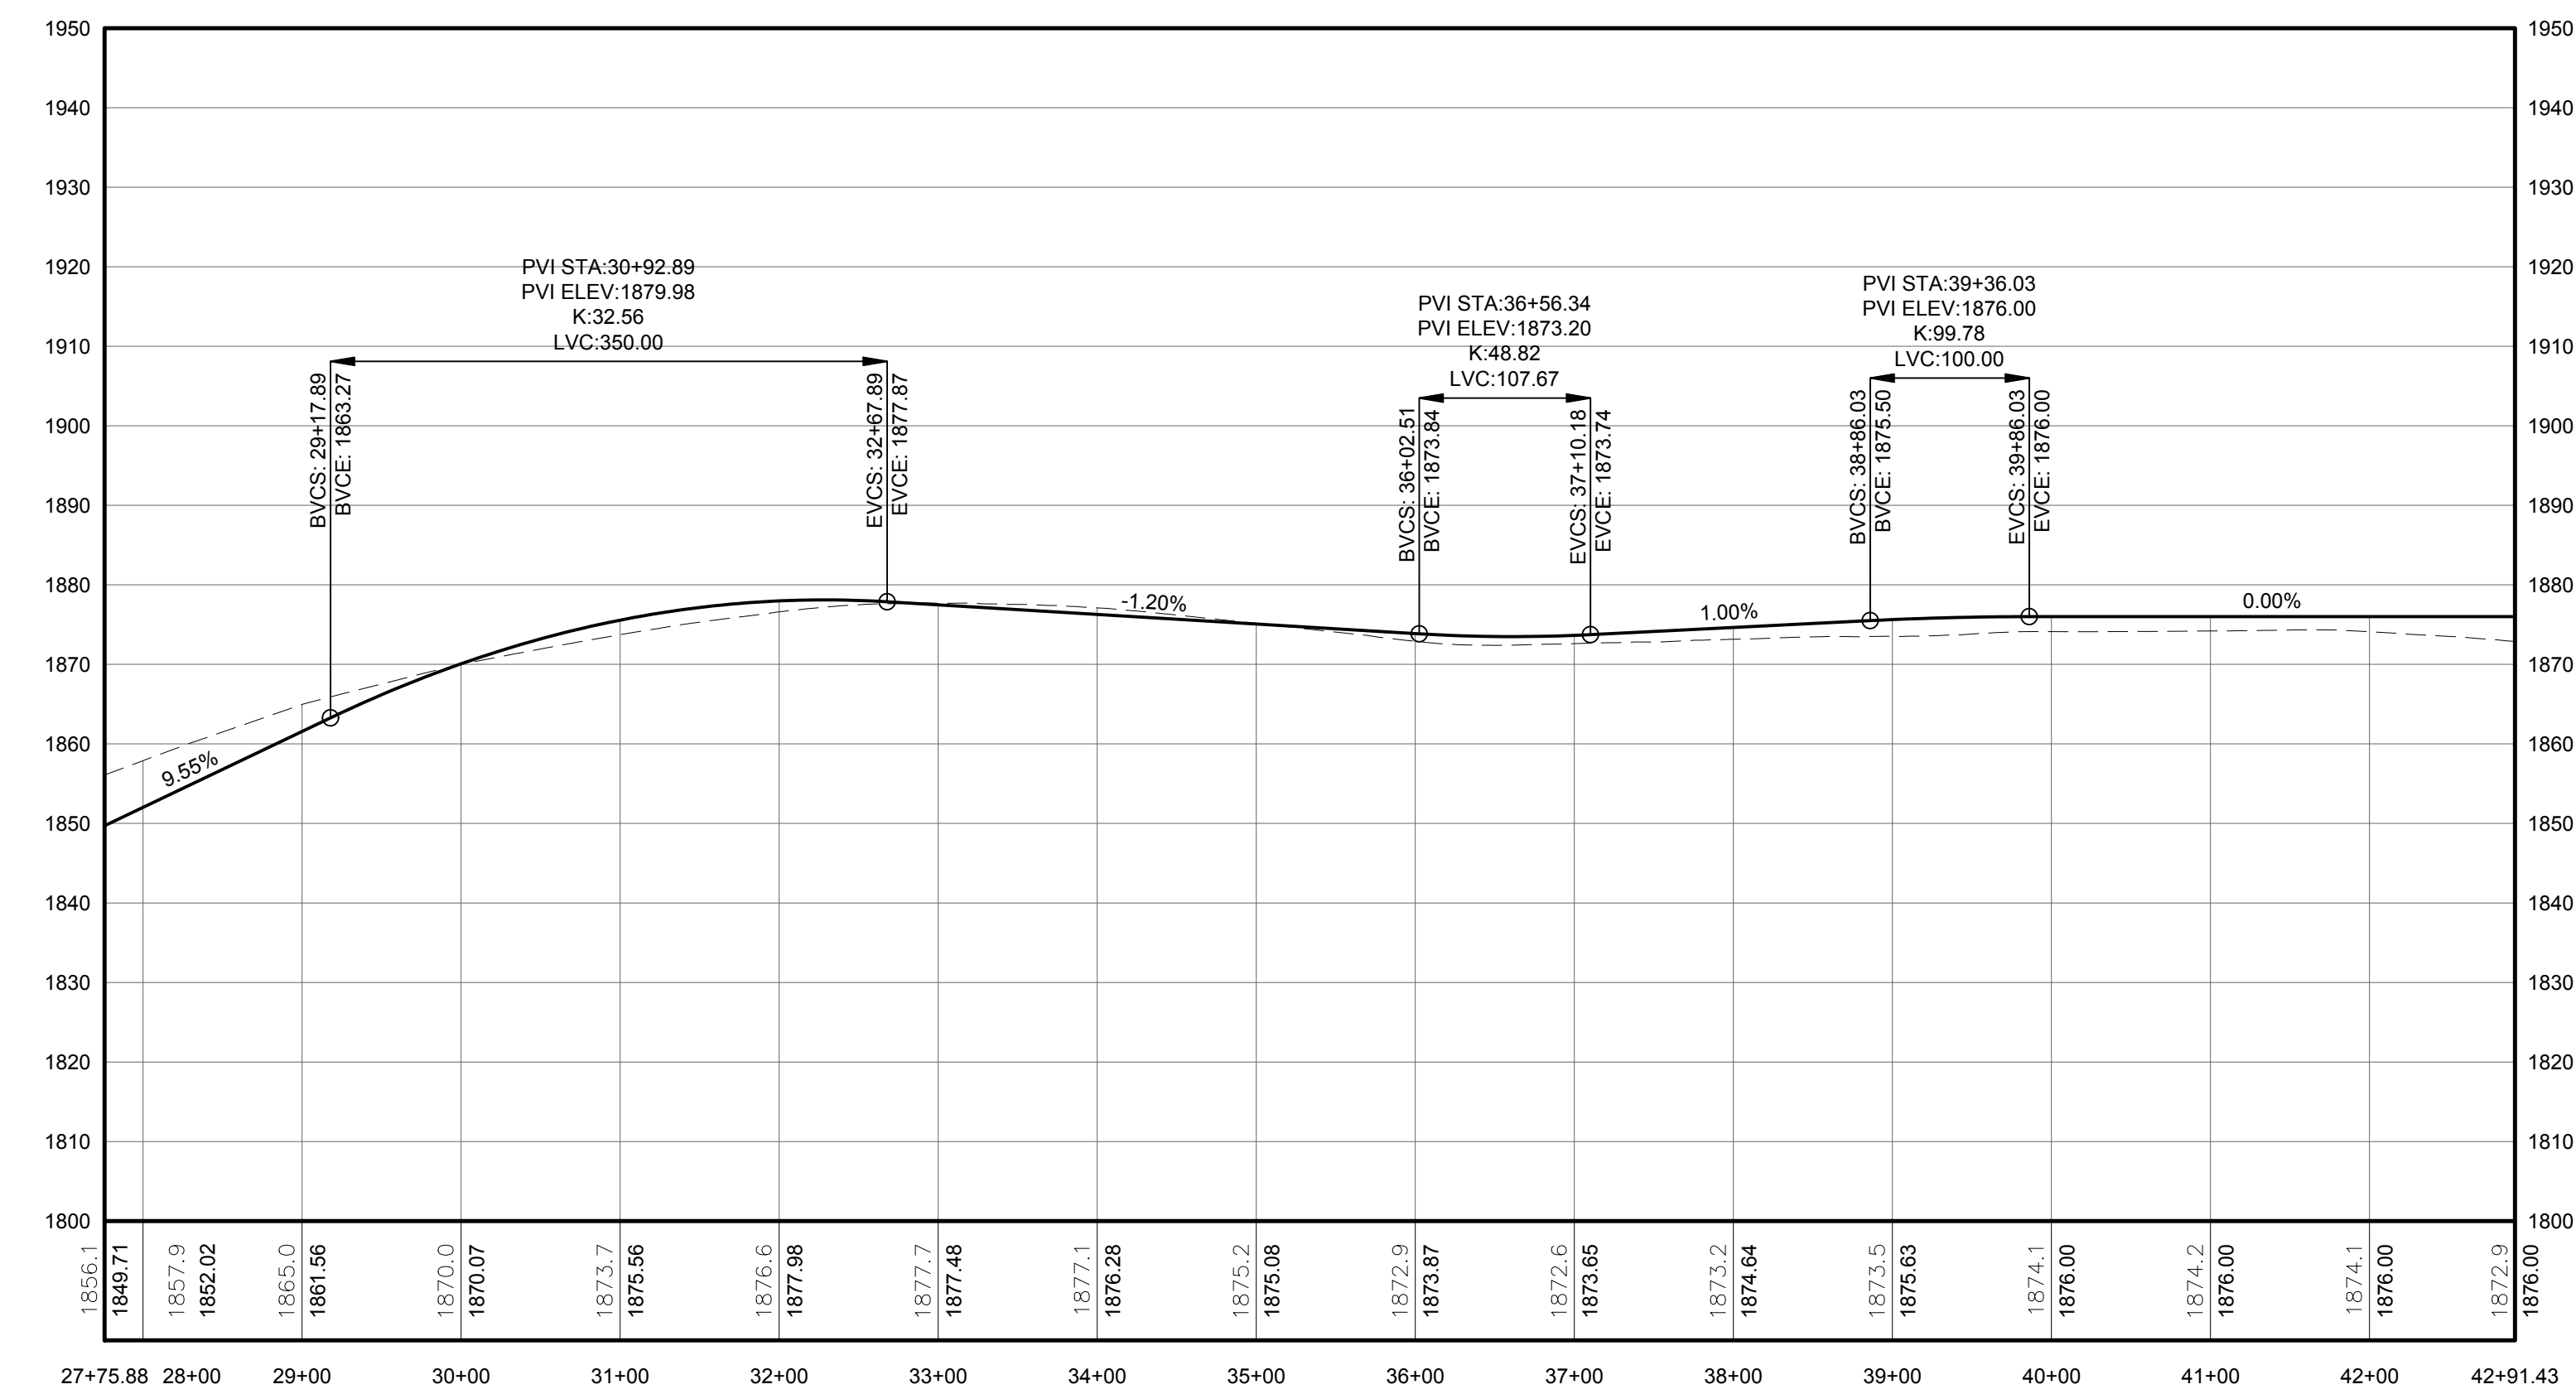

PROFILE LEGEND	
ITEM	SYMBOL
EXISTING ELEVATION (FT)	1845.3
PROPOSED ELEVATION (FT)	1845.27
EXISTING GRADE	---
PROPOSED GRADE	---

NOTE: ELEVATIONS IN USGS DATUM.

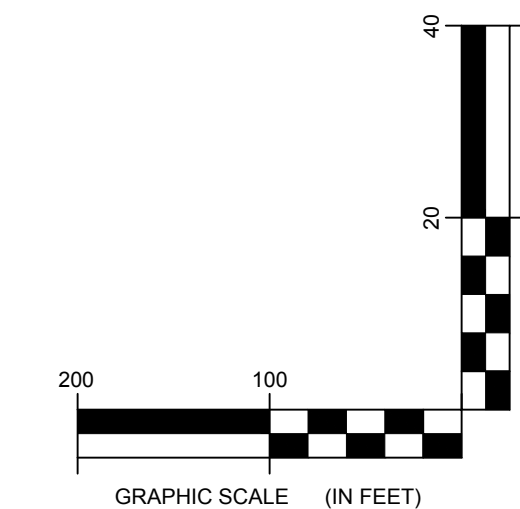

**2 ACCESS ROAD PROFILE**  
Scale: H:1"=100' V:1"=20'



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NO.	DATE	REVISION

PROJECT TITLE: **CASSADAGA WIND PROJECT**  
TOWNS OF CHARLOTTE, CHERRY CREEK, ARKWRIGHT, AND STOCKTON  
PROJECT LOCATION: CHAUTAUGUS COUNTY, NEW YORK  
CLIENT: CASSADAGA WIND LLC  
DRAWING TITLE: **ACCESS ROAD PLAN AND PROFILE**

DATE: **APRIL 22, 2016**  
SCALE: **AS NOTED**  
JOB#: **14048**  
DRAWN BY: **AW, CB, ZR**  
CHECKED BY: **TD**  
FILE NAME: **14048\_Working\_NW.dwg**  
DRAWING NUMBER: **NW-111**

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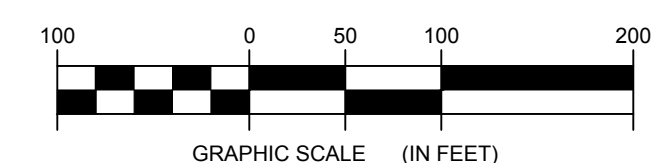




STORMWATER KEY NOTES	
ITEM	SYMBOL
VEGETATIVE FILTER STRIP	(A)
LEVEL SPREADER	(B)
DRY SWALE	(C)

NOTE: SEE SHEET C-605 FOR DETAILS

LEGEND	
ITEM	SYMBOL
DRAWING SHEET MATCH LINE	--- DRAWING NUMBER --- DRAWING NUMBER
WIND TURBINE DESIGNATION	T53
PARCEL BOUNDARY	---
115 KV OVERHEAD GENERATOR LEAD LINE	--- 115KV ---
115 KV OVERHEAD GENERATOR LEAD LINE POLE	o
UNDERGROUND COLLECTION LINE	---
OVERHEAD COLLECTION LINE	---
EXISTING CONTOUR (2' INTERVAL)	(490)
EXISTING CONTOUR - INDEX (2' INTERVAL)	(490)
CONTOUR - FINISHED (2' INTERVAL)	(490)
CONTOUR - FINISHED - INDEX (2' INTERVAL)	(490)
ACCESS ROAD CENTERLINE	---
PERMANENT ACCESS ROAD EDGE	---
STORM PIPE / CULVERT	--->---
NYSDEC WETLAND	▨
WETLAND BOUNDARY	▾ ▾ ▾
STREAM BOUNDARY	▬ ▬ ▬
APPROXIMATE WETLAND BOUNDARY	▾ ▾ ▾
APPROXIMATE STREAM BOUNDARY	▬ ▬ ▬
ENVIRONMENTALLY SENSITIVE AREA - RESTRICTED ACCESS	▨
ENVIRONMENTALLY SENSITIVE AREA	▨
WIND TURBINE CONSTRUCTION SITE	(A) (B) (C)
ROTOR LAYDOWN	○
WIND TURBINE	●
GRAVEL PAD	▭
WORK AREA	▭
CRANE PAD	▭





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PROFILE LEGEND	
ITEM	SYMBOL
EXISTING ELEVATION (FT)	1845.3
PROPOSED ELEVATION (FT)	1845.27
EXISTING GRADE	---
PROPOSED GRADE	---

NOTE: ELEVATIONS IN USGS DATUM.


**1 PLAN VIEW - SPUR T48 ACCESS ROAD**  
Scale: 1"=100'

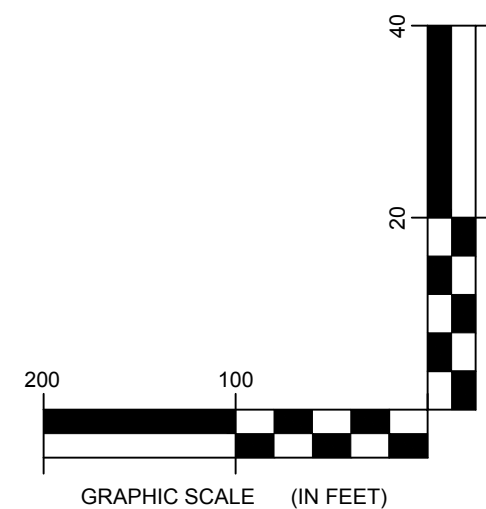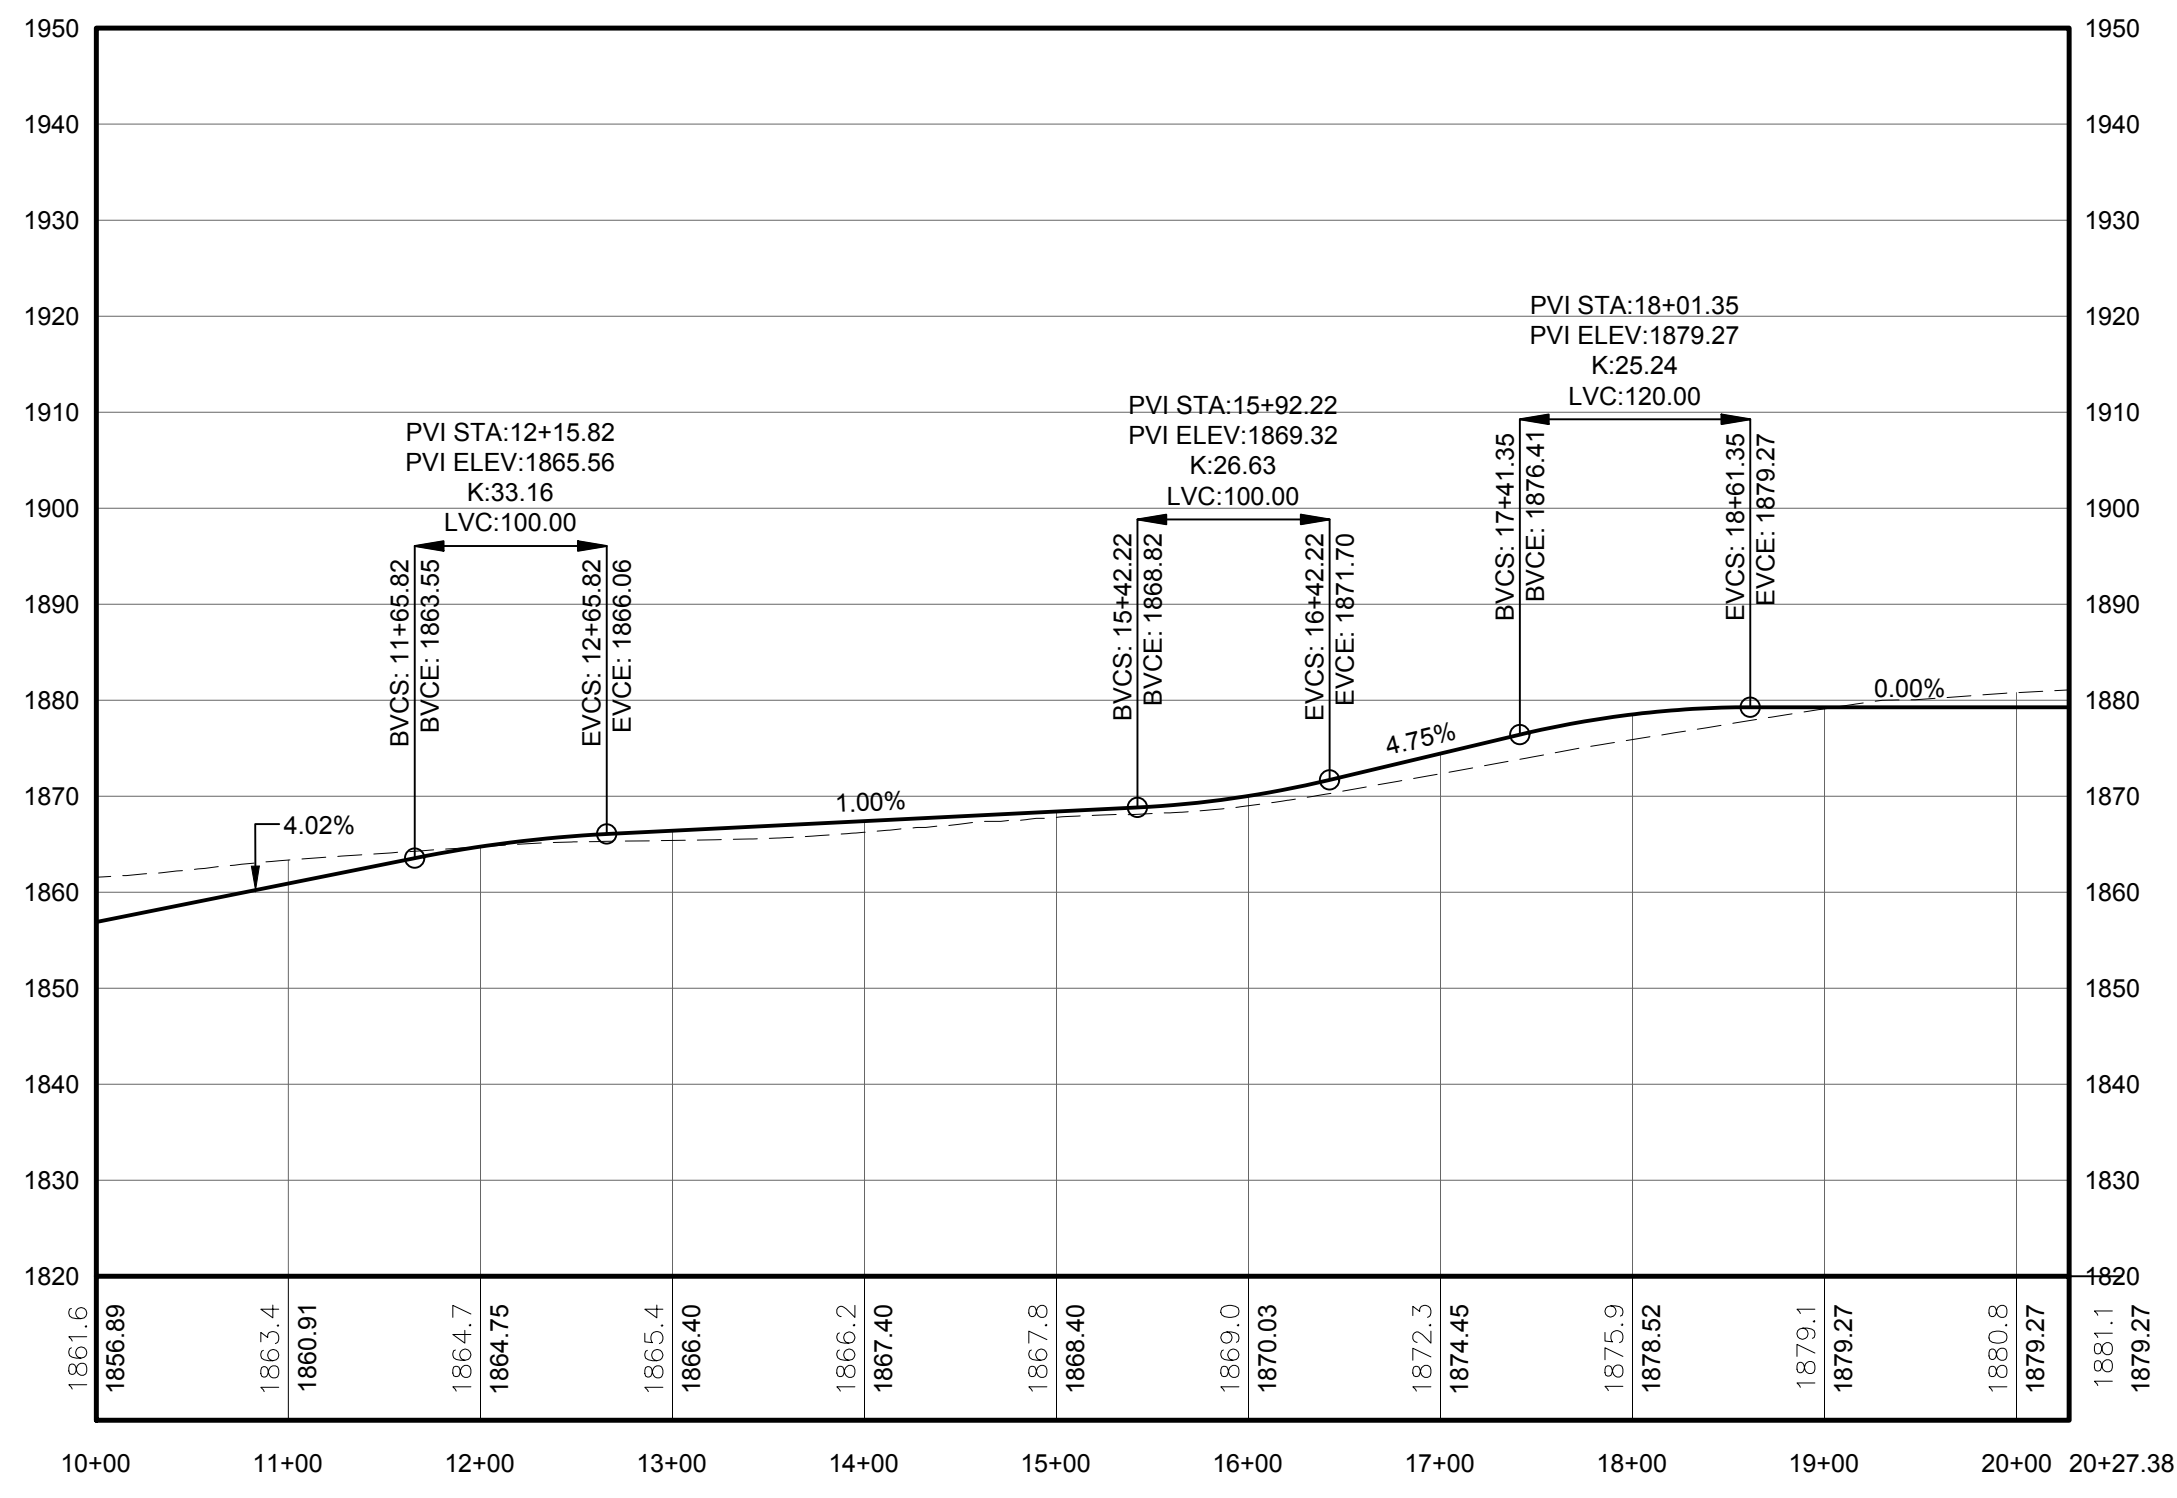

**2 ACCESS ROAD PROFILE**  
Scale: H:1"=100' V:1"=20'



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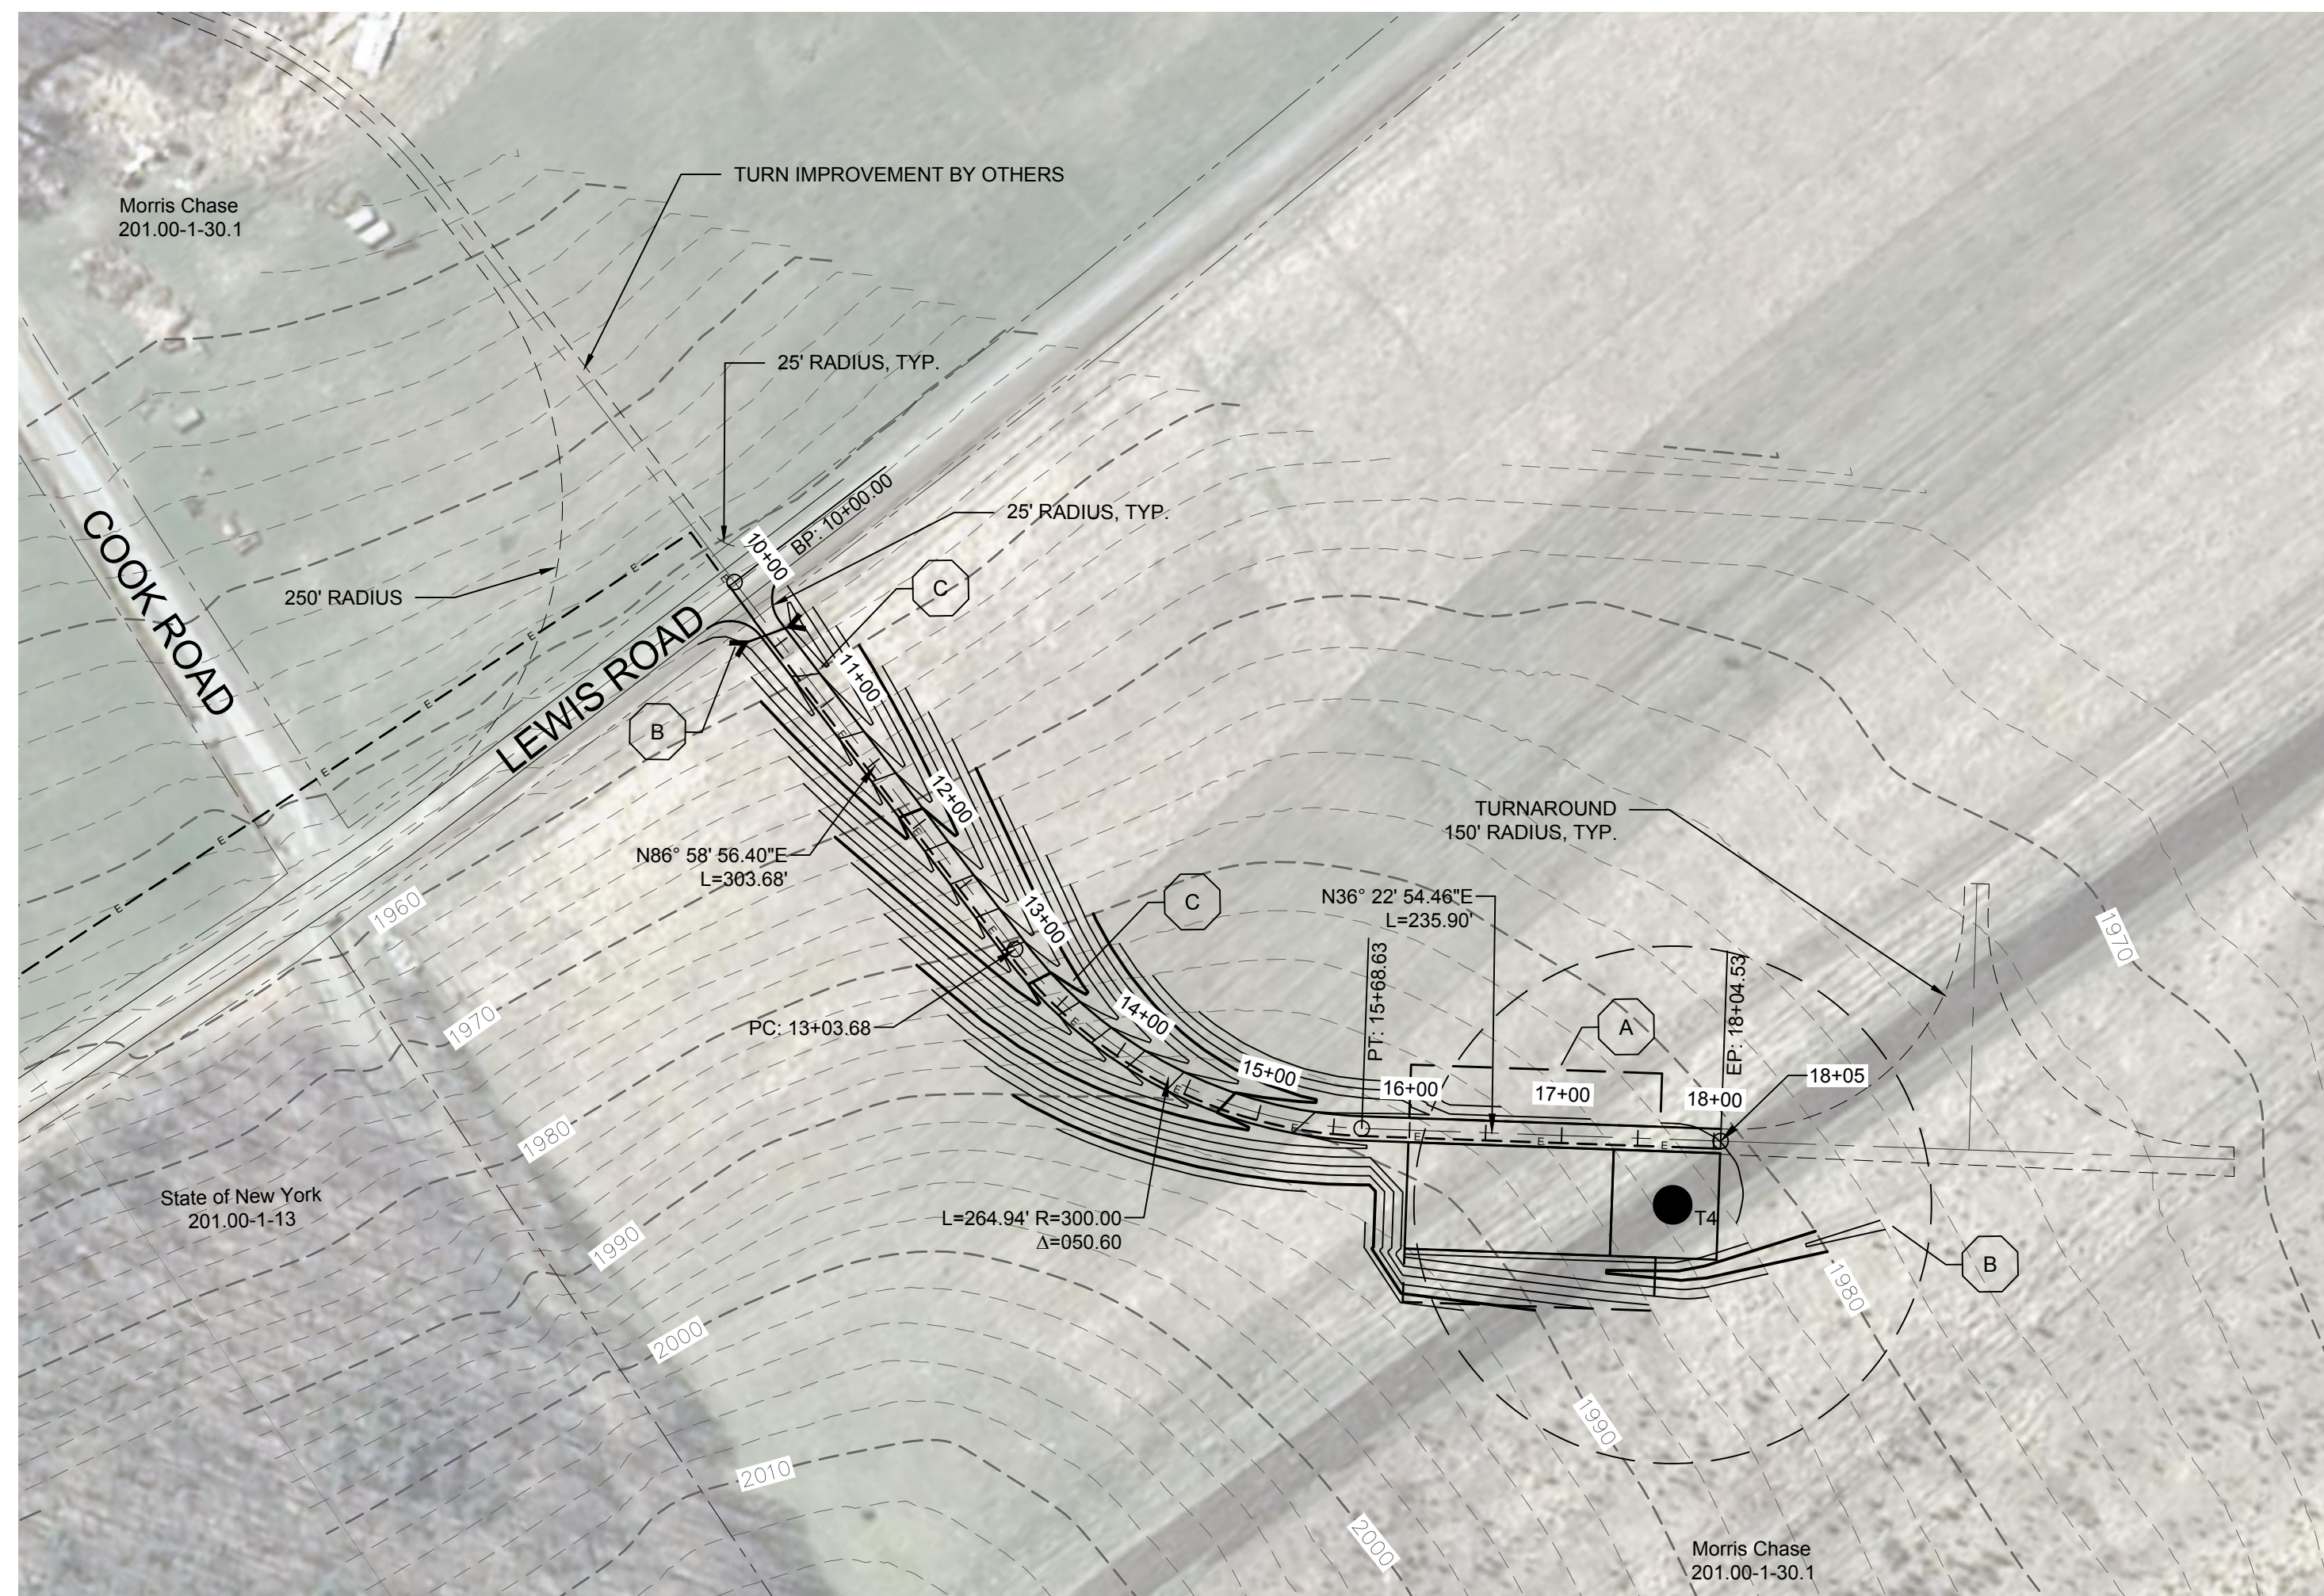


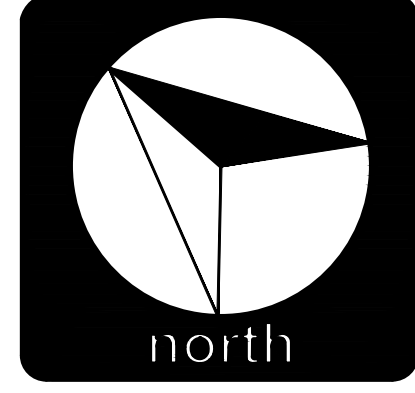DRAWING REVISIONS	
NO.	DATE

PROJECT TITLE: **CASSADAGA WIND PROJECT**  
 TOWNS OF CHARLOTTE, CHERRY CREEK, ARKWRIGHT, AND STOCKTON  
 PROJECT LOCATION: CHAUTAQUA COUNTY, NEW YORK  
 CLIENT: CASSADAGA WIND LLC  
 DRAWING TITLE: ACCESS ROAD PLAN AND PROFILE

DATE:	APRIL 22, 2016
SCALE:	AS NOTED
edr JOB:	14048
DRAWN BY:	AW, CB, ZR
CHECKED BY:	TD
FILE NAME:	14048_Working_NW.dwg
DRAWING NUMBER:	<b>NW-112</b>






1 PLAN VIEW - TRUNK T4 ACCESS ROAD  
Scale: 1"=100'

STORMWATER KEY NOTES	
ITEM	SYMBOL
VEGETATIVE FILTER STRIP	(A)
LEVEL SPREADER	(B)
DRY SWALE	(C)

NOTE: SEE SHEET C-605 FOR DETAILS


LEGEND	
ITEM	SYMBOL
DRAWING SHEET MATCH LINE	--- DRAWING NUMBER --- DRAWING NUMBER
WIND TURBINE DESIGNATION	T53
PARCEL BOUNDARY	---
115 KV OVERHEAD GENERATOR LEAD LINE	---
115 KV OVERHEAD GENERATOR LEAD LINE POLE	⊙
UNDERGROUND COLLECTION LINE	---
OVERHEAD COLLECTION LINE	---
EXISTING CONTOUR (2' INTERVAL)	---
EXISTING CONTOUR - INDEX (2' INTERVAL)	---
CONTOUR - FINISHED (2' INTERVAL)	---
CONTOUR - FINISHED - INDEX (2' INTERVAL)	---
ACCESS ROAD CENTERLINE	---
PERMANENT ACCESS ROAD EDGE	---
STORM PIPE / CULVERT	---
NYSDEC WETLAND	---
WETLAND BOUNDARY	---
STREAM BOUNDARY	---
APPROXIMATE WETLAND BOUNDARY	---
APPROXIMATE STREAM BOUNDARY	---
ENVIRONMENTALLY SENSITIVE AREA - RESTRICTED ACCESS	---
ENVIRONMENTALLY SENSITIVE AREA	---
WIND TURBINE CONSTRUCTION SITE	---
ROTOR LAYDOWN	---
WIND TURBINE	---
GRAVEL PAD	---
WORK AREA	---
CRANE PAD	---

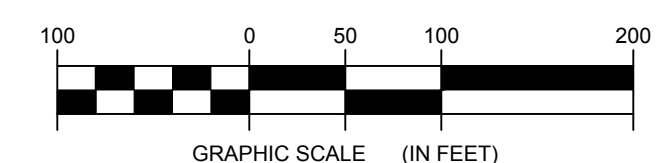



FOR PERMITTING ONLY  
NOT FOR CONSTRUCTION

PROFILE LEGEND	
ITEM	SYMBOL
EXISTING ELEVATION (FT)	1845.3
PROPOSED ELEVATION (FT)	1845.27
EXISTING GRADE	---
PROPOSED GRADE	---

NOTE: ELEVATIONS IN USGS DATUM.

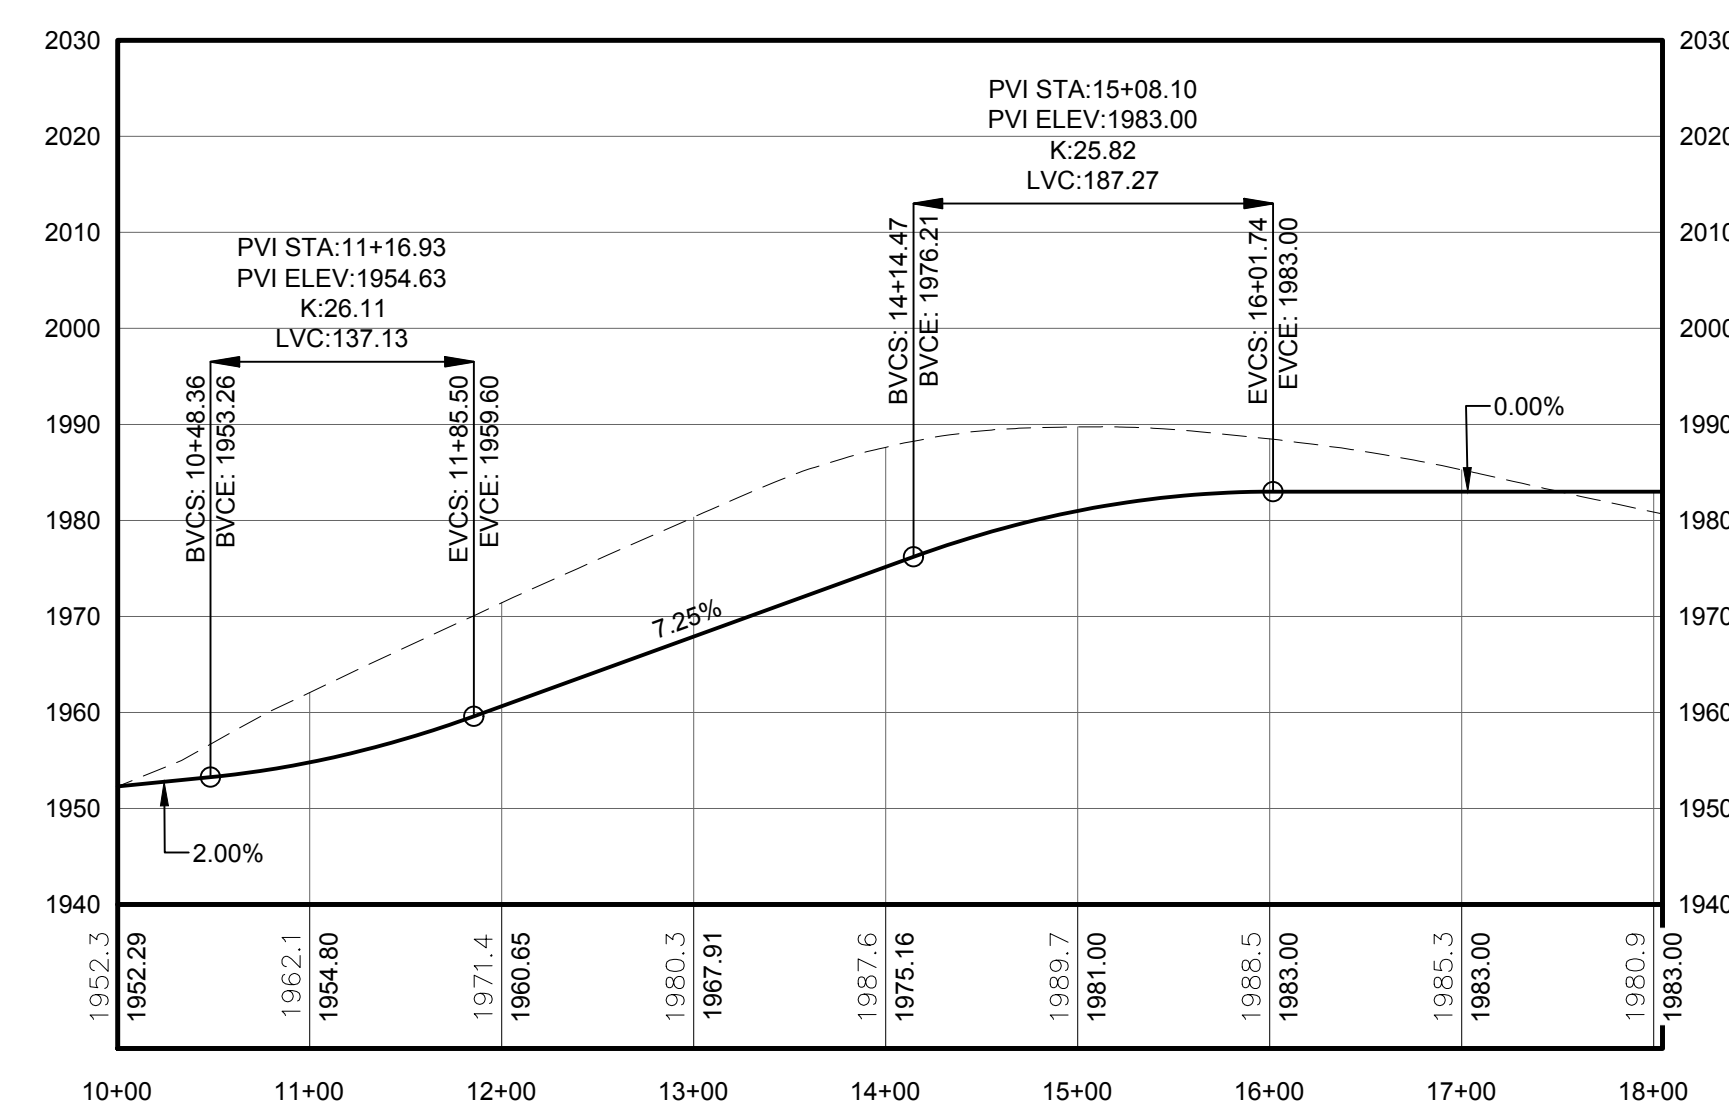

2 ACCESS ROAD PROFILE  
Scale: H:1"=100' V:1"=20'

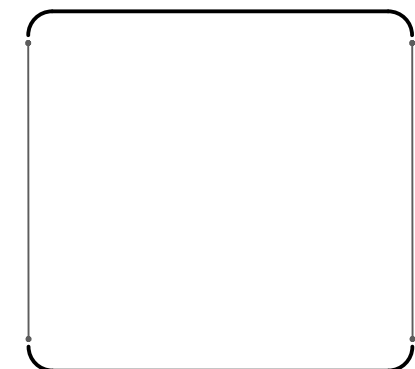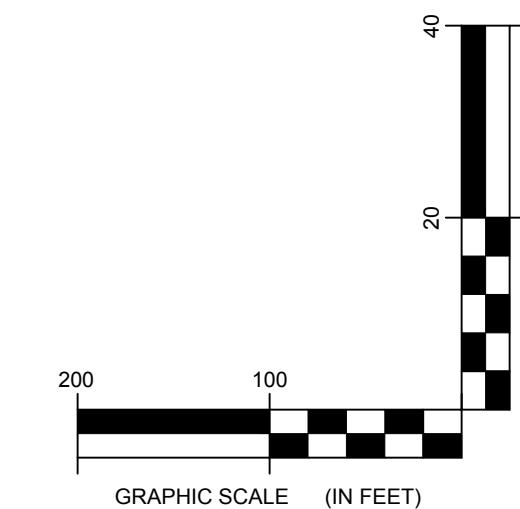


DRAWING REVISIONS	
NO.	DATE

PROJECT TITLE: <b>CASSADAGA WIND PROJECT</b>
TOWNS OF CHARLOTTE, CHERRY CREEK, ARKWRIGHT, AND STOCKTON
PROJECT LOCATION: CHAUTAQUA COUNTY, NEW YORK
CLIENT: CASSADAGA WIND LLC
DRAWING TITLE: ACCESS ROAD PLAN AND PROFILE

DATE: <b>APRIL 22, 2016</b>
SCALE: <b>AS NOTED</b>
edr JOB#: <b>14048</b>
DRAWN BY: <b>AW, CB, ZR</b>
CHECKED BY: <b>TD</b>
FILE NAME: <b>14048_Working_NW.dwg</b>
DRAWING NUMBER: <b>NW-113</b>


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DRAWING REVISIONS	
NO.	DATE

**PROJECT TITLE: CASSADAGA WIND PROJECT**  
TOWNS OF CHARLOTTE, CHERRY CREEK, ARKWRIGHT, AND STOCKTON  
PROJECT LOCATION: CHAUTAUGUA COUNTY, NEW YORK  
CLIENT: CASSADAGA WIND LLC  
DRAWING TITLE: COLLECTION LINE INDEX SHEET

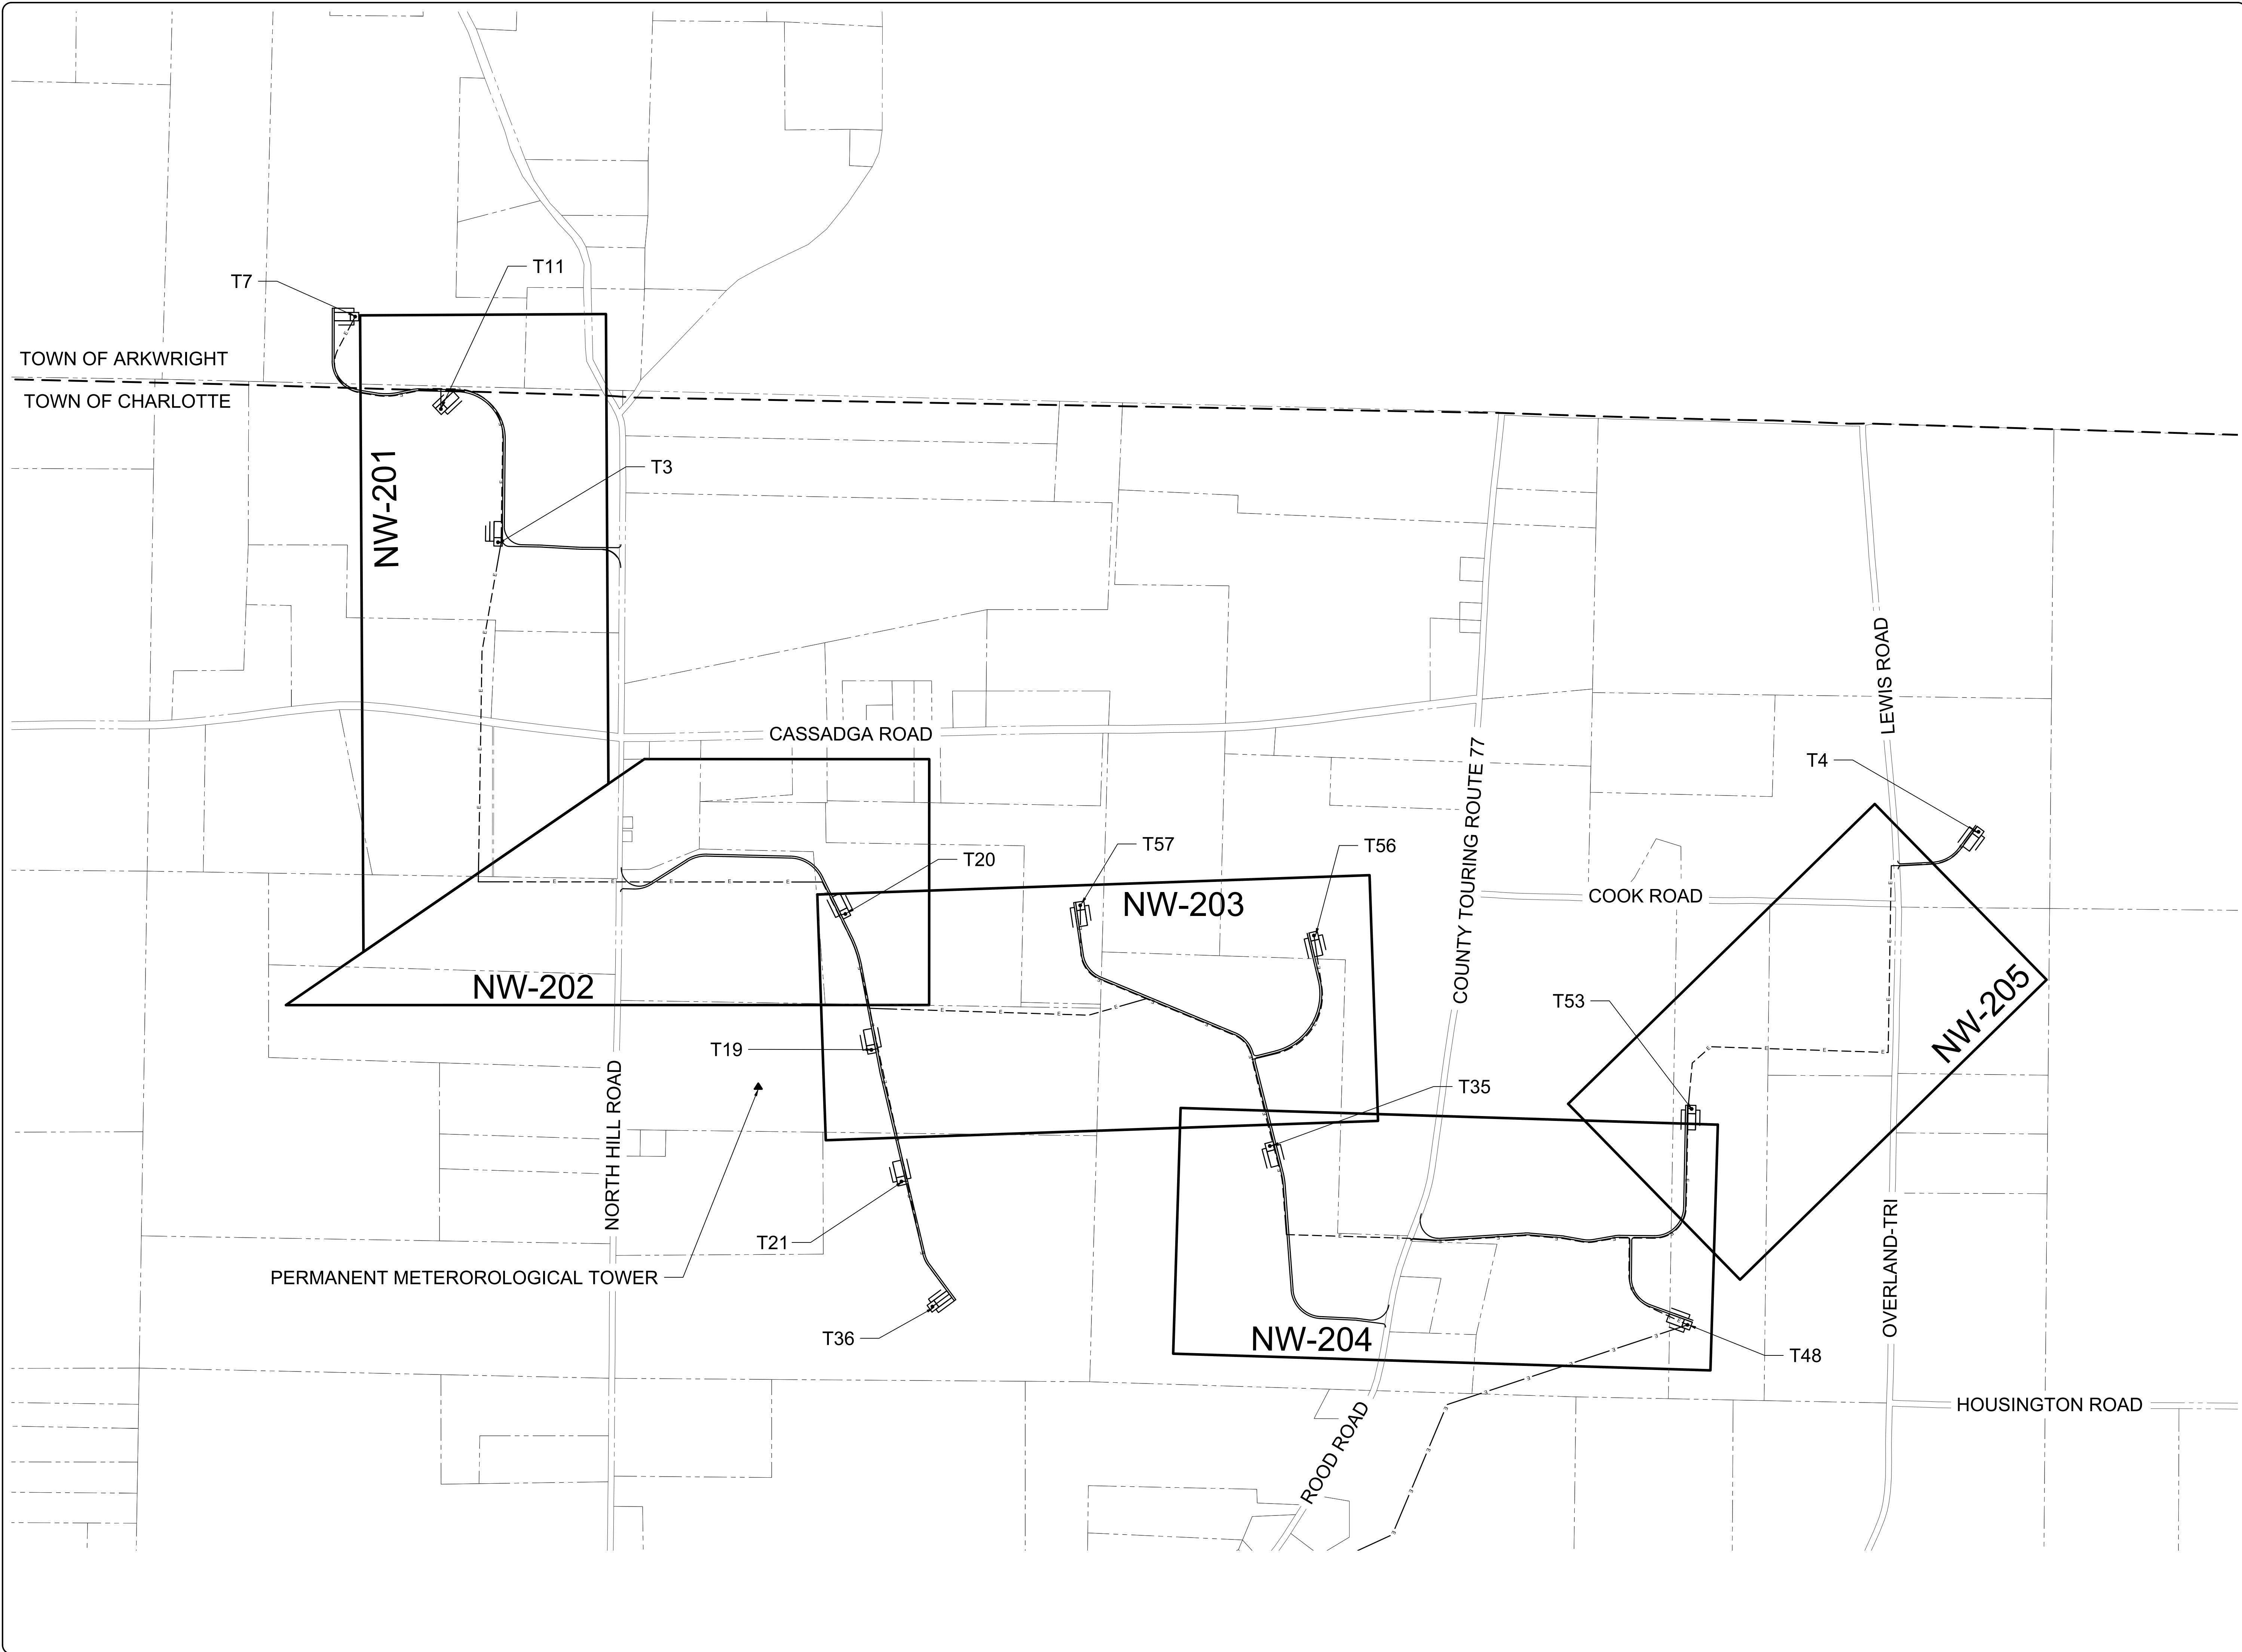
DATE: APRIL 22, 2016  
SCALE: NOT TO SCALE  
edr Job#: 14048  
DRAWN BY: AW, CB, ZR  
CHECKED BY: TD  
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DRAWING NUMBER:  
**NW-200**

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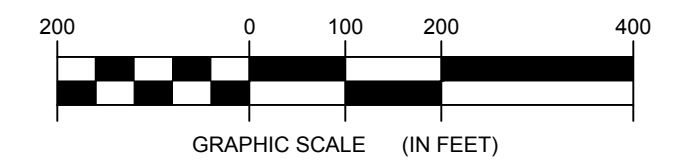




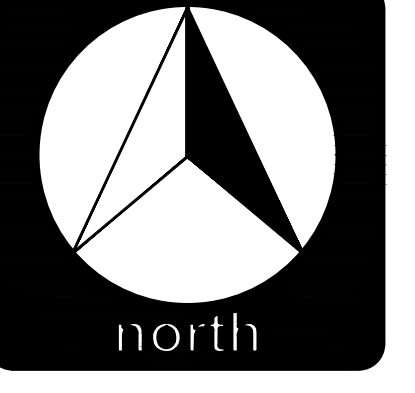

1 COLLECTION LINE PLAN VIEW - TRUNK T7 TO TRUNK T36  
202 Scale: 1"=200'

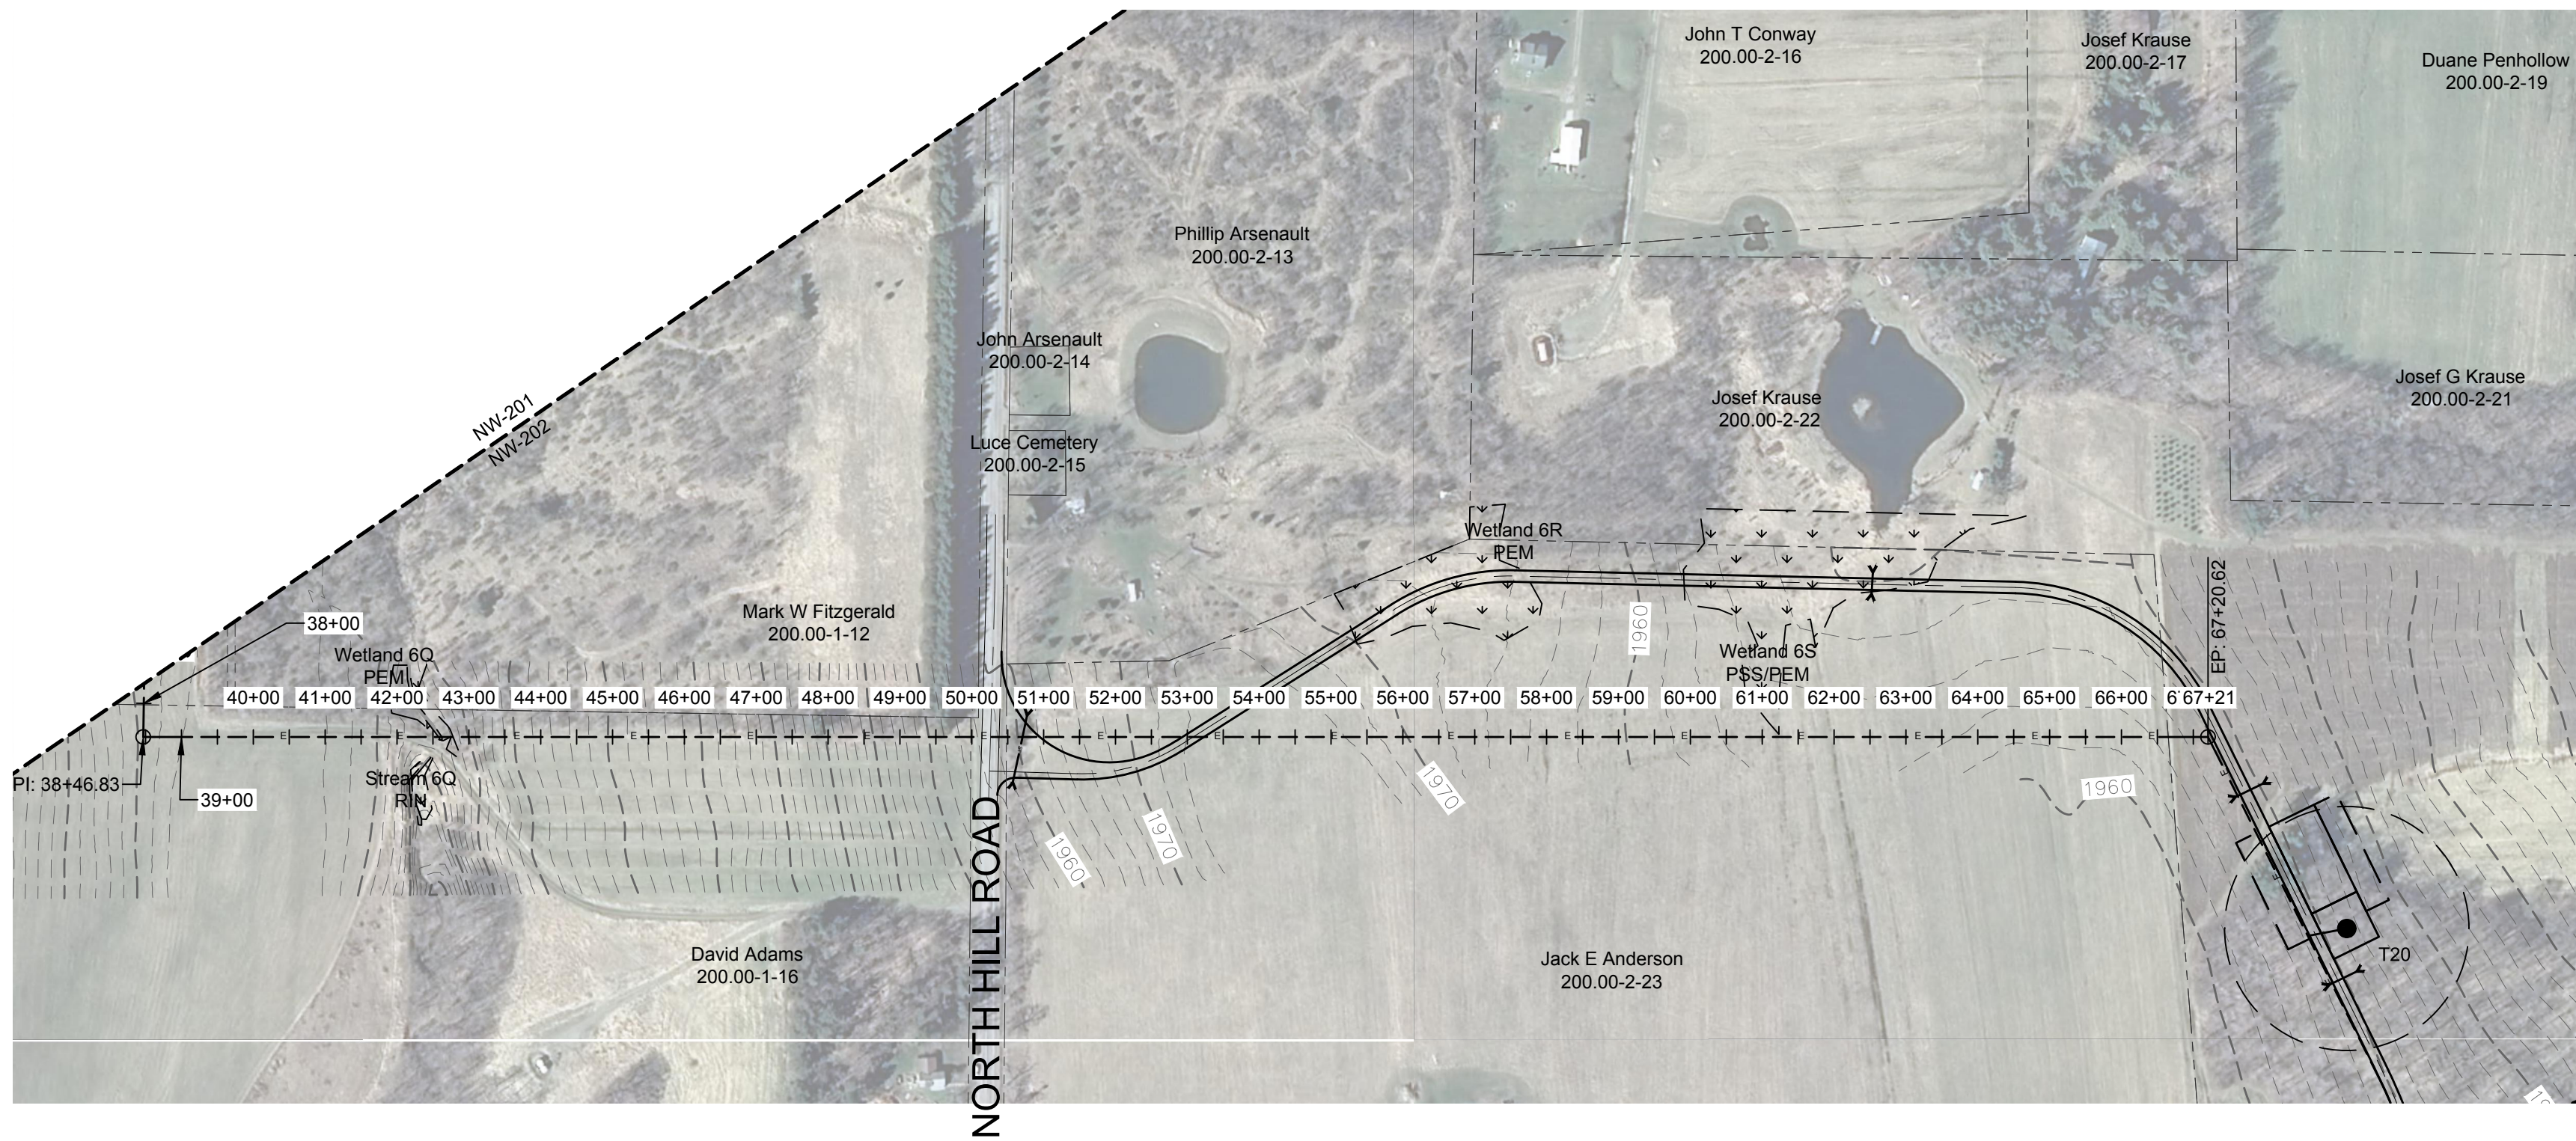
LEGEND	
ITEM	SYMBOL
DRAWING SHEET	---
MATCH LINE	---
WIND TURBINE DESIGNATION	T53
PARCEL BOUNDARY	---
115 KV OVERHEAD GENERATOR LEAD LINE	---
115 KV OVERHEAD GENERATOR LEAD LINE POLE	●
UNDERGROUND COLLECTION LINE	---
OVERHEAD COLLECTION LINE	---
EXISTING CONTOUR (2' INTERVAL)	---
EXISTING CONTOUR - INDEX (2' INTERVAL)	---
CONTOUR - FINISHED (2' INTERVAL)	---
CONTOUR - FINISHED - INDEX (2' INTERVAL)	---
ACCESS ROAD CENTERLINE	---
PERMANENT ACCESS ROAD EDGE	---
STORM PIPE / CULVERT	---
NYSDEC WETLAND	---
WETLAND BOUNDARY	---
STREAM BOUNDARY	---
APPROXIMATE WETLAND BOUNDARY	---
APPROXIMATE STREAM BOUNDARY	---
ENVIRONMENTALLY SENSITIVE AREA - RESTRICTED ACCESS	---
ENVIRONMENTALLY SENSITIVE AREA	---
WIND TURBINE CONSTRUCTION SITE	---
ROTOR LAYDOWN	---
WIND TURBINE	---
GRAVEL PAD	---
WORK AREA	---
CRANE PAD	---





**FOR PERMITTING ONLY  
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PROFILE LEGEND	
ITEM	SYMBOL
EXISTING ELEVATION (FT)	1845.3
EXISTING GRADE	---

NOTE: ELEVATIONS IN USGS DATUM.

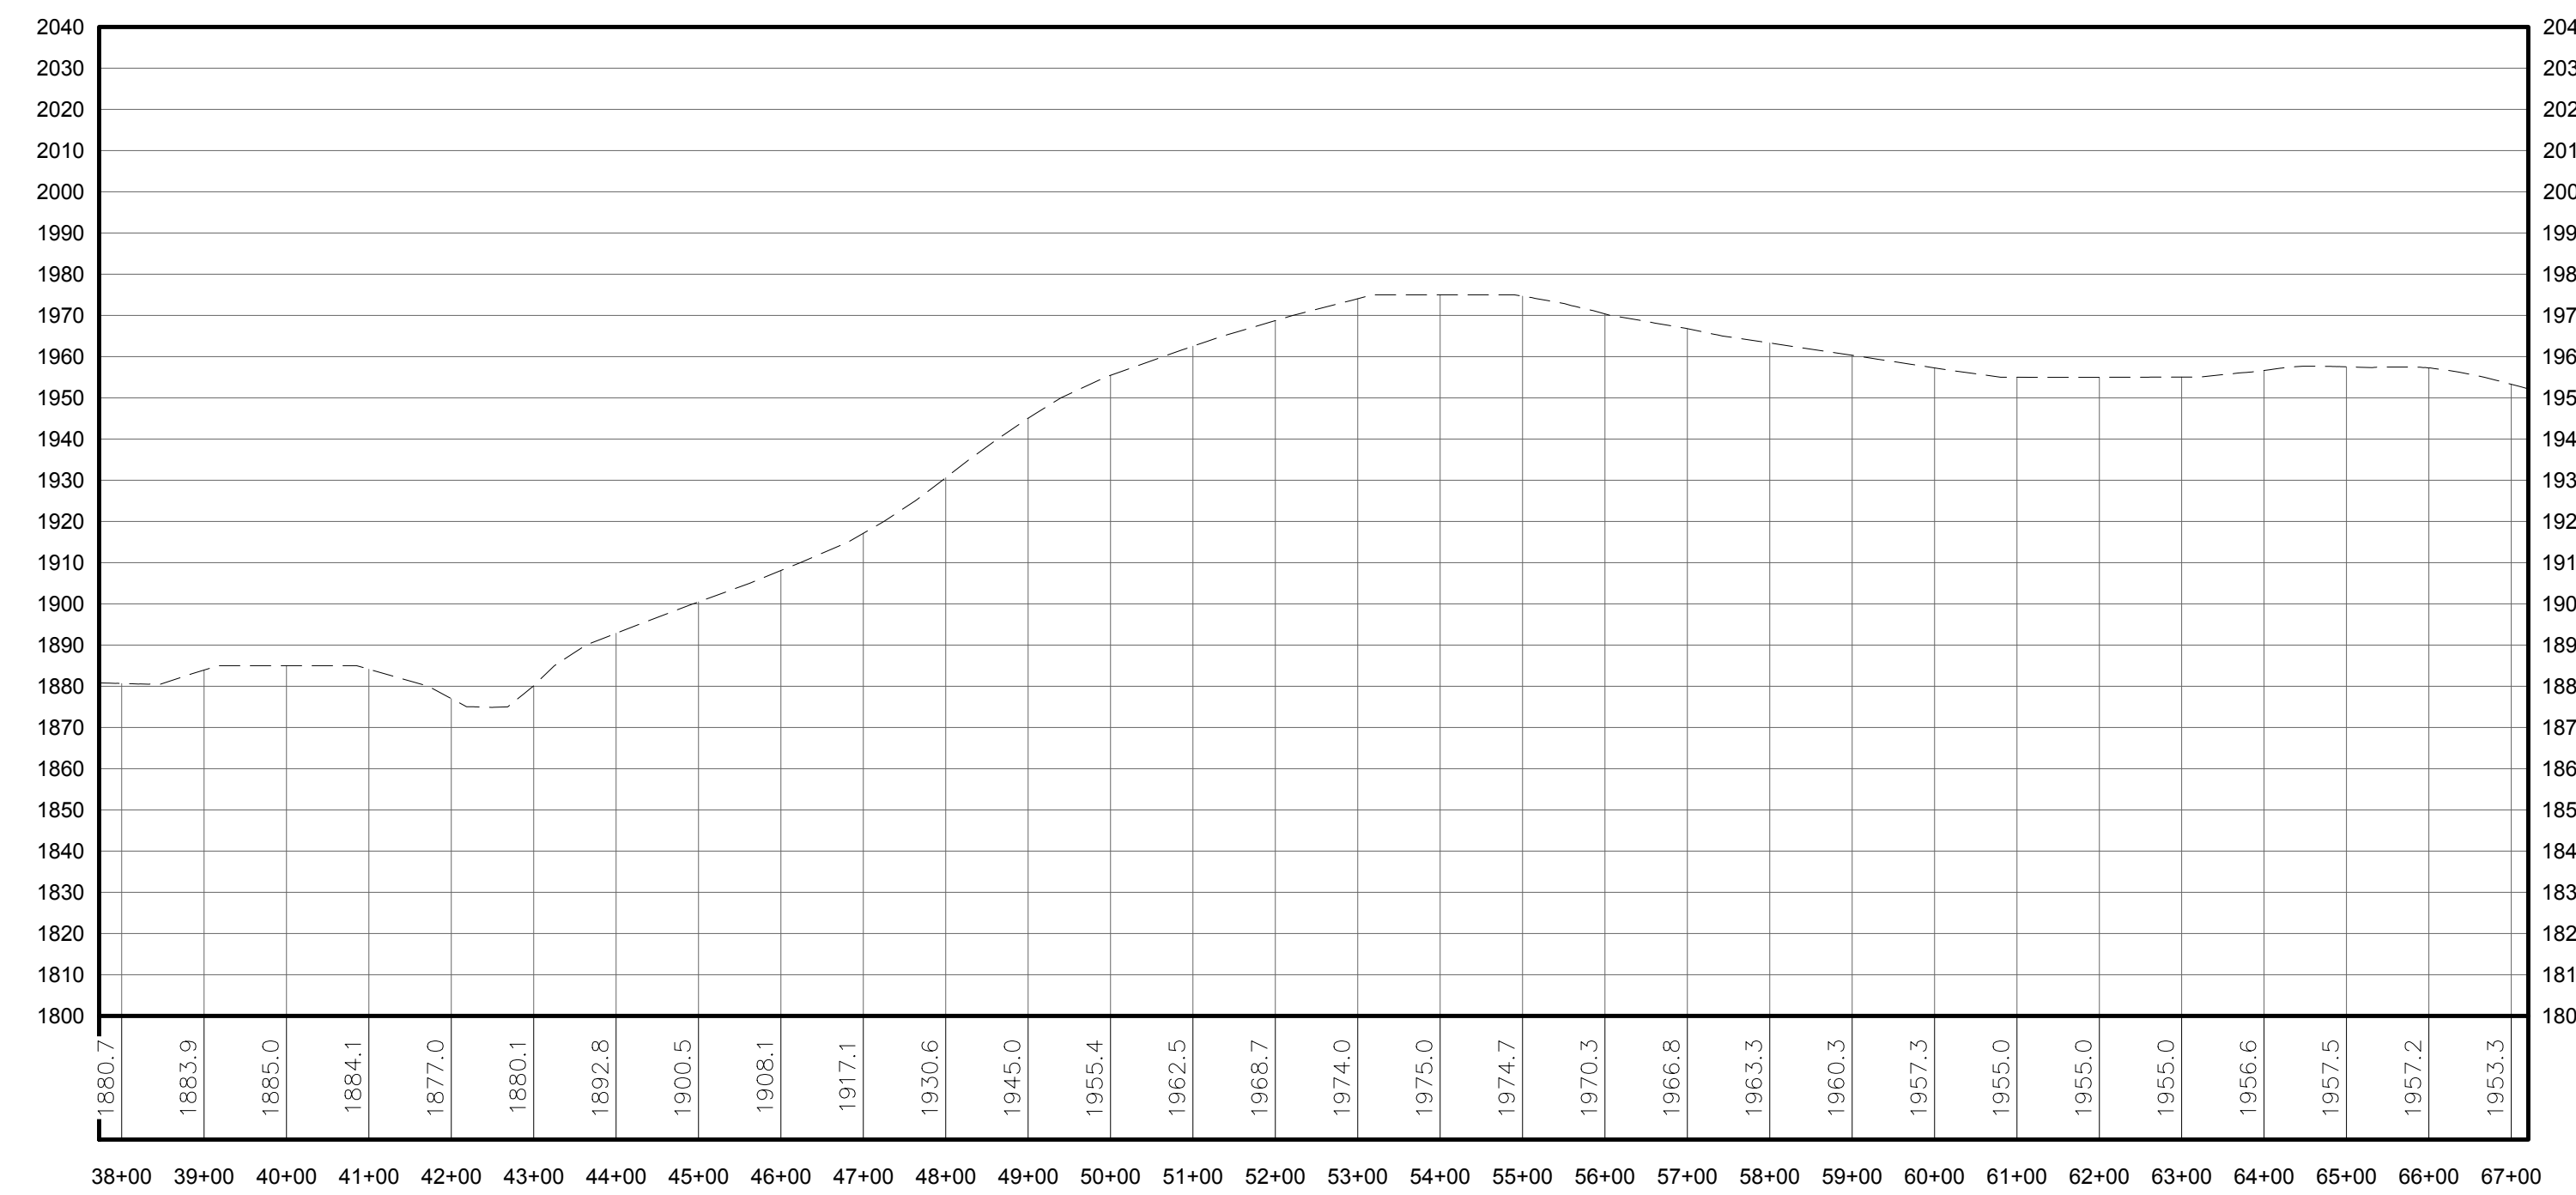

2 COLLECTION LINE PROFILE  
202 Scale: H:1"=200' V:1"=40'

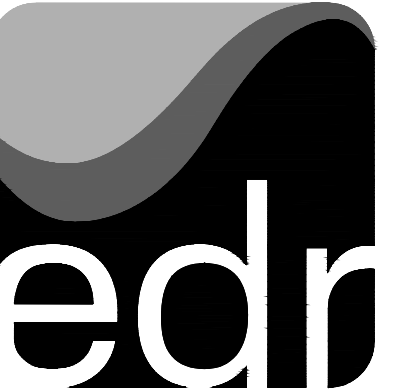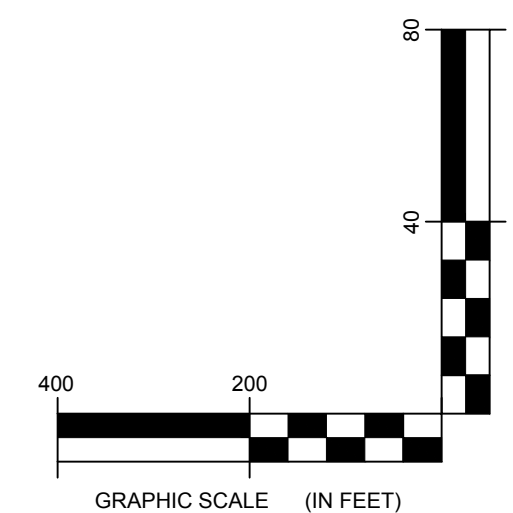

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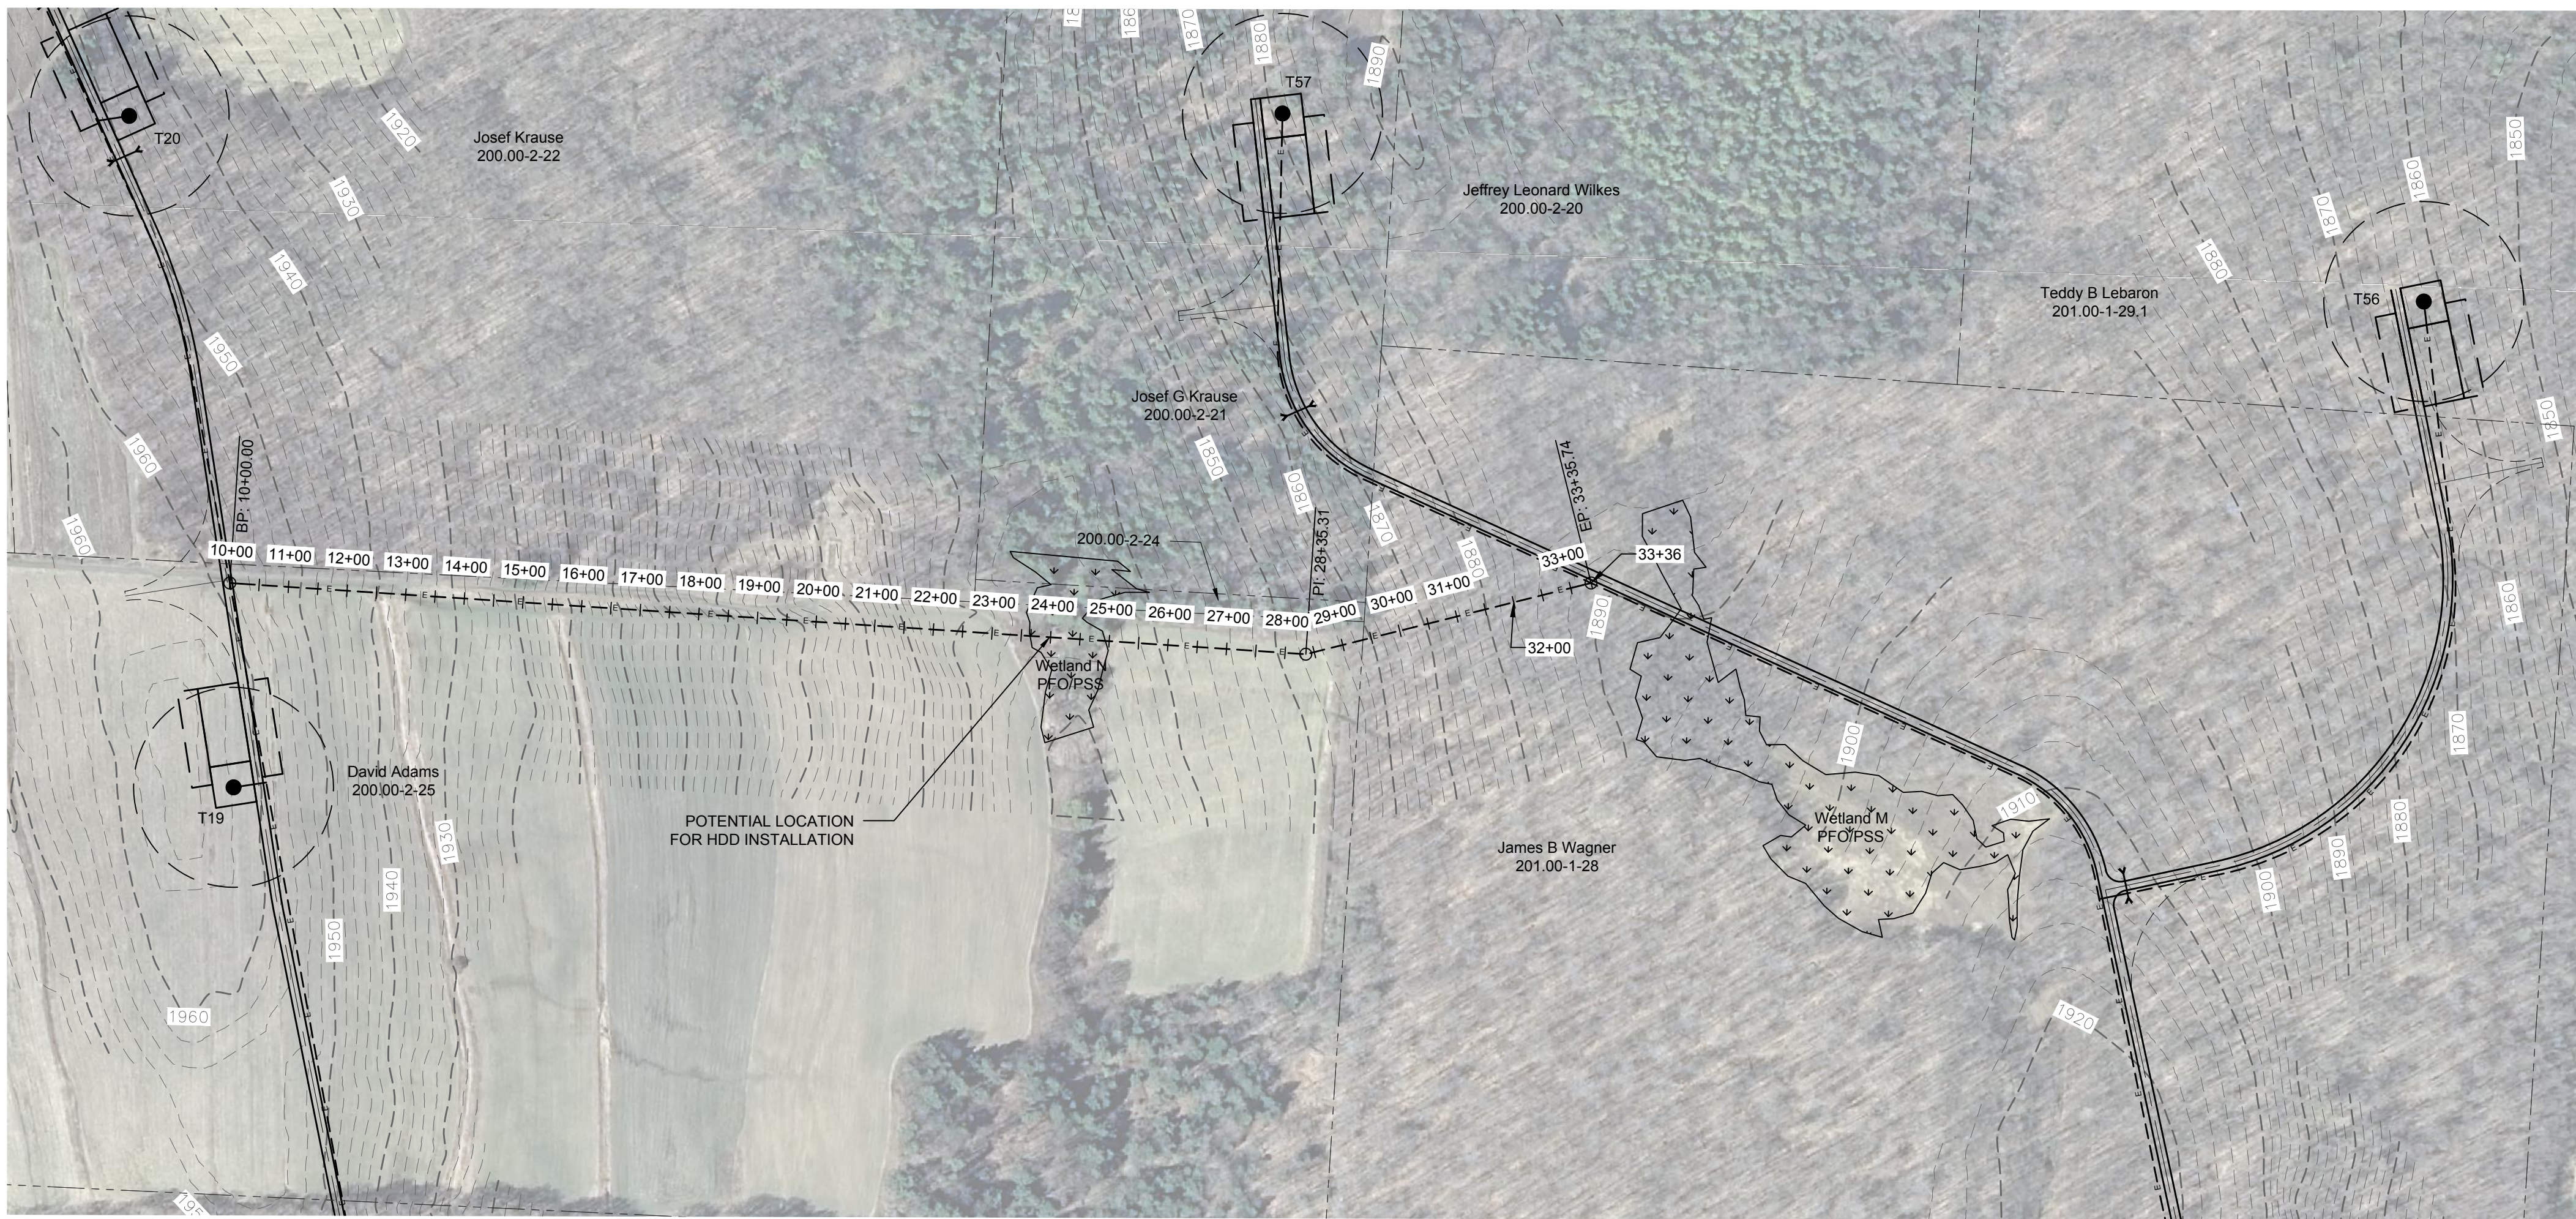
DRAWING REVISIONS	
NO.	DATE

PROJECT TITLE:	<b>CASSADAGA WIND PROJECT</b>
PROJECT LOCATION:	TOWNS OF CHARLOTTE, CHERRY CREEK, ARKWRIGHT, AND STOCKTON CHAUTAUGUS COUNTY, NEW YORK
CLIENT:	CASSADAGA WIND LLC
DRAWING TITLE:	COLLECTION LINE PLAN AND PROFILE

DATE:	APRIL 22, 2016
SCALE:	AS NOTED
EDR JOB#:	14048
DRAWN BY:	AW, CB, ZR
CHECKED BY:	TD
FILE NAME:	14048_Working_NW.dwg
DRAWING NUMBER:	<b>NW-202</b>

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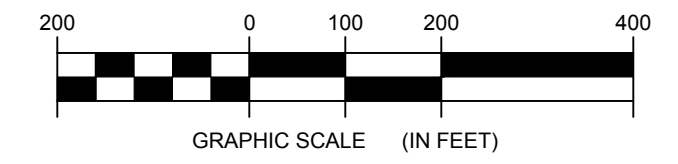




LEGEND	
ITEM	SYMBOL
OVERHEAD MATCH LINE	-----
WIND TURBINE DESIGNATION	T53
PARCEL BOUNDARY	-----
115 kV OVERHEAD GENERATOR LEAD LINE	----- 115kV -----
115 kV OVERHEAD GENERATOR LEAD LINE POLE	o
UNDERGROUND COLLECTION LINE	----- E ----- E -----
OVERHEAD COLLECTION LINE	----- E ----- E -----
EXISTING CONTOUR (2' INTERVAL)	----- (490) -----
EXISTING CONTOUR - INDEX (2' INTERVAL)	----- (490) -----
PERMANENT ACCESS ROAD EDGE	-----
PERMANENT ACCESS ROAD CENTERLINE	-----
STORM PIPE / CULVERT	----->-----<-----
NYSDEC WETLAND	-----
WETLAND BOUNDARY	-----
STREAM BOUNDARY	-----
APPROXIMATE WETLAND BOUNDARY	-----
APPROXIMATE STREAM BOUNDARY	-----
ARCHEOLOGICAL AREA TO AVOID	-----
ARCHEOLOGICAL AREA	-----
WIND TURBINE CONSTRUCTION SITE	-----
ROTOR LAYDOWN	-----
WIND TURBINE	-----
GRAVEL PAD	-----
WORK AREA	-----
CRANE PAD	-----

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**1** COLLECTION LINE PLAN VIEW - TRUNK T36 - TRUNK T57  
 203 Scale: 1"=200'




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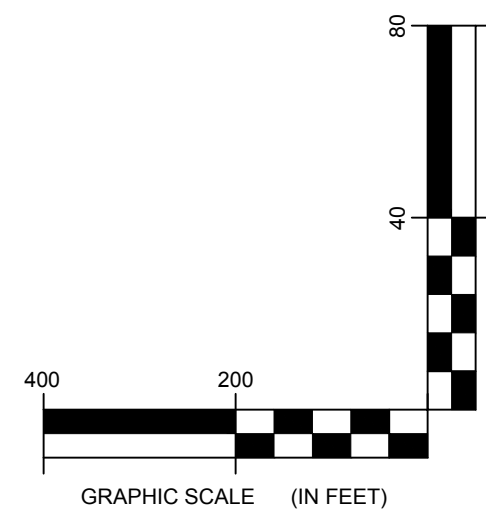
PROFILE LEGEND	
ITEM	SYMBOL
EXISTING ELEVATION (FT)	1845.3
EXISTING GRADE	-----

NOTE: ELEVATIONS IN USGS DATUM.

DRAWING REVISIONS	
NO.	DATE

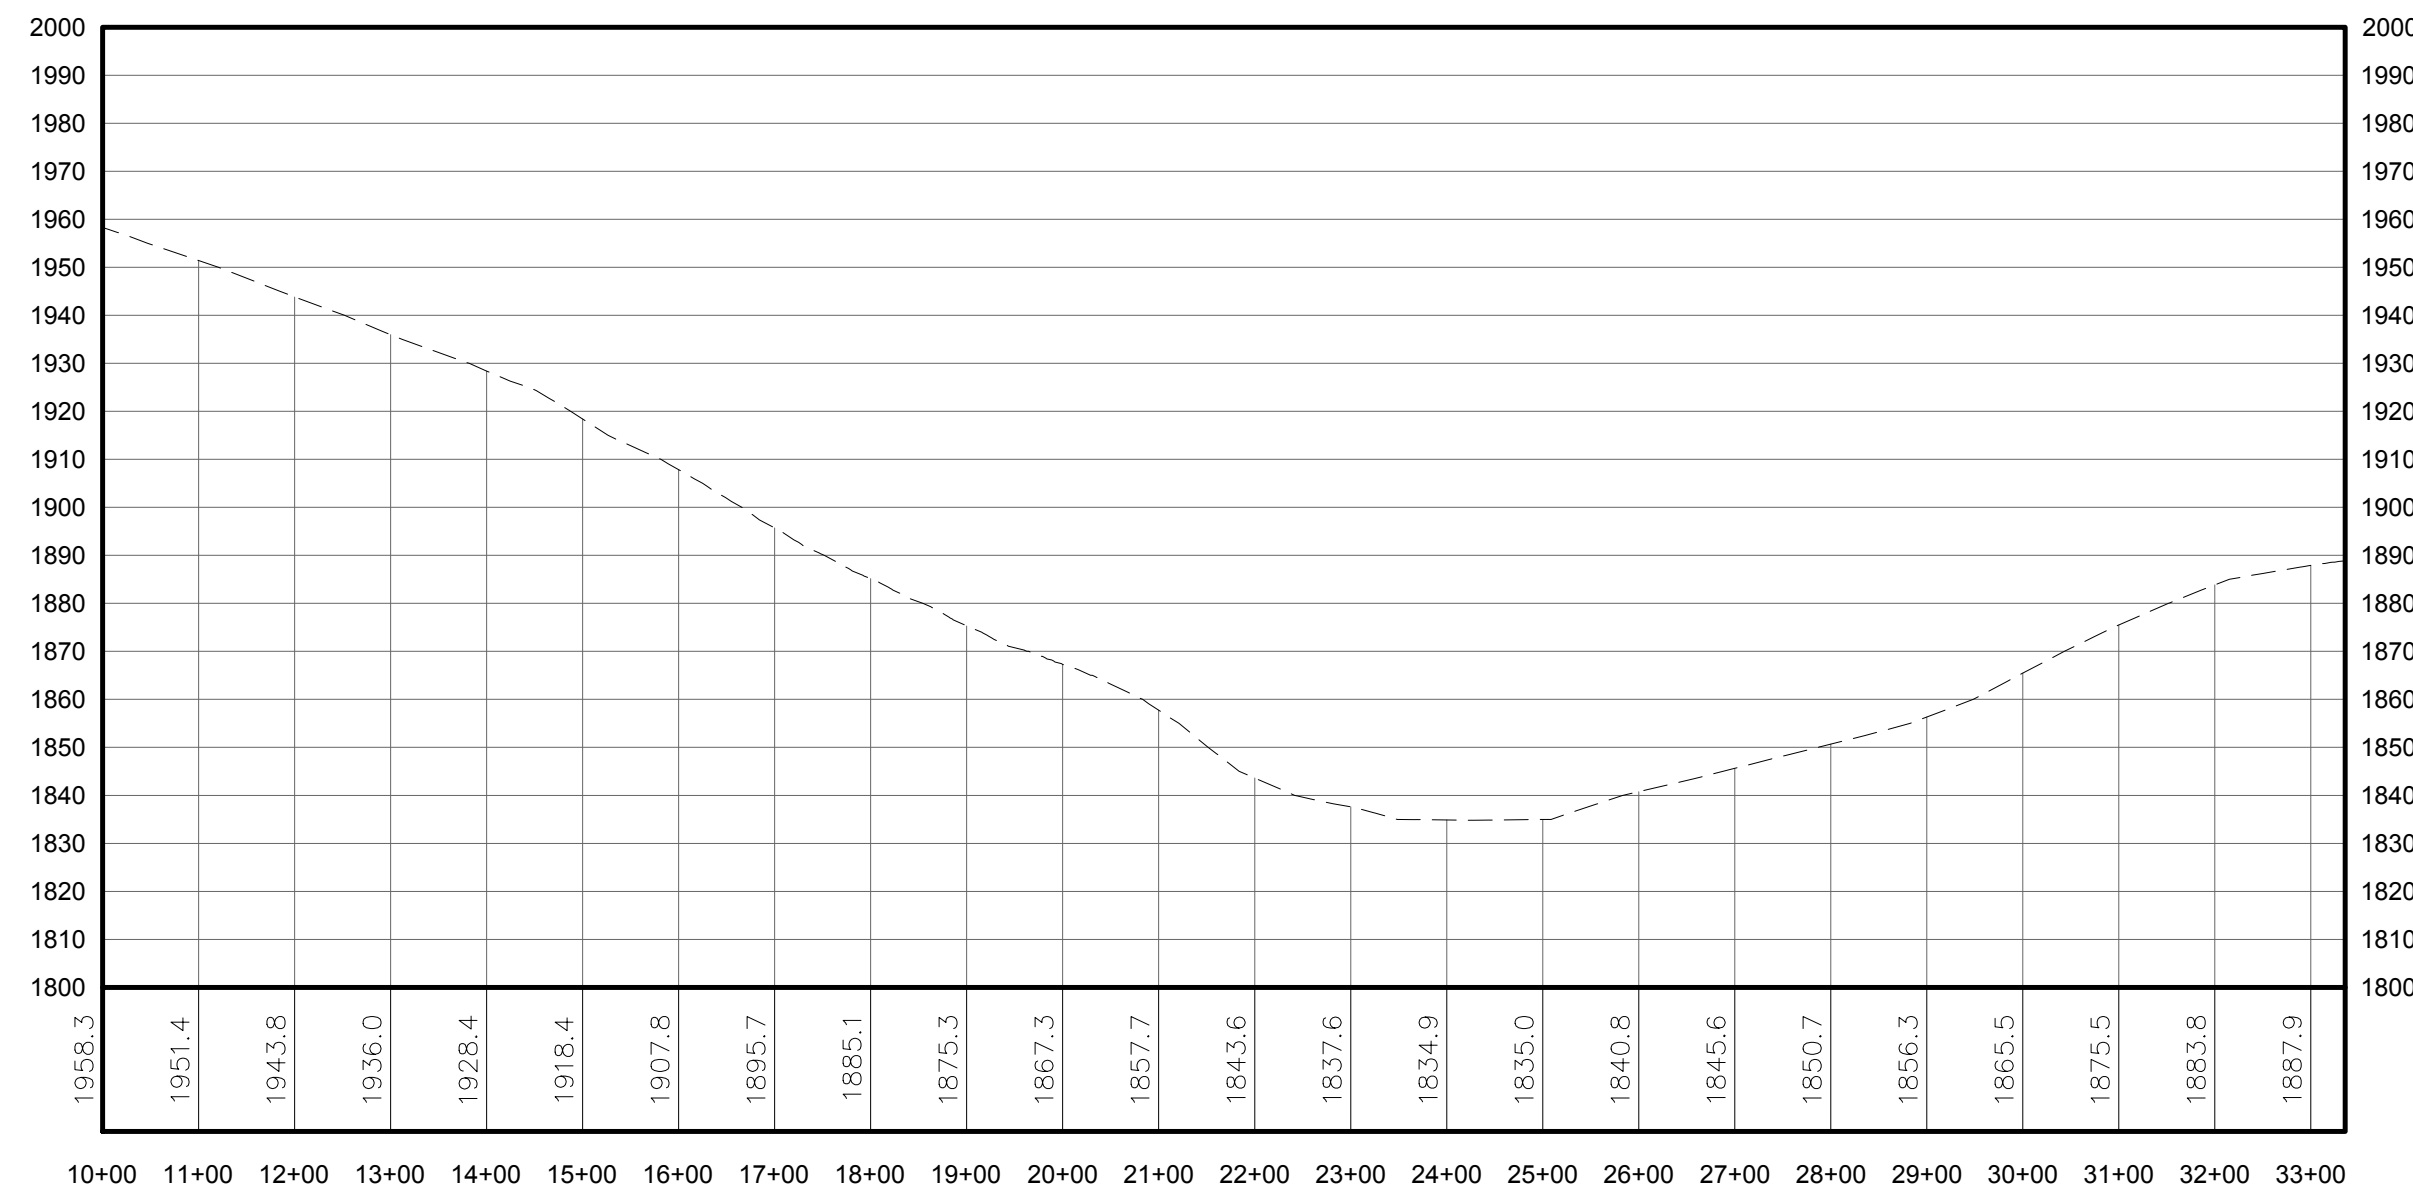

**2** COLLECTION LINE PROFILE  
 203 Scale: H:1"=200' V:1"=40'



**PROJECT TITLE: CASSADAGA WIND PROJECT**  
**TOWNS OF CHARLOTTE, CHERRY CREEK, ARKWRIGHT, AND STOCKTON**  
**PROJECT LOCATION: CHAUTAUGUS COUNTY, NEW YORK**  
**CLIENT: CASSADAGA WIND LLC**  
**DRAWING TITLE: COLLECTION LINE PLAN AND PROFILE**


DATE	APRIL 22, 2016
SCALE	AS NOTED
JOB NO.	14048
DRAWN BY:	AW, CB, ZR
CHECKED BY:	TD
FILE NAME:	14048_Working_NW.dwg
DRAWING NUMBER:	NW-203

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LEGEND	
ITEM	SYMBOL
DRAWING SHEET MATCH LINE	-----
WIND TURBINE DESIGNATION	T53
PARCEL BOUNDARY	---
115 kV OVERHEAD GENERATOR LEAD LINE	115kV
115 kV OVERHEAD GENERATOR LEAD LINE POLE	Ø
UNDERGROUND COLLECTION LINE	----
OVERHEAD COLLECTION LINE	—E—E—
EXISTING CONTOUR (2' INTERVAL)	-----
EXISTING CONTOUR - INDEX (2' INTERVAL)	----- (490) -----
PERMANENT ACCESS ROAD EDGE	---
PERMANENT ACCESS ROAD CENTERLINE	---
STORM PIPE / CULVERT	—+—+—+—
NYSDEC WETLAND	-----
WETLAND BOUNDARY	-----
STREAM BOUNDARY	-----
APPROXIMATE WETLAND BOUNDARY	-----
APPROXIMATE STREAM BOUNDARY	-----
ARCHEOLOGICAL AREA TO AVOID	-----
ARCHEOLOGICAL AREA	-----
WIND TURBINE CONSTRUCTION SITE	-----
ROTOR LAYDOWN	-----
WIND TURBINE	-----
GRAVEL PAD	-----
WORK AREA	-----
CRANE PAD	-----





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PROFILE LEGEND	
ITEM	SYMBOL
EXISTING ELEVATION (FT)	1845.3
EXISTING GRADE	-----

NOTE: ELEVATIONS IN USGS DATUM.

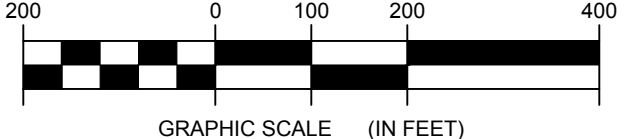**1** COLLECTION LINE PLAN VIEW - TRUNK T57 - TRUNK T53  
Scale: 1"=200'

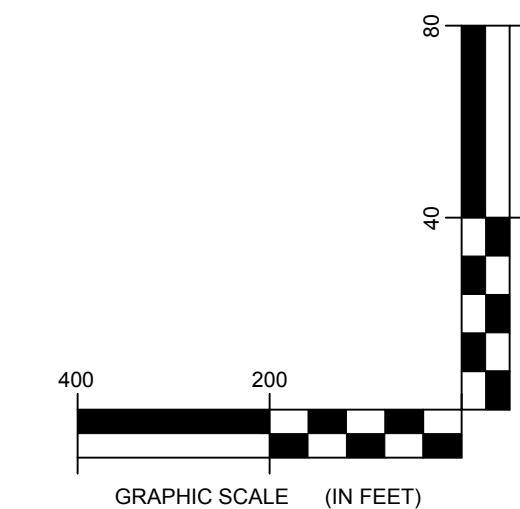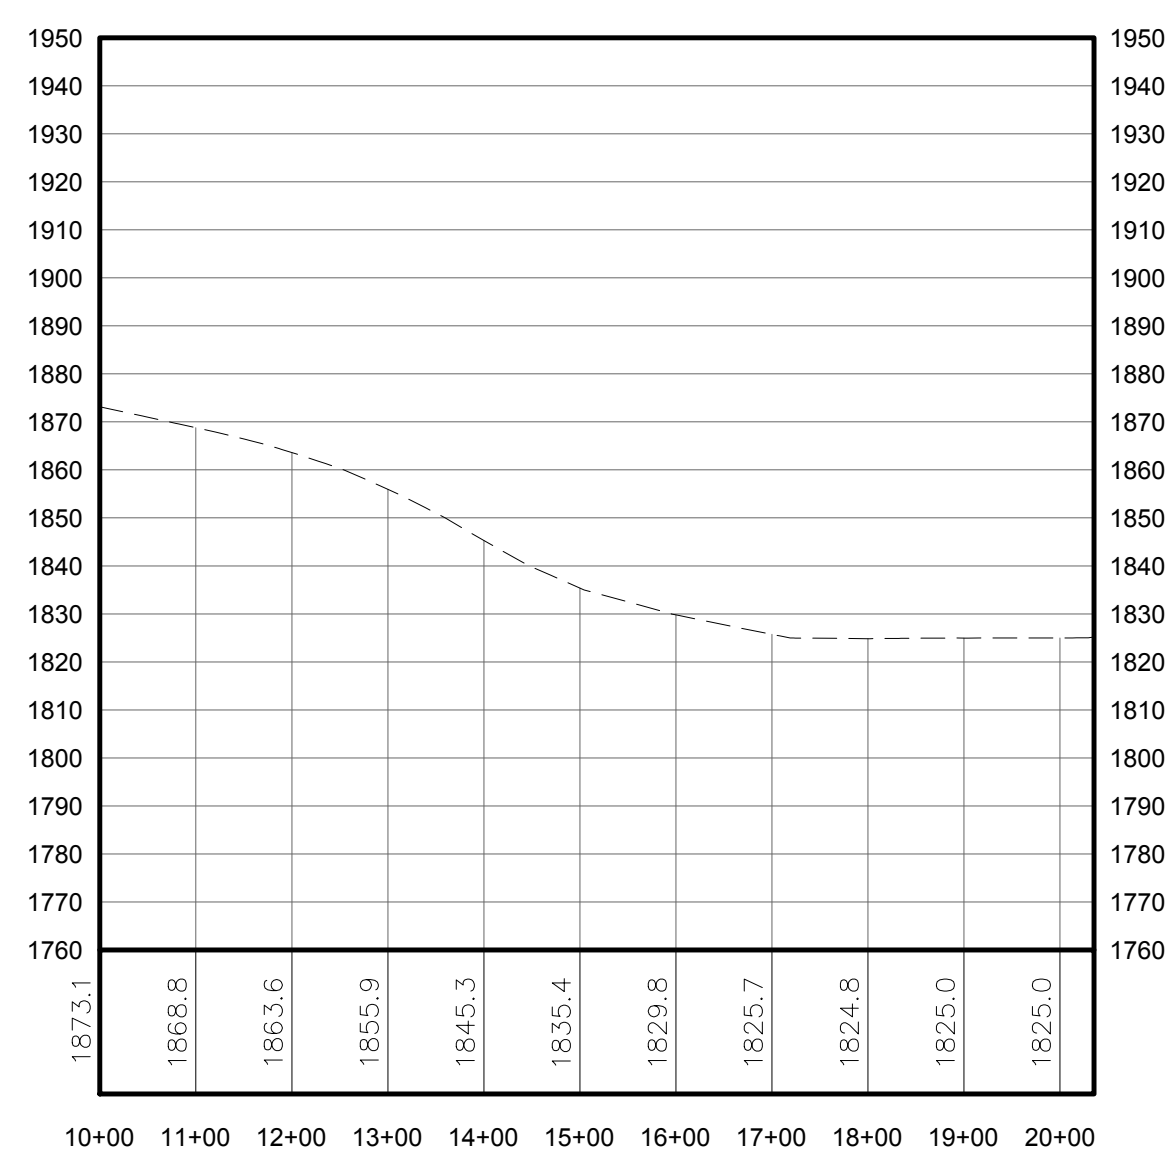

**2** COLLECTION LINE PROFILE  
Scale: H:1"=200' V:1"=40'

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NO.	DATE

**PROJECT TITLE: CASSADAGA WIND PROJECT**  
TOWNS OF CHARLOTTE, CHERRY CREEK, ARKWRIGHT, AND STOCKTON  
PROJECT LOCATION: CHAUTAQUA COUNTY, NEW YORK  
CLIENT: CASSADAGA WIND LLC  
DRAWING TITLE: COLLECTION LINE PLAN AND PROFILE

DATE:	APRIL 22, 2016
SCALE:	AS NOTED
JOB NO.:	14048
DRAWN BY:	AW, CB, ZR
CHECKED BY:	TD
FILE NAME:	14048_Working_NW.dwg
DRAWING NUMBER:	NW-204






STORMWATER KEY NOTES	
ITEM	SYMBOL
VEGETATIVE FILTER STRIP	(A)
LEVEL SPREADER	(B)
DRY SWALE	(C)

NOTE: SEE SHEET C-605 FOR DETAILS

LEGEND	
ITEM	SYMBOL
DRAWING SHEET MATCH LINE	---
WIND TURBINE DESIGNATION	T53
PARCEL BOUNDARY	---
115 KV OVERHEAD GENERATOR LEAD LINE	---
115 KV OVERHEAD GENERATOR LEAD LINE POLE	⊗
UNDERGROUND COLLECTION LINE	---
OVERHEAD COLLECTION LINE	---
EXISTING CONTOUR (2' INTERVAL)	---
EXISTING CONTOUR - INDEX (2' INTERVAL)	---
PERMANENT ACCESS ROAD EDGE	---
PERMANENT ACCESS ROAD CENTERLINE	---
STORM PIPE / CULVERT	---
NYSDEC WETLAND	---
WETLAND BOUNDARY	---
STREAM BOUNDARY	---
APPROXIMATE WETLAND BOUNDARY	---
APPROXIMATE STREAM BOUNDARY	---
ARCHEOLOGICAL AREA TO AVOID	---
ARCHEOLOGICAL AREA	---
WIND TURBINE CONSTRUCTION SITE	---
ROTOR LAYDOWN	---
WIND TURBINE	---
GRAVEL PAD	---
WORK AREA	---
CRANE PAD	---


**1** COLLECTION LINE PLAN VIEW - TRUNK T53 - TRUNK T4  
 Scale: 1"=200'

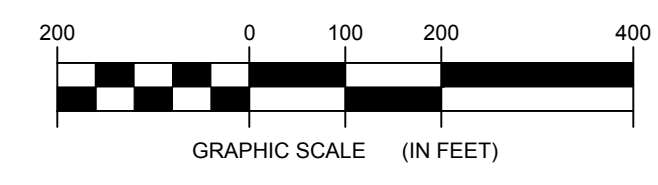


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PROFILE LEGEND	
ITEM	SYMBOL
EXISTING ELEVATION (FT)	1845.3
EXISTING GRADE	---



NOTE: ELEVATIONS IN USGS DATUM.

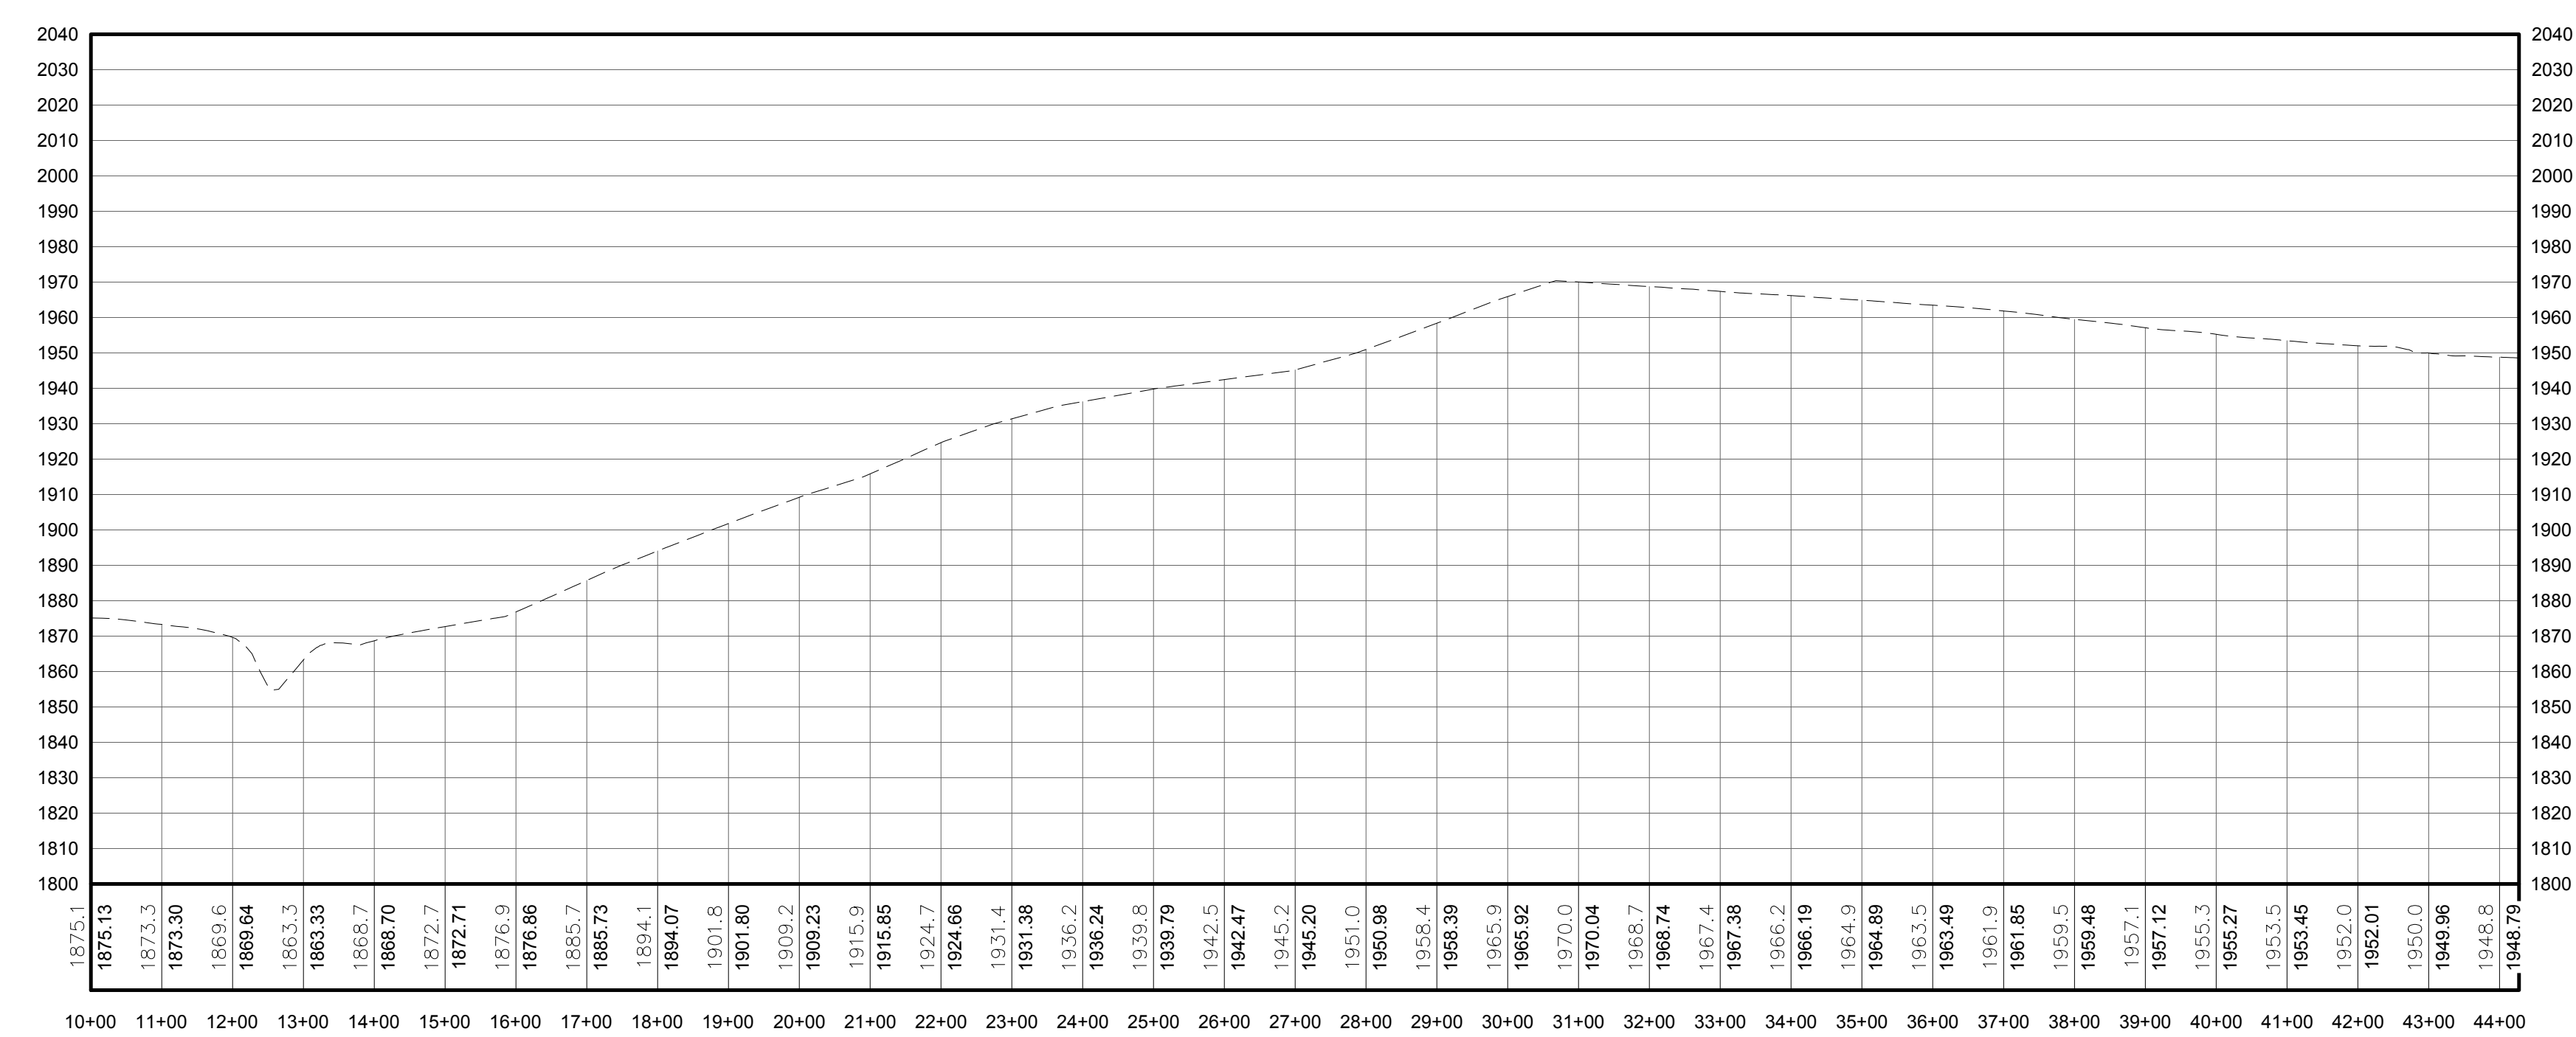

**2** COLLECTION LINE PROFILE  
 Scale: H:1"=200' V:1"=40'

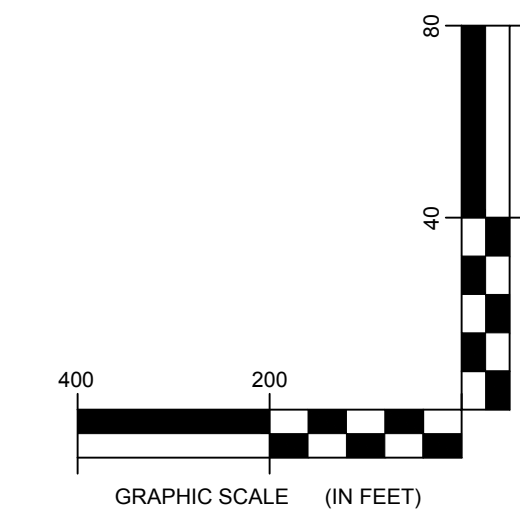

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DRAWING REVISIONS	
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PROJECT TITLE: <b>CASSADAGA WIND PROJECT</b>
TOWNS OF CHARLOTTE, CHERRY CREEK, ARKWRIGHT, AND STOCKTON
PROJECT LOCATION: CHAUTAUGUS COUNTY, NEW YORK
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CHECKED BY: TD
FILE NAME: 14048_Working_NW.dwg
DRAWING NUMBER: <b>NW - 205</b>
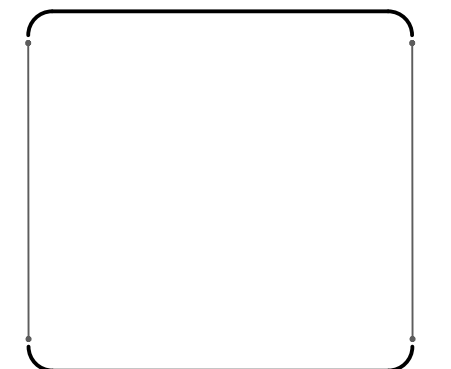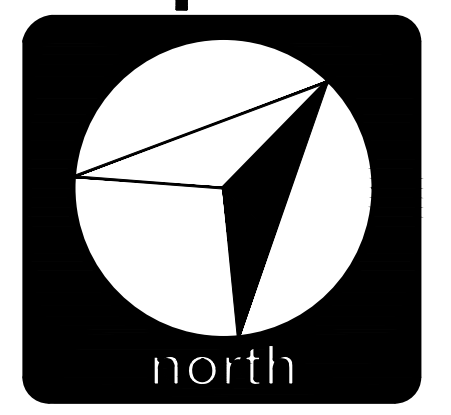
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