
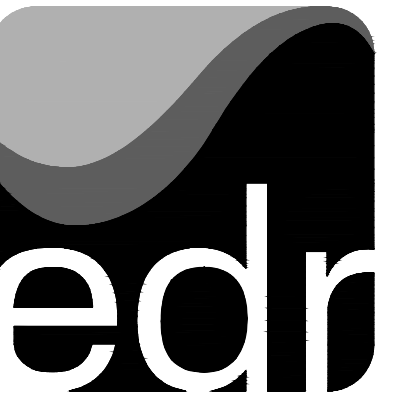


LEGEND	
ITEM	SYMBOL
WIND TURBINE DESIGNATION	T53
SOIL BOUNDARY	-----
PARCEL BOUNDARY	-----
115 KV OVERHEAD GENERATOR LEAD LINE	----- 115KV -----
115 KV GENERATOR LEAD LINE POLE	o
UNDERGROUND COLLECTION LINE	-----
OVERHEAD COLLECTION LINE	-----
PERMANENT ACCESS ROAD EDGE	-----
WIND TURBINE CONSTRUCTION SITE	⌊


NOTE: REFER TO APPENDIX C OF THE PRELIMINARY STORMWATER POLLUTION PREVENTION PLAN (SWPPP) FOR SOIL MAP UNIT NAMES AND SOIL DESCRIPTIONS

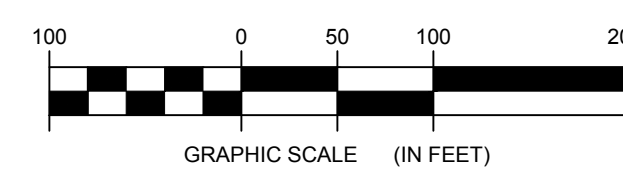

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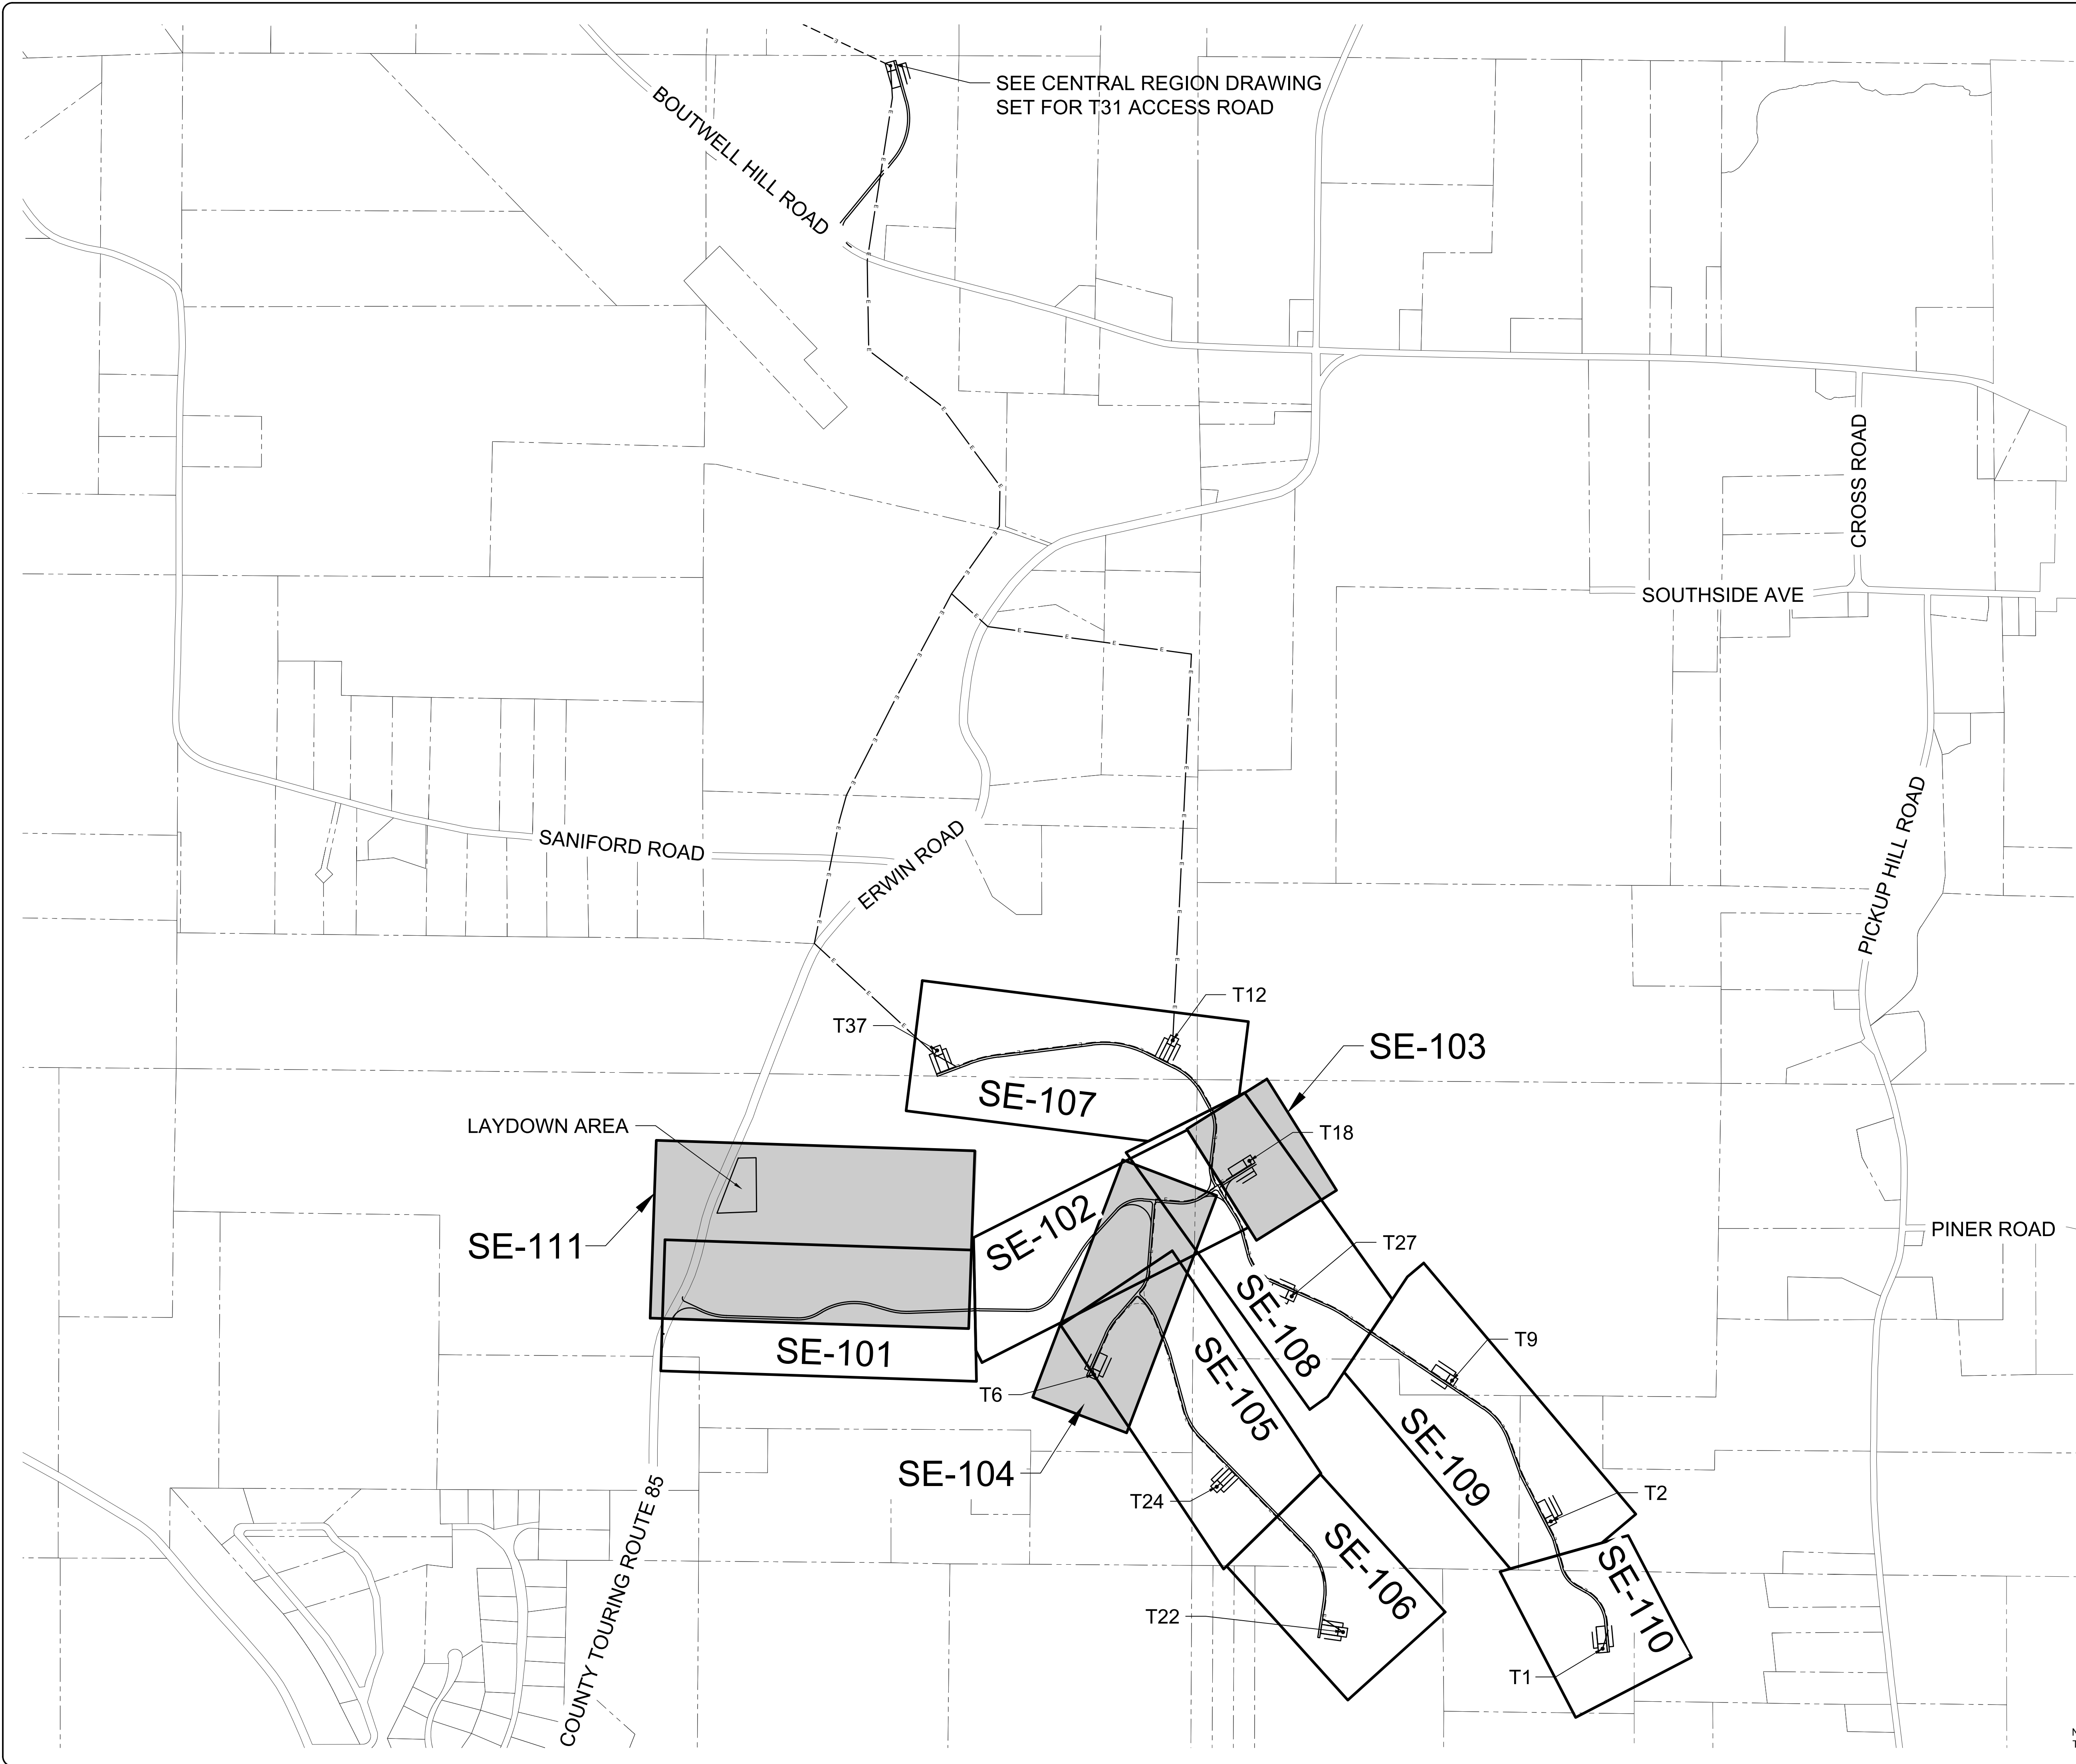
DRAWING REVISIONS	
NO.	DATE

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NO.	DATE	REVISION

PROJECT TITLE: **CASSADAGA WIND PROJECT**
TOWNS OF CHARLOTTE, CHERRY CREEK, ARKRIGHT, AND STOCKTON
PROJECT LOCATION: CHAUTAQUA COUNTY, NEW YORK
CLIENT: CASSADAGA WIND LLC
DRAWING TITLE: **SOUTHEAST REGION SOIL MAP**

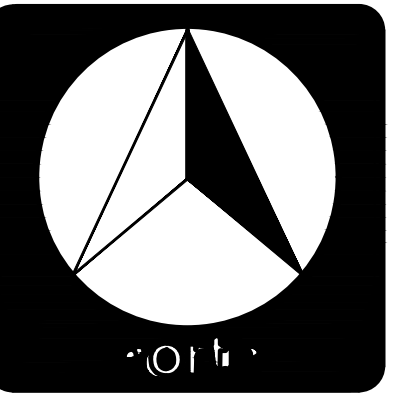DATE: **APRIL 22, 2016**
SCALE: **NOT TO SCALE**
edr Job#: 14048
DRAWN BY: **AW, CB, ZR**
CHECKED BY: **TD**
FILE NAME:
14048_Working_SE.dwg
DRAWING NUMBER:
SE-001



SEE CENTRAL REGION DRAWING SET FOR T31 ACCESS ROAD

NOTE: ENTIRE SOUTHEAST REGION IS LOCATED WITHIN THE TOWN OF CHERRY CREEK



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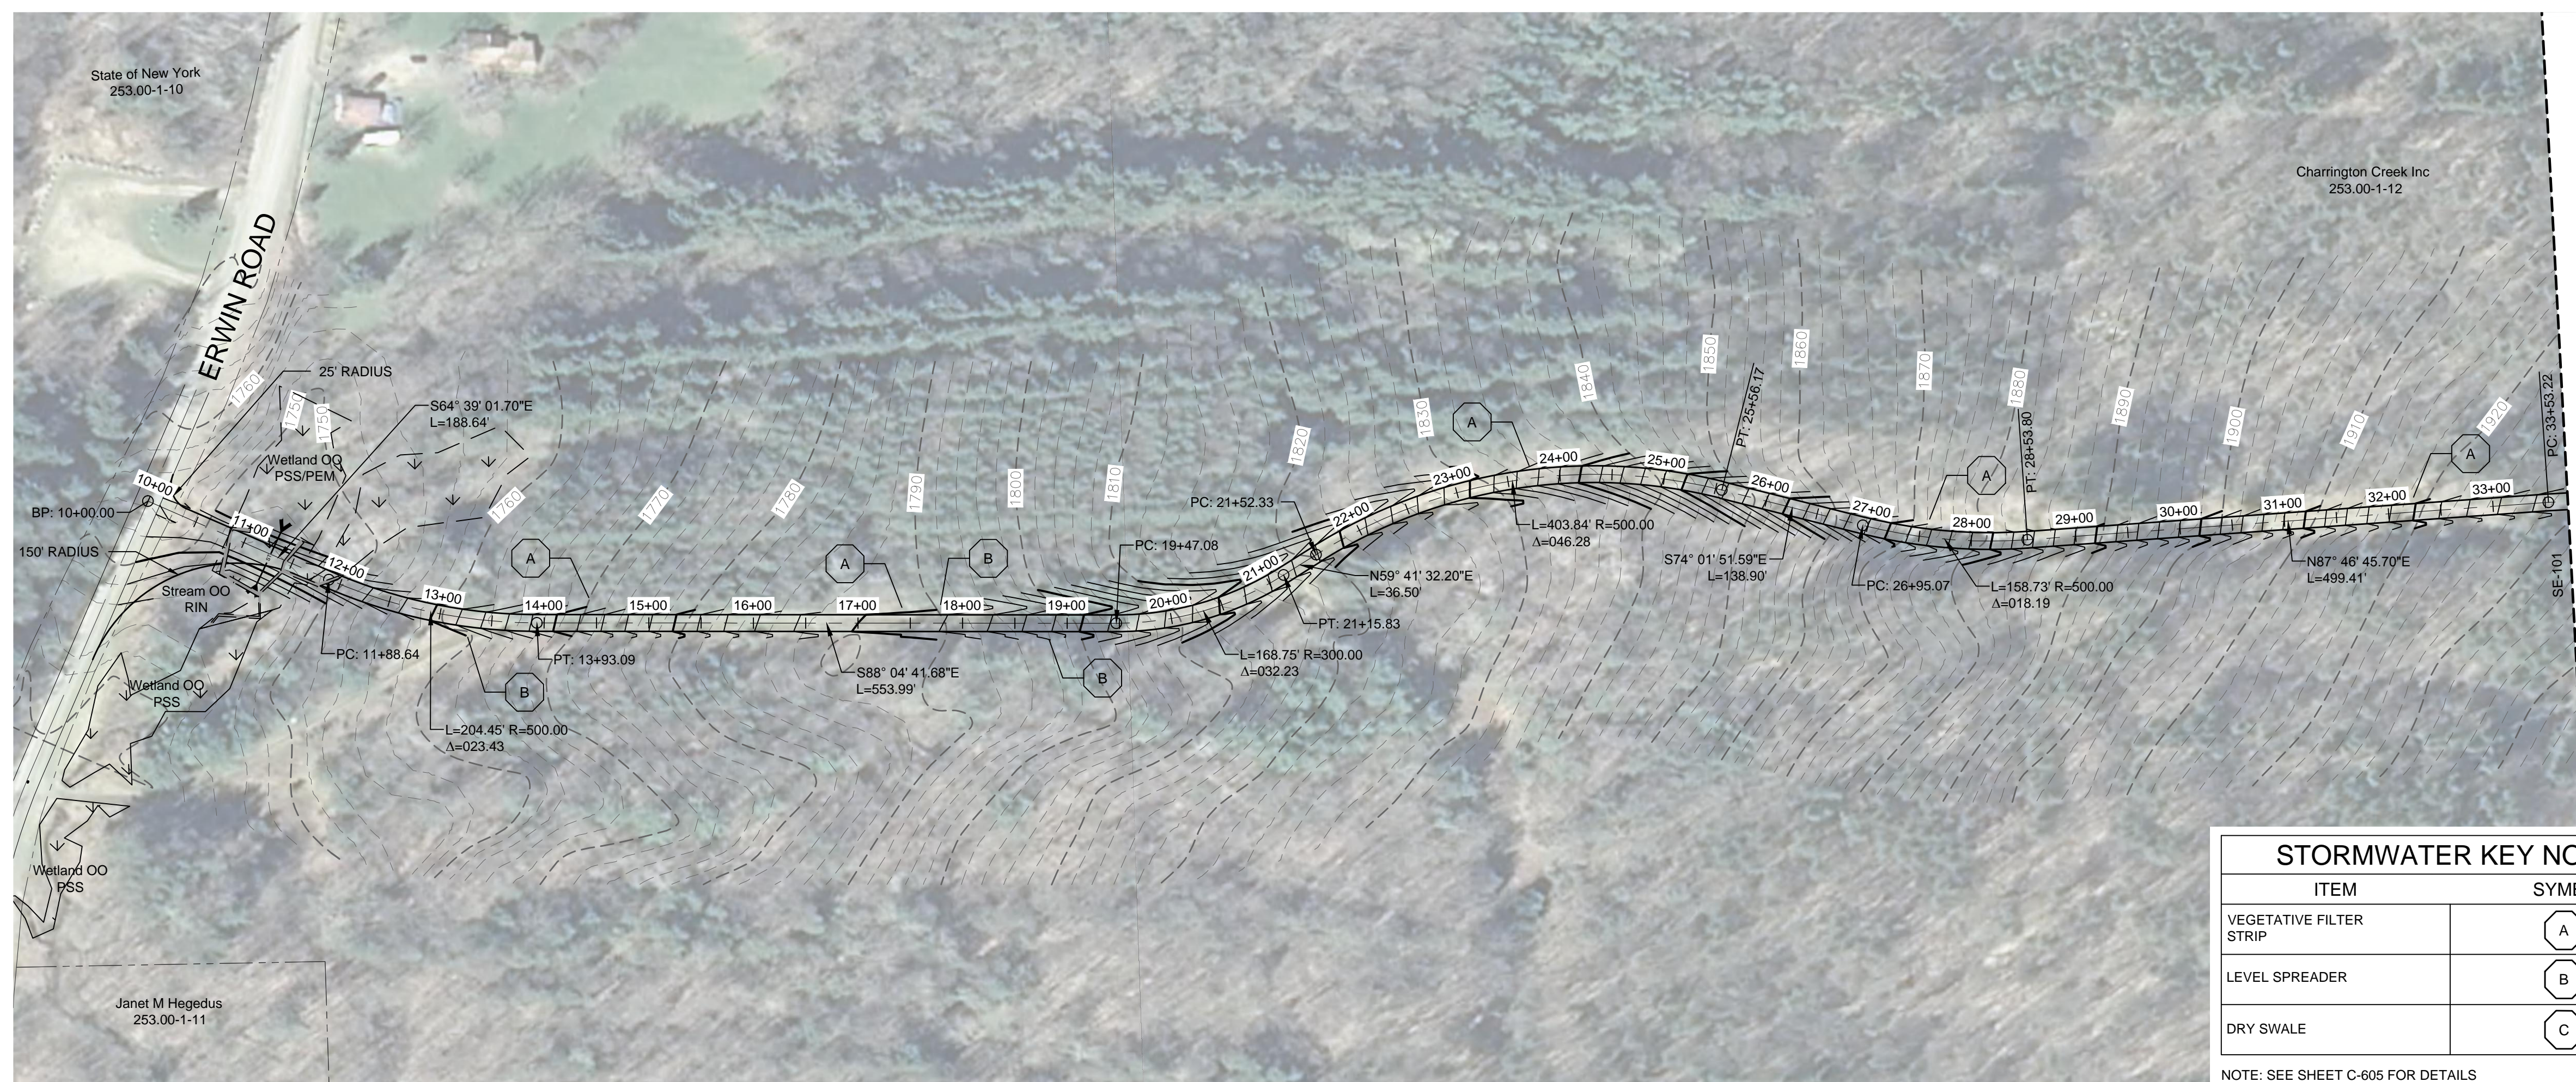
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NO.	REVISION

PROJECT TITLE: CASSADAGA WIND PROJECT
TOWNS OF CHARLOTTE, CHERRY CREEK, ARKWRIGHT, AND STOCKTON
PROJECT LOCATION: CHAUTAUGUS COUNTY, NEW YORK
CLIENT: CASSADAGA WIND LLC
DRAWING TITLE: ACCESS ROAD PLAN AND PROFILE INDEX SHEET

DATE: APRIL 22, 2016
SCALE: AS NOTED
edr Job#: 14048
DRAWN BY: AW, CB, ZR
CHECKED BY: TD
FILE NAME: 14048_Working_SE.dwg
DRAWING NUMBER: SE-100

D:\14048_Cassadaga Wind\p\working drawings\14048_working.dwg



STORMWATER KEY NOTES

ITEM	SYMBOL
VEGETATIVE FILTER STRIP	(A)
LEVEL SPREADER	(B)
DRY SWALE	(C)

NOTE: SEE SHEET C-605 FOR DETAILS

LEGEND


ITEM	SYMBOL
DRAWING SHEET	---
MATCH LINE	---
WIND TURBINE DESIGNATION	T53
PARCEL BOUNDARY	---
115 KV OVERHEAD GENERATOR LEAD LINE	---
115 KV OVERHEAD GENERATOR LEAD LINE POLE	---
UNDERGROUND COLLECTION LINE	---
OVERHEAD COLLECTION LINE	---
EXISTING CONTOUR (2' INTERVAL)	---
EXISTING CONTOUR - INDEX (2' INTERVAL)	---
CONTOUR - FINISHED (2' INTERVAL)	---
CONTOUR - FINISHED - INDEX (2' INTERVAL)	---
ACCESS ROAD CENTERLINE	---
PERMANENT ACCESS ROAD EDGE	---
STORM PIPE / CULVERT	---
NYSDEC WETLAND	---
WETLAND BOUNDARY	---
STREAM BOUNDARY	---
APPROXIMATE WETLAND BOUNDARY	---
APPROXIMATE STREAM BOUNDARY	---
ENVIRONMENTALLY SENSITIVE AREA - RESTRICTED ACCESS	---
ENVIRONMENTALLY SENSITIVE AREA	---
WIND TURBINE CONSTRUCTION SITE	---
ROTOR LAYDOWN	---
WIND TURBINE	---
GRAVEL PAD	---
WORK AREA	---
CRANE PAD	---

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1 PLAN VIEW - TRUNK T18 ACCESS ROAD
 Scale: 1"=100'



PROFILE LEGEND

ITEM	SYMBOL
EXISTING ELEVATION (FT)	---
PROPOSED ELEVATION (FT)	---
EXISTING GRADE	---
PROPOSED GRADE	---

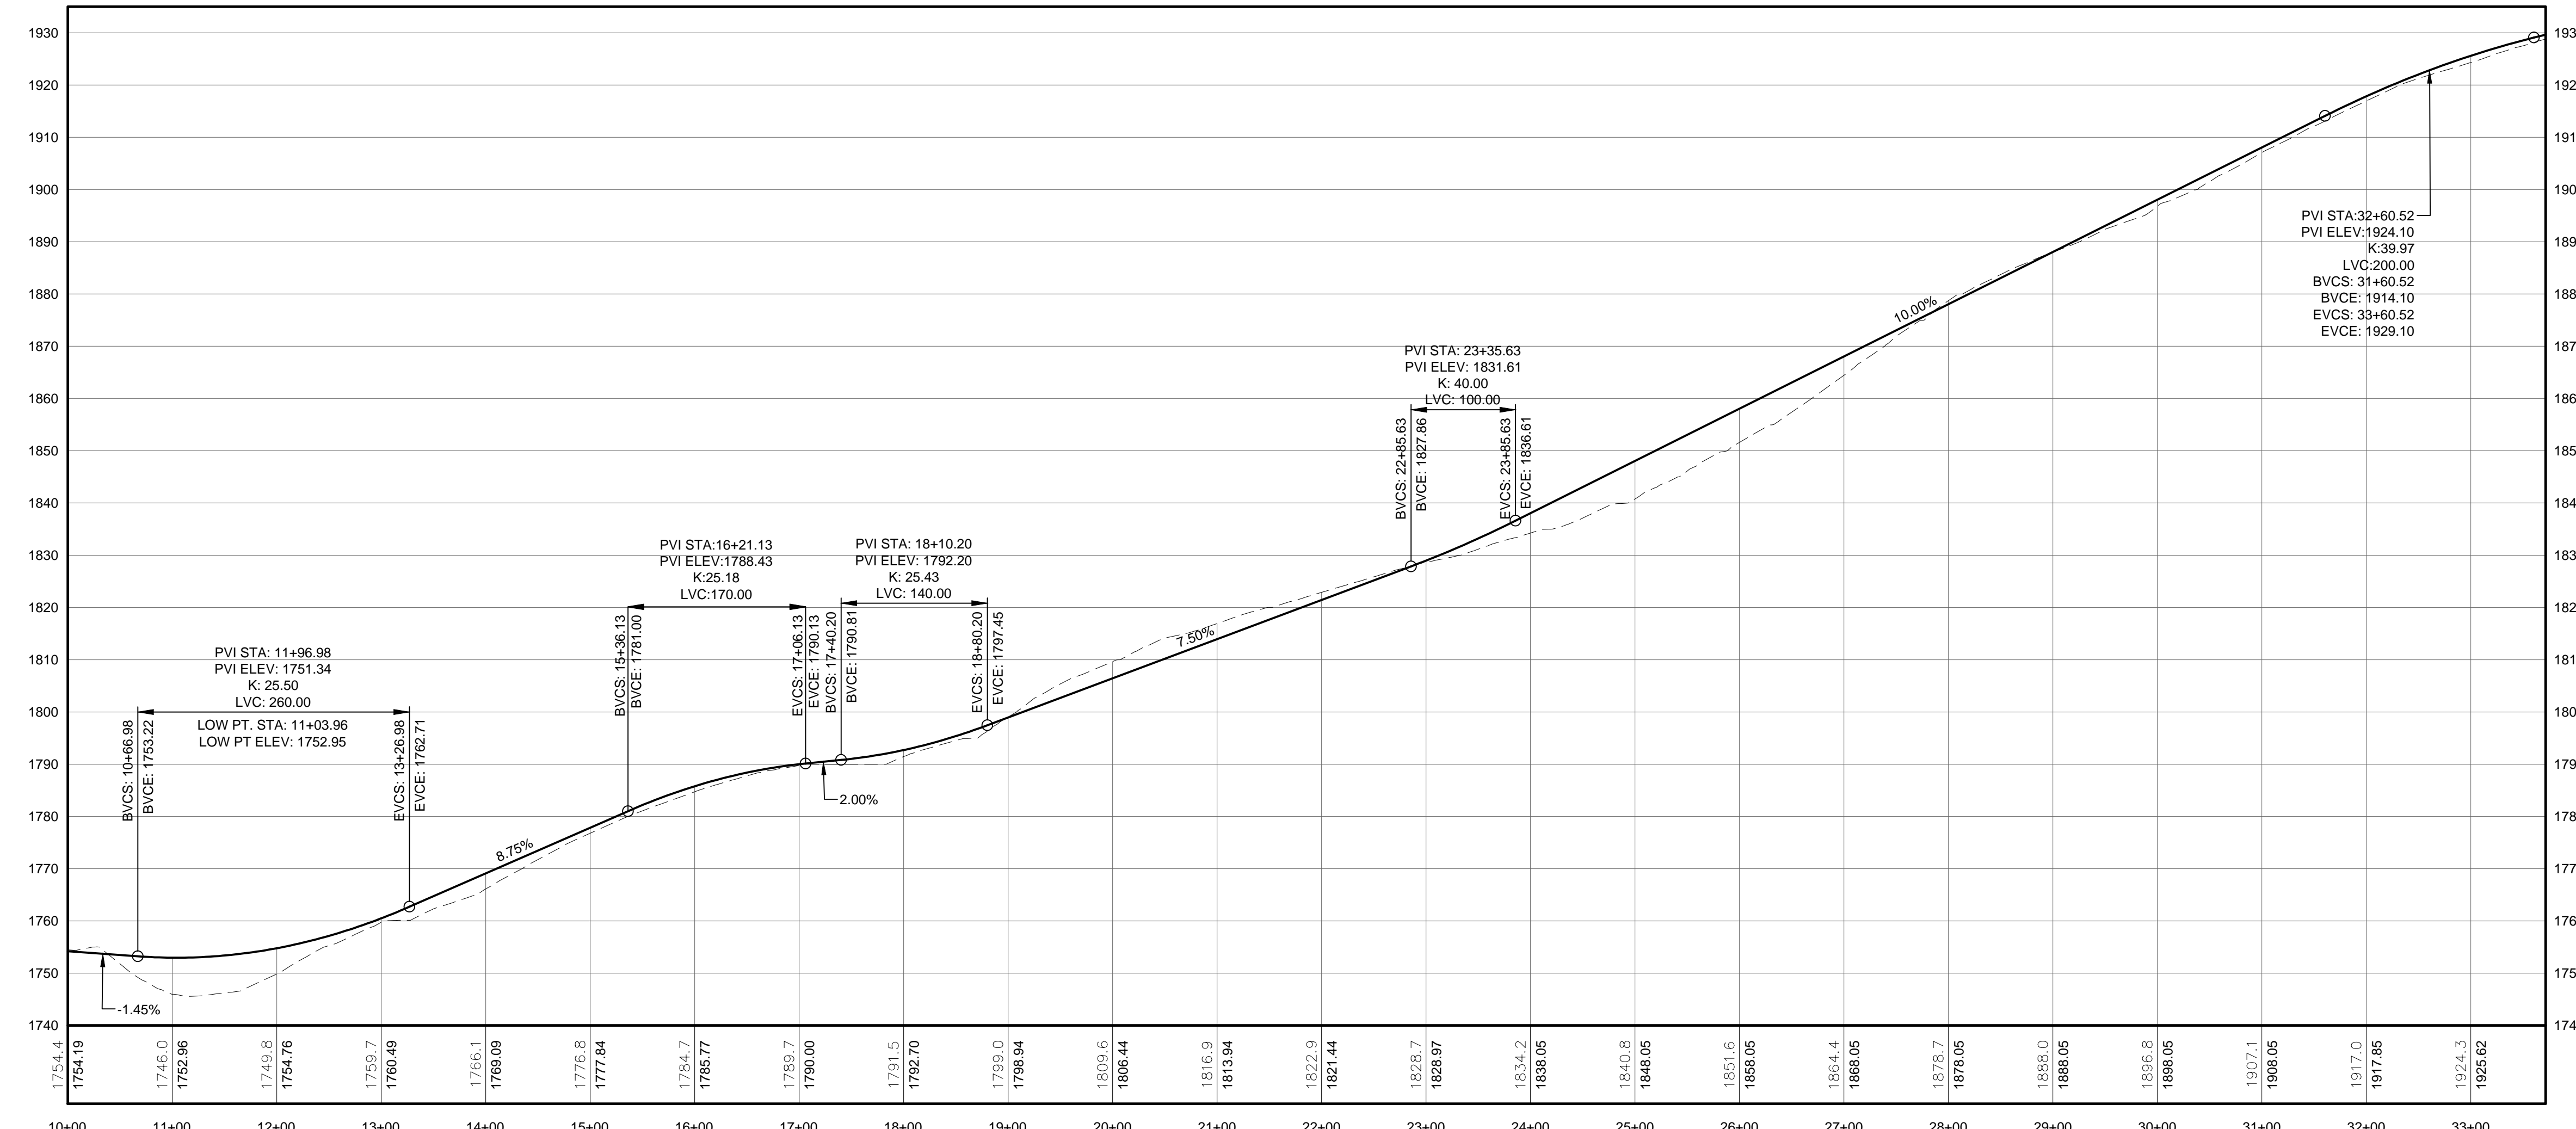NOTE: ELEVATIONS IN USGS DATUM.

2 ACCESS ROAD PROFILE
 Scale: H:1"=100' V:1"=20'

BY: [Signature]

NO.	DATE	REVISION
1		
2		
3		
4		
5		


PROJECT TITLE: CASSADAGA WIND PROJECT
TOWNS OF CHARLOTTE, CHERRY CREEK, ARKWRIGHT, AND STOCKTON
PROJECT LOCATION: CHAUTAQUA COUNTY, NEW YORK
CLIENT: CASSADAGA WIND LLC
DRAWING TITLE: ACCESS ROAD PLAN AND PROFILE

DATE:	APRIL 22, 2016
SCALE:	AS NOTED
edr Job#: 14048	
DRAWN BY:	AW, CB, ZR
CHECKED BY:	TD
FILE NAME:	14048_Working_SE.dwg
DRAWING NUMBER:	SE-101

STORMWATER KEY NOTES	
ITEM	SYMBOL
VEGETATIVE FILTER STRIP	(A)
LEVEL SPREADER	(B)
DRY SWALE	(C)


LEGEND	
ITEM	SYMBOL
DRAWING SHEET MATCH LINE	--- DRAWING NUMBER ---
WIND TURBINE DESIGNATION	T53
PARCEL BOUNDARY	---
115 KV OVERHEAD GENERATOR LEAD LINE	---
115 KV OVERHEAD GENERATOR LEAD LINE POLE	⊙
UNDERGROUND COLLECTION LINE	---
OVERHEAD COLLECTION LINE	---
EXISTING CONTOUR (2' INTERVAL)	(490)
EXISTING CONTOUR - INDEX (2' INTERVAL)	(490)
CONTOUR - FINISHED (2' INTERVAL)	(490)
CONTOUR - FINISHED - INDEX (2' INTERVAL)	(490)
ACCESS ROAD CENTERLINE	---
PERMANENT ACCESS ROAD EDGE	---
STORM PIPE / CULVERT	---
NYSDEC WETLAND	▨
WETLAND BOUNDARY	↓ ↓ ↓
STREAM BOUNDARY	▬
APPROXIMATE WETLAND BOUNDARY	↓ ↓ ↓
APPROXIMATE STREAM BOUNDARY	▬
ENVIRONMENTALLY SENSITIVE AREA - RESTRICTED ACCESS	▨
ENVIRONMENTALLY SENSITIVE AREA	▨
WIND TURBINE CONSTRUCTION SITE	⊙
ROTOR LAYDOWN	⊙
WIND TURBINE	⊙
GRAVEL PAD	⊙
WORK AREA	⊙
CRANE PAD	⊙

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NOTE: SEE SHEET C-605 FOR DETAILS

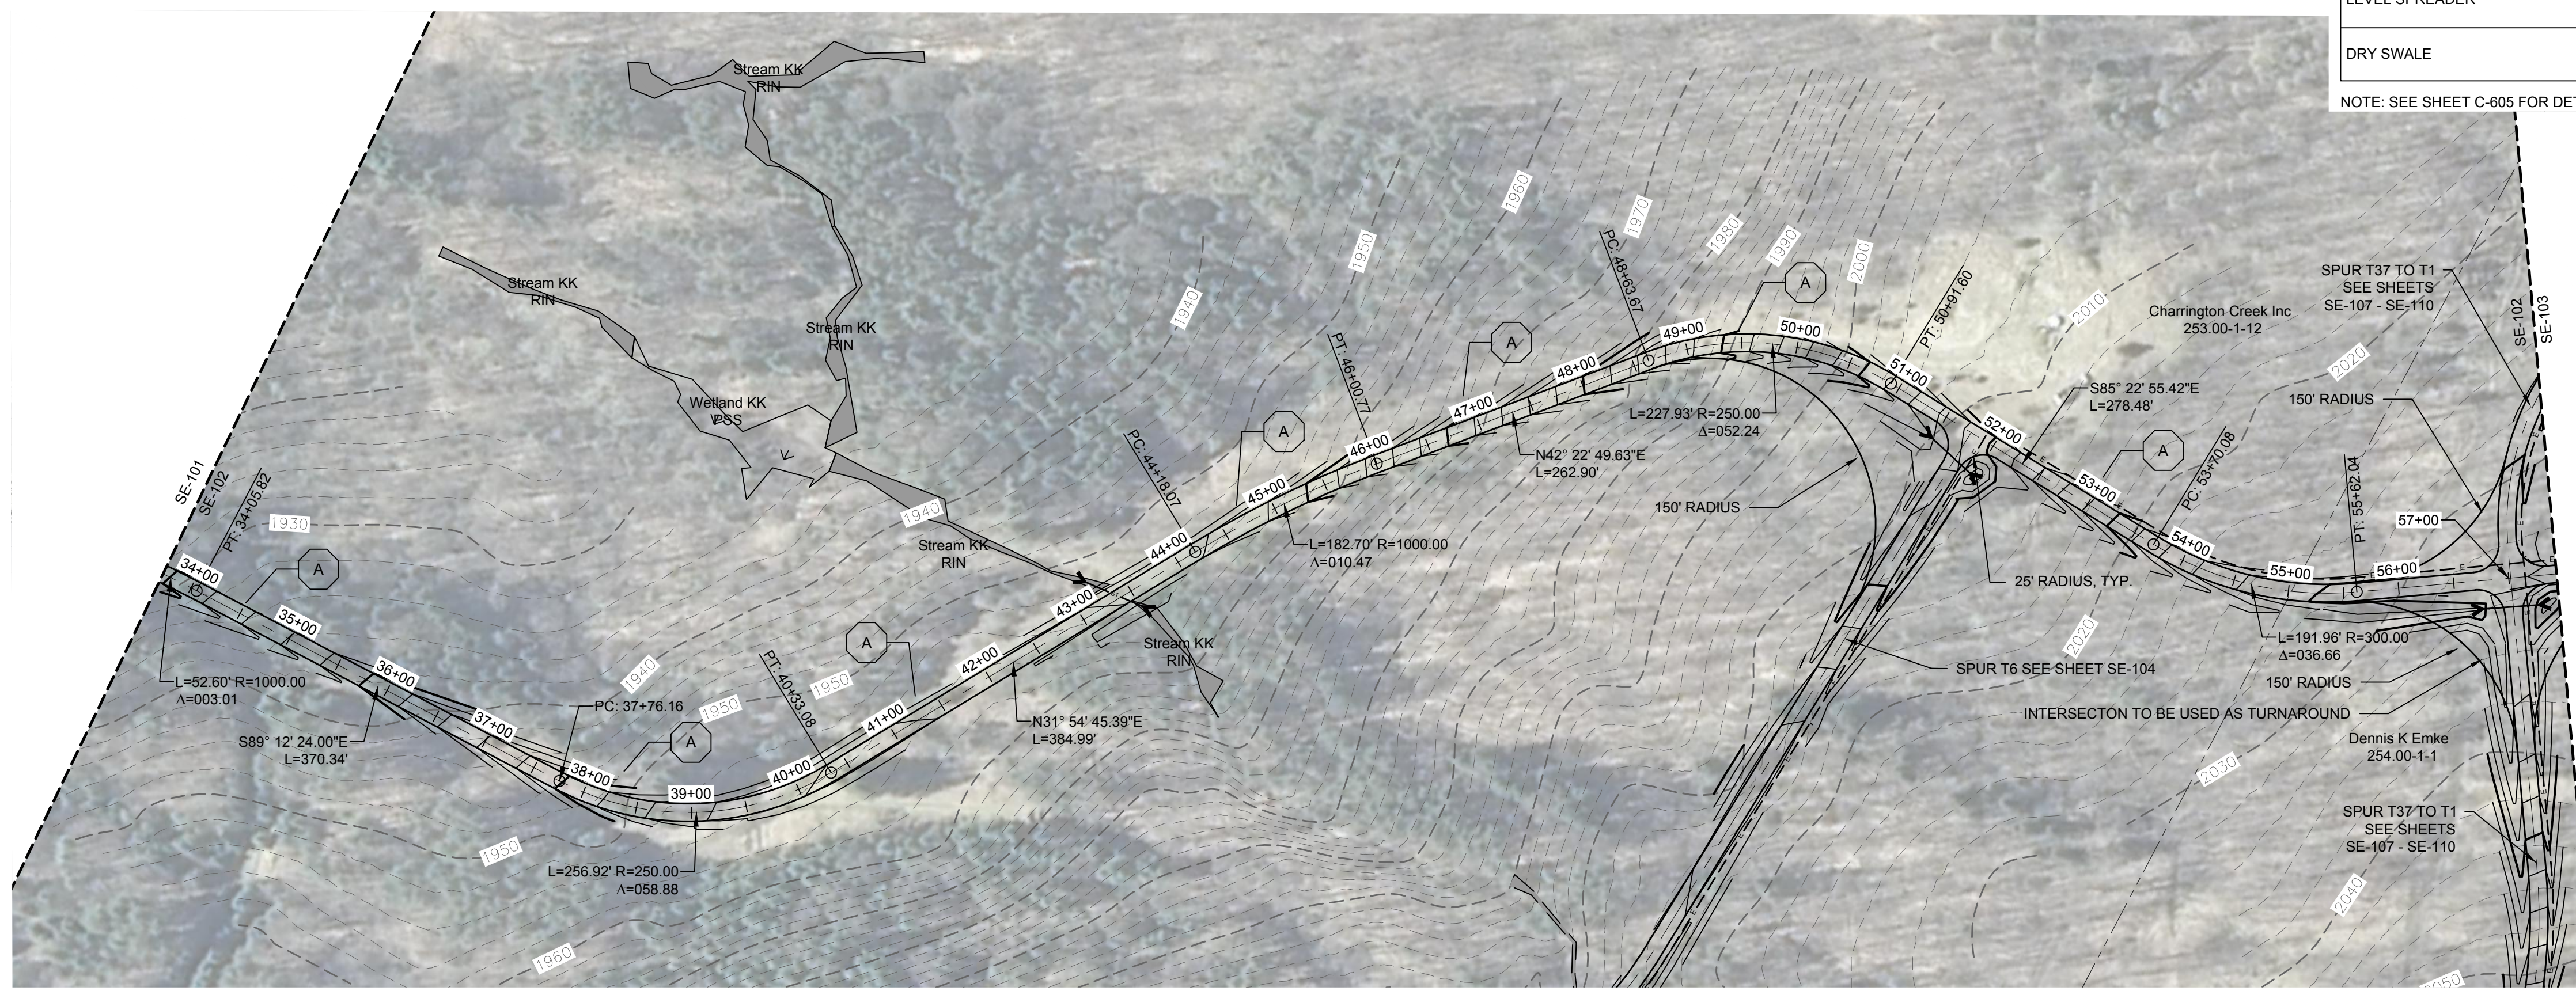1 PLAN VIEW - TRUNK 18 ACCESS ROAD
 102 Scale: 1"=100'





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DRAWING REVISIONS	
NO.	DATE

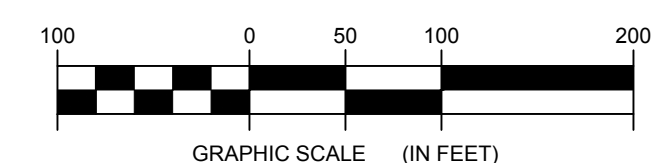PROFILE LEGEND	
ITEM	SYMBOL
EXISTING ELEVATION (FT)	1845.3
PROPOSED ELEVATION (FT)	1845.27
EXISTING GRADE	---
PROPOSED GRADE	---


NOTE: ELEVATIONS IN USGS DATUM.

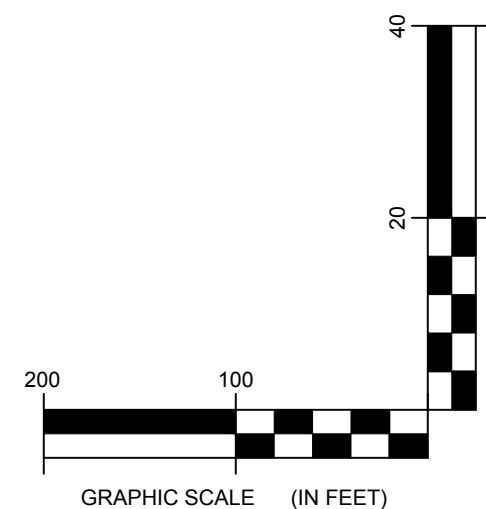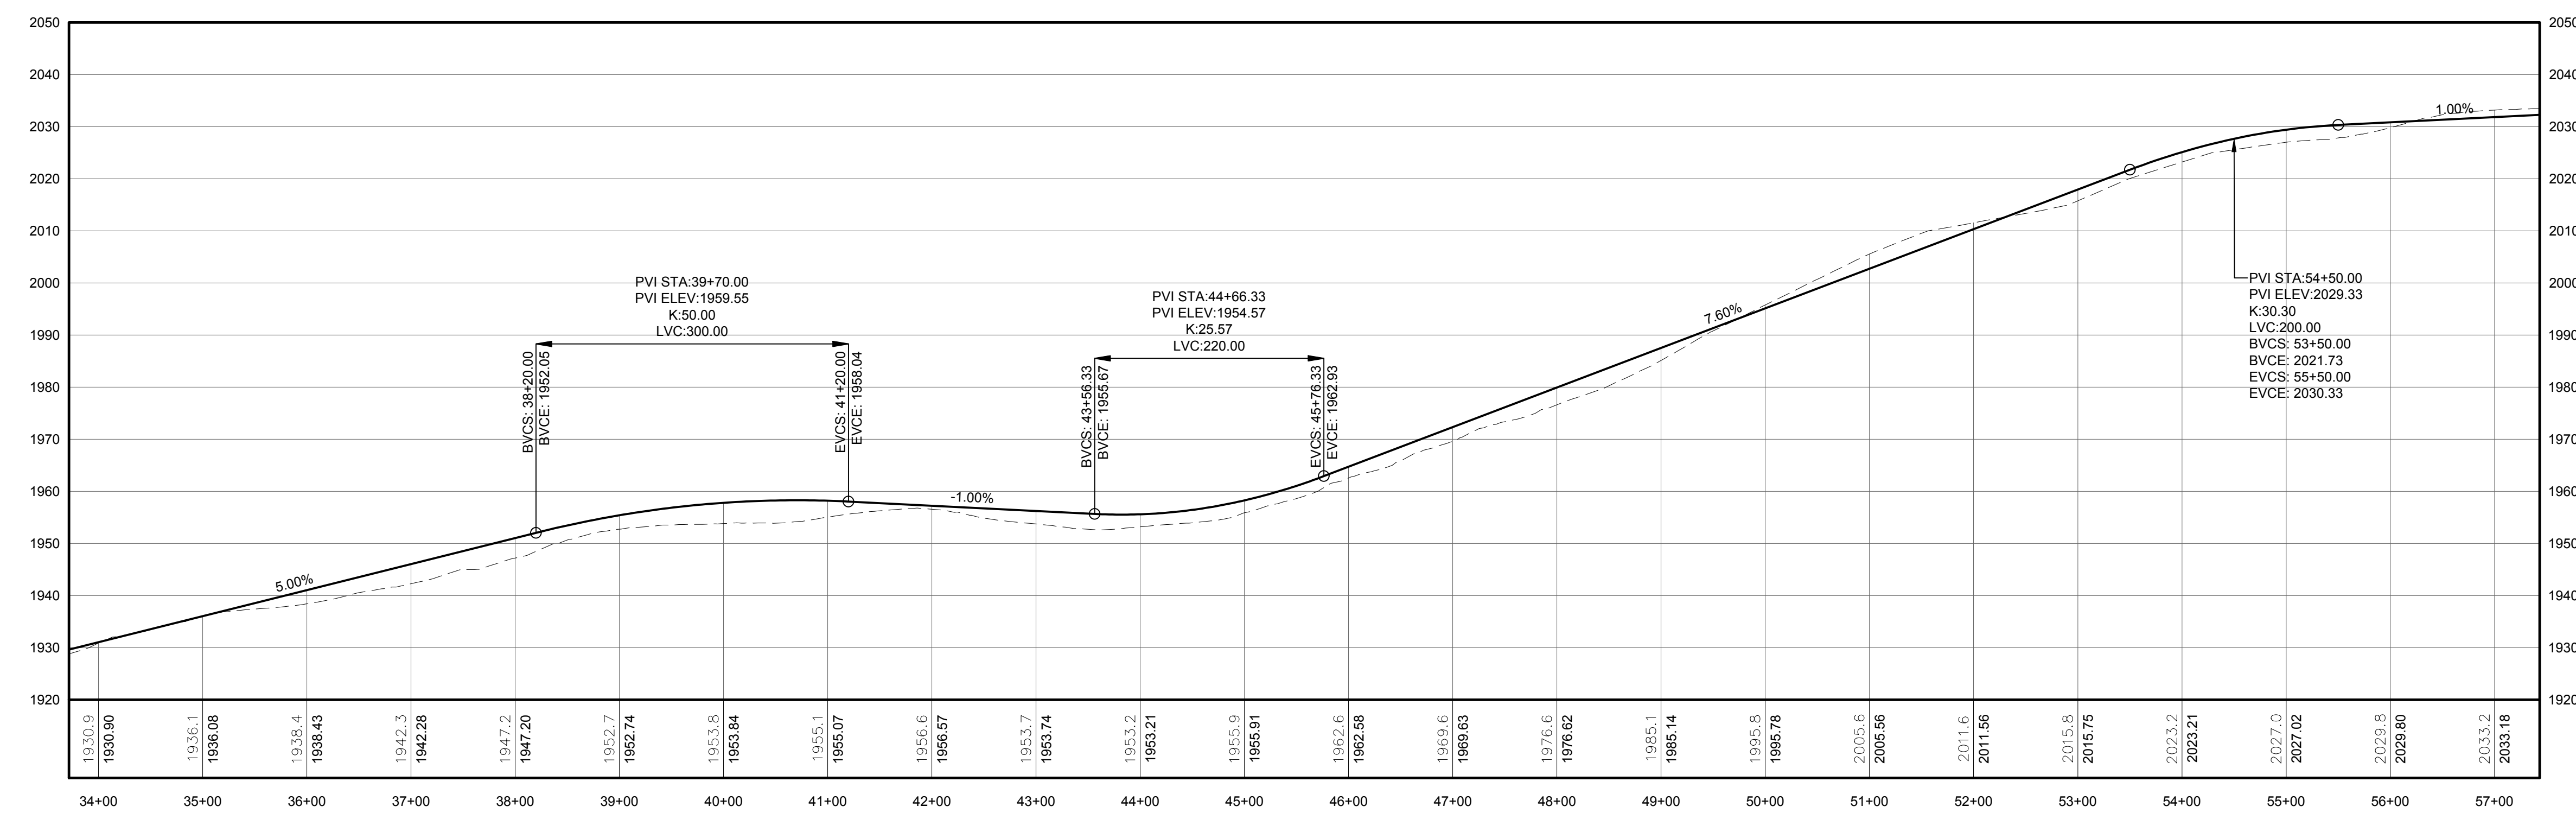


2 ACCESS ROAD PROFILE
 102 Scale: H:1"=100' V:1"=20'

CASSADAGA WIND PROJECT
 TOWNS OF CHARLOTTE, CHERRY CREEK, ARKWRIGHT, AND STOCKTON
 PROJECT LOCATION: CHAUTAUGUS COUNTY, NEW YORK
 CLIENT: CASSADAGA WIND LLC
 DRAWING TITLE: ACCESS ROAD PLAN AND PROFILE

DATE	APRIL 22, 2016
SCALE	AS NOTED
JOB NO.	14048
DRAWN BY	AW, CB, ZR
CHECKED BY	TD
FILE NAME	14048_Working_SE.dwg
DRAWING NUMBER	SE-102

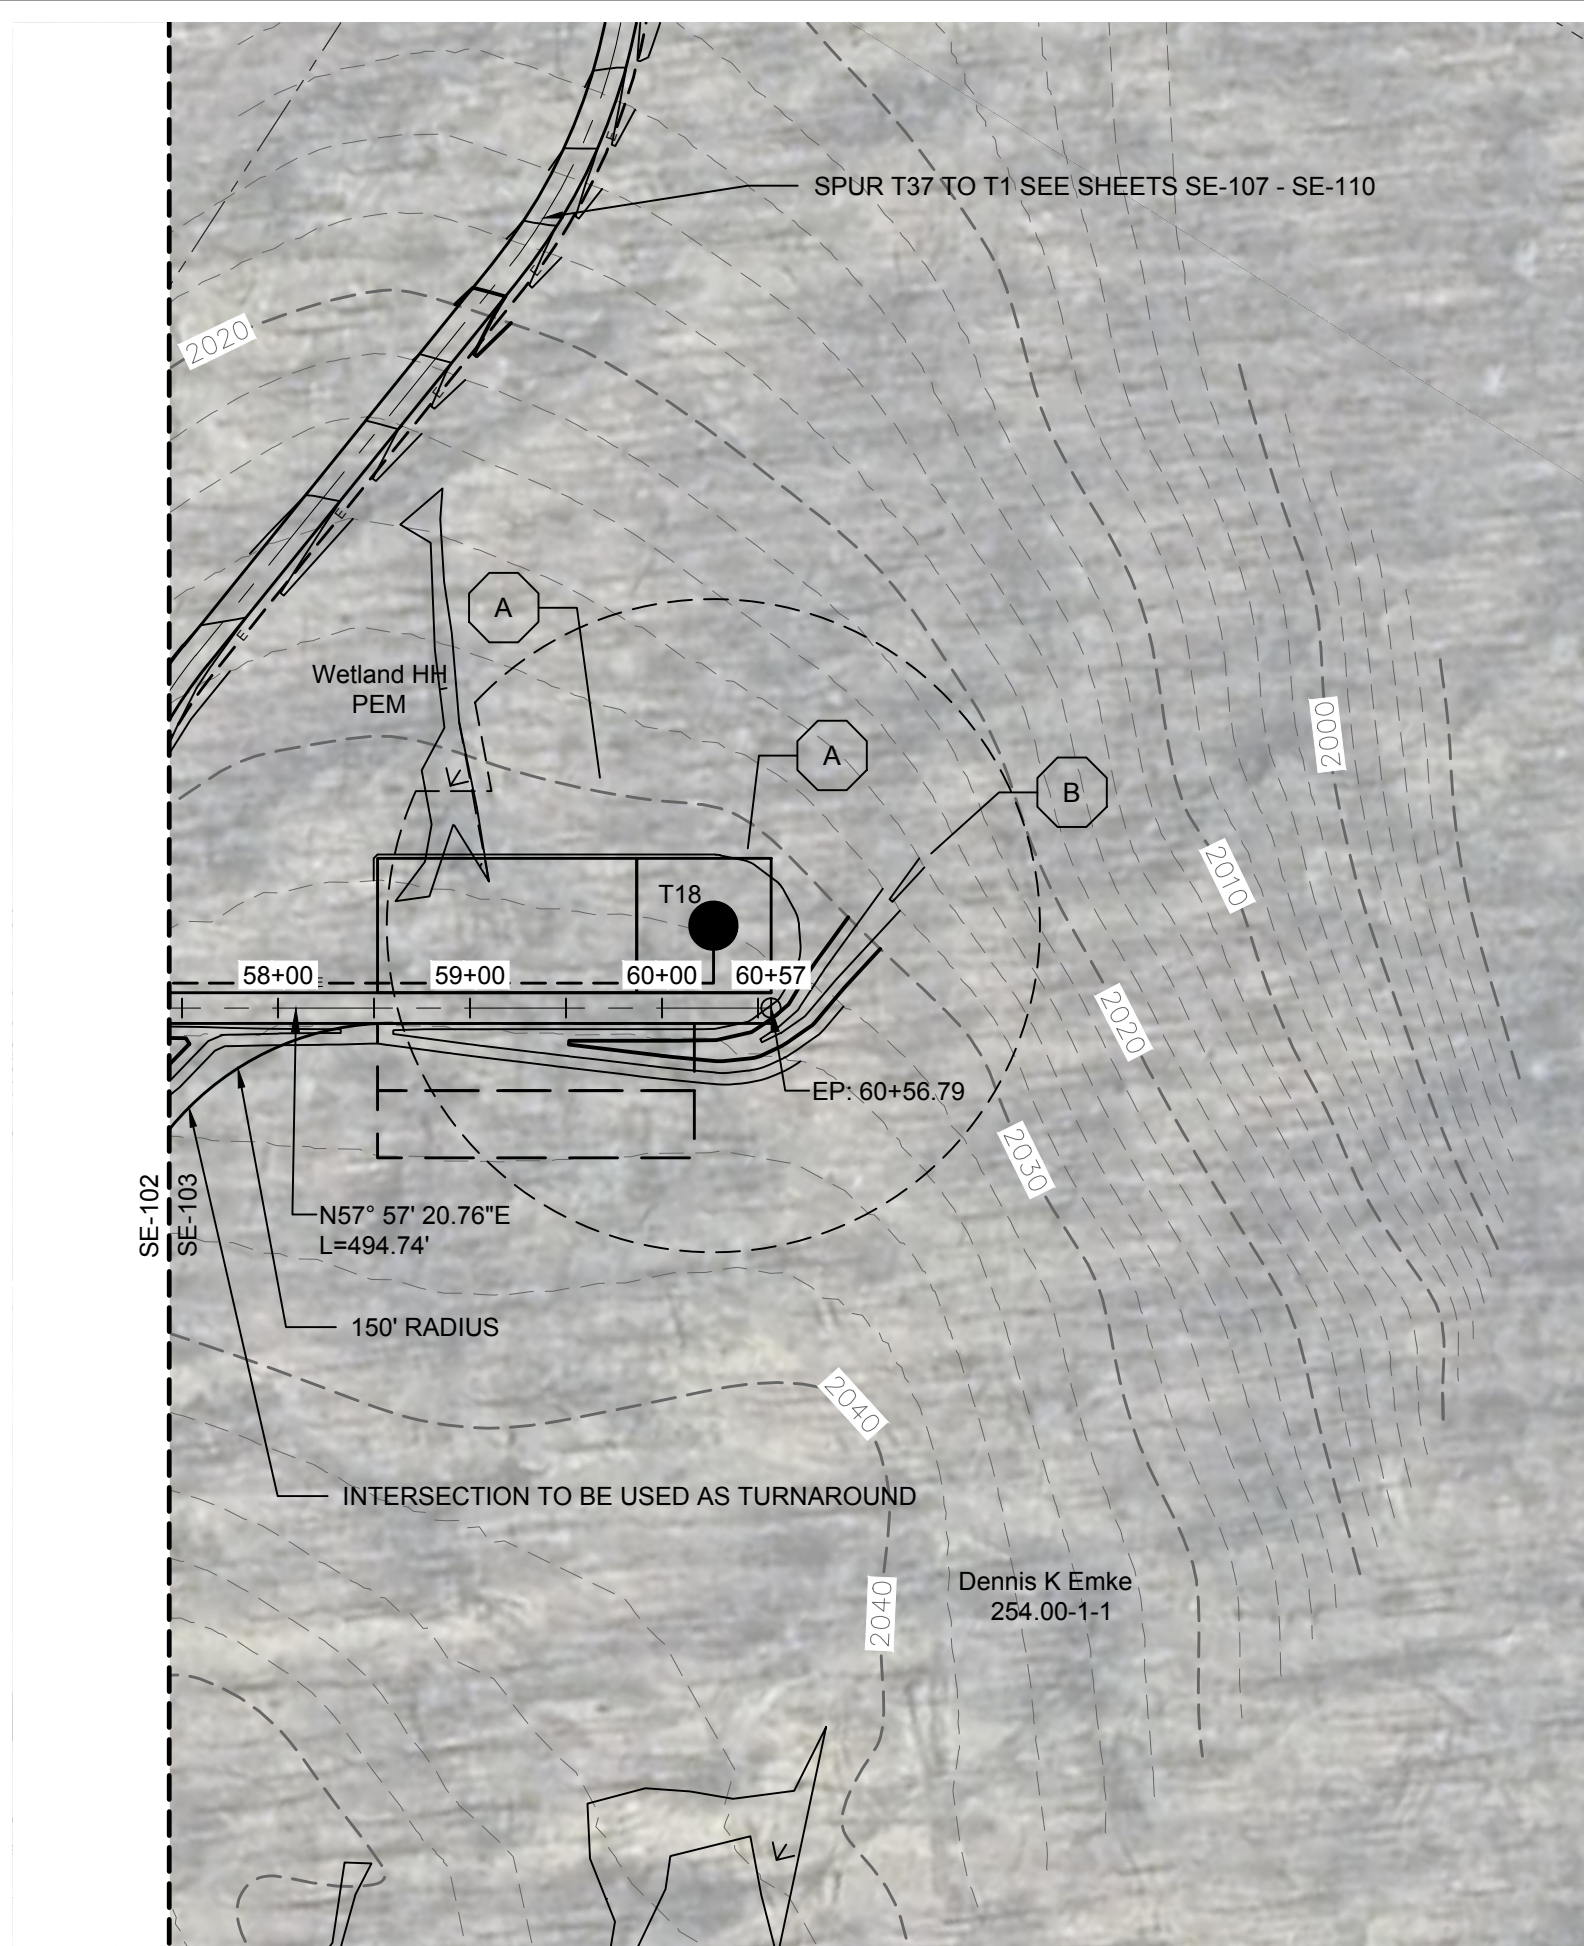

1 PLAN VIEW - TRUNK T18 ACCESS ROAD
Scale: 1"=100'

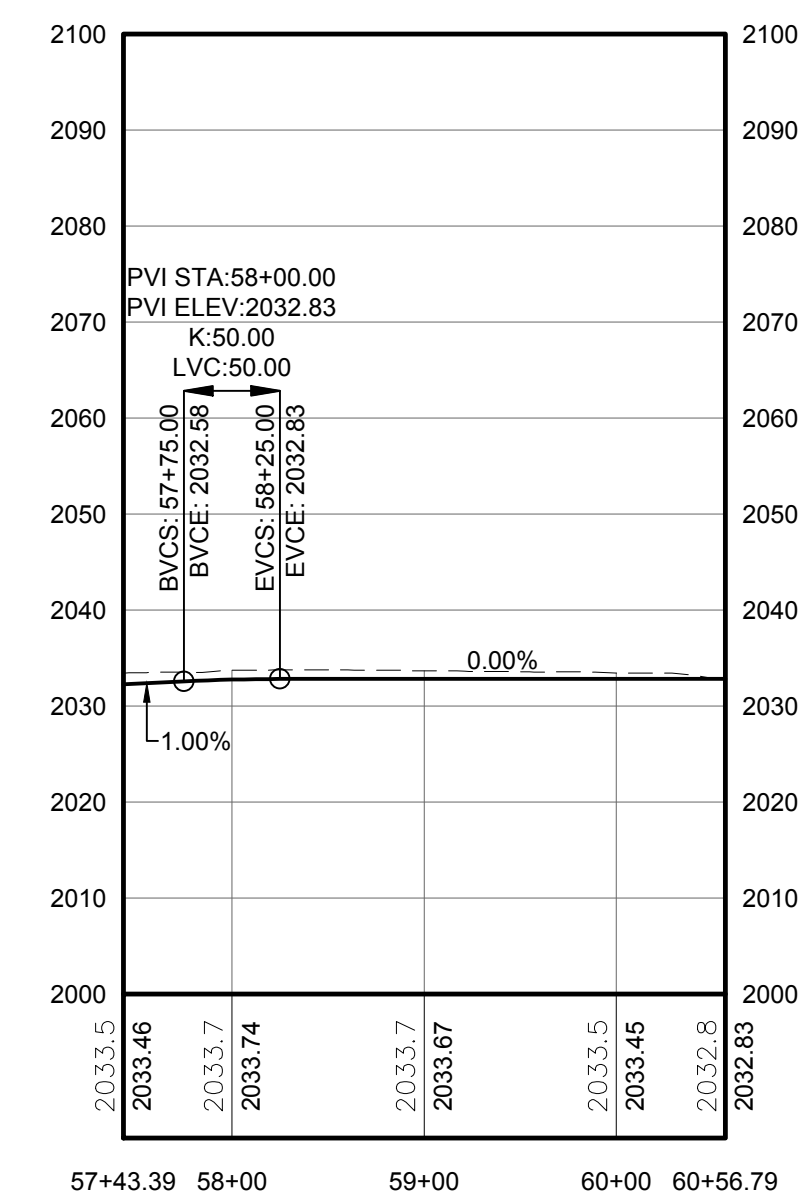


2 ACCESS ROAD PROFILE
Scale: H:1"=100' V:1"=20'

STORMWATER KEY NOTES	
ITEM	SYMBOL
VEGETATIVE FILTER STRIP	(A)
LEVEL SPREADER	(B)
DRY SWALE	(C)

NOTE: SEE SHEET C-605 FOR DETAILS


LEGEND	
ITEM	SYMBOL
DRAWING SHEET MATCH LINE	--- DRAWING NUMBER --- DRAWING NUMBER
WIND TURBINE DESIGNATION	T53
PARCEL BOUNDARY	---
115 KV OVERHEAD GENERATOR LEAD LINE	---
115 KV OVERHEAD GENERATOR LEAD LINE POLE	⊥
UNDERGROUND COLLECTION LINE	---
OVERHEAD COLLECTION LINE	---
EXISTING CONTOUR (2' INTERVAL)	---
EXISTING CONTOUR - INDEX (2' INTERVAL)	---
CONTOUR - FINISHED (2' INTERVAL)	---
CONTOUR - FINISHED - INDEX (2' INTERVAL)	---
ACCESS ROAD CENTERLINE	---
PERMANENT ACCESS ROAD EDGE	---
STORM PIPE / CULVERT	---
NYSDEC WETLAND	---
WETLAND BOUNDARY	---
STREAM BOUNDARY	---
APPROXIMATE WETLAND BOUNDARY	---
APPROXIMATE STREAM BOUNDARY	---
ENVIRONMENTALLY SENSITIVE AREA - RESTRICTED ACCESS	---
ENVIRONMENTALLY SENSITIVE AREA	---
WIND TURBINE CONSTRUCTION SITE	---
ROTOR LAYDOWN	---
WIND TURBINE	---
GRAVEL PAD	---
WORK AREA	---
CRANE PAD	---

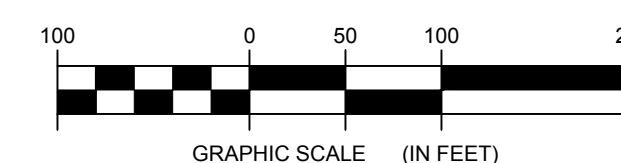

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PROFILE LEGEND	
ITEM	SYMBOL
EXISTING ELEVATION (FT)	1845.3
PROPOSED ELEVATION (FT)	1845.27
EXISTING GRADE	---
PROPOSED GRADE	---

NOTE: ELEVATIONS IN USGS DATUM.

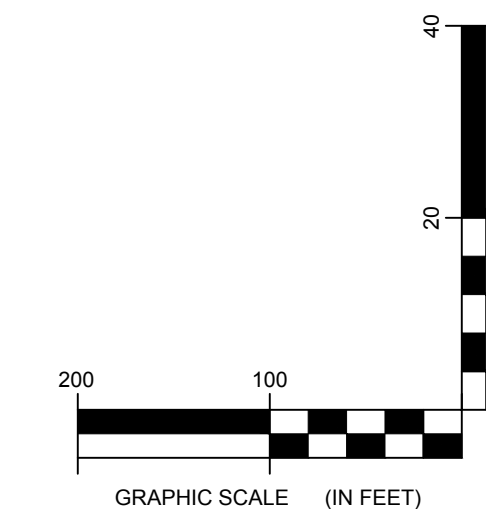


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151403 C:\projects\151403\151403.dwg 10/18/16 10:00 AM

DRAWING REVISIONS	
NO.	DATE

PROJECT TITLE: **CASSADAGA WIND PROJECT**
TOWNS OF CHARLOTTE, CHERRY CREEK, ARKWRIGHT, AND STOCKTON
PROJECT LOCATION: CHAUTAQUA COUNTY, NEW YORK
CLIENT: CASSADAGA WIND LLC
DRAWING TITLE: ACCESS ROAD PLAN AND PROFILE

DATE:	APRIL 22, 2016
SCALE:	AS NOTED
JOB NO.:	14048
DRAWN BY:	AW, CB, ZR
CHECKED BY:	TD
FILE NAME:	14048_Working_SE.dwg
DRAWING NUMBER:	SE-103

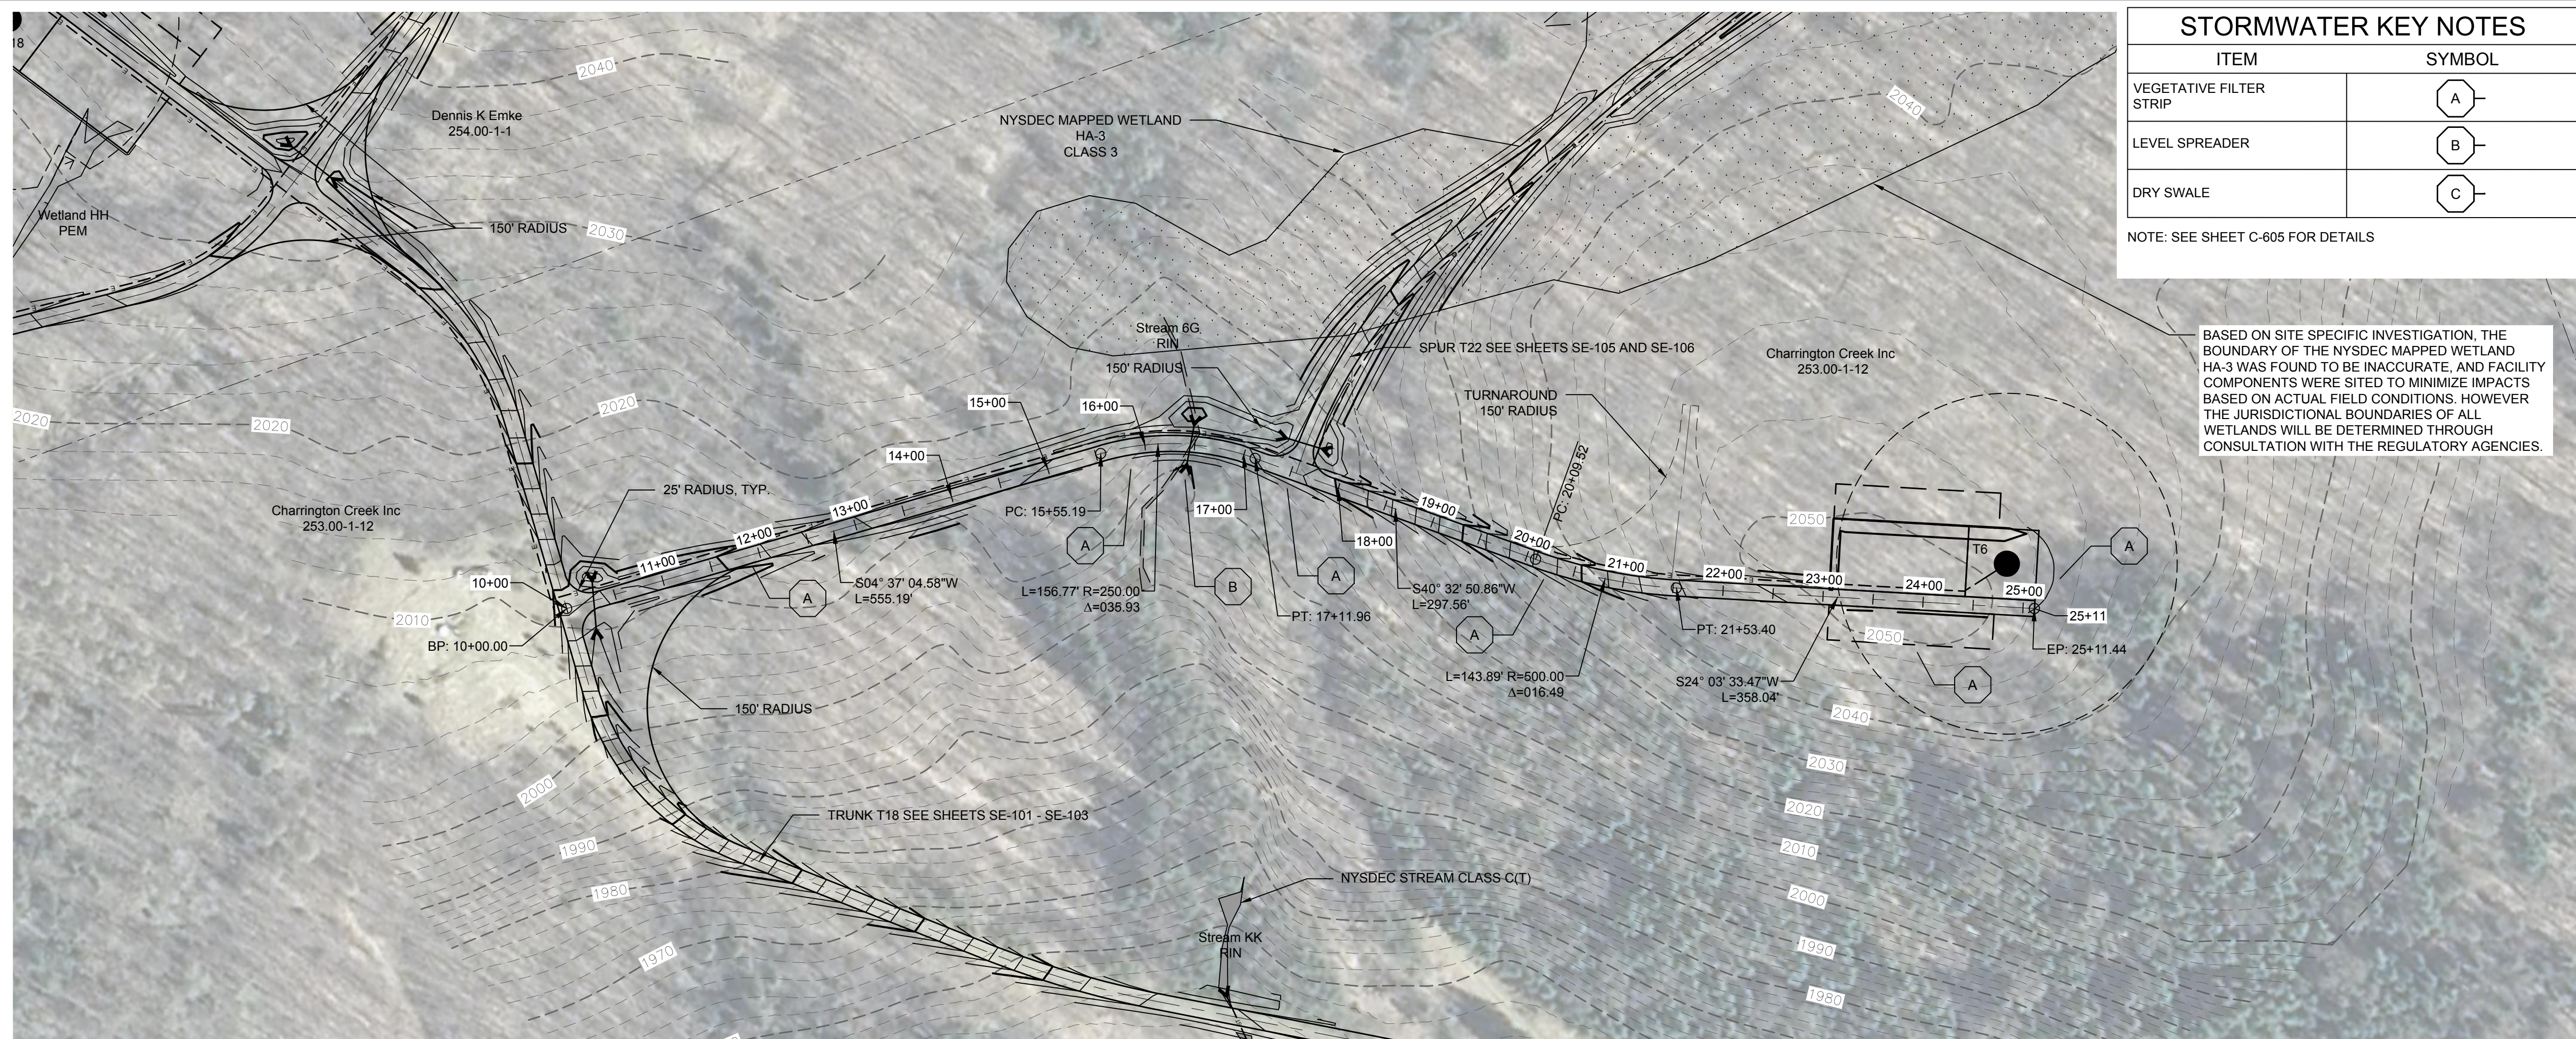


STORMWATER KEY NOTES	
ITEM	SYMBOL
VEGETATIVE FILTER STRIP	(A)
LEVEL SPREADER	(B)
DRY SWALE	(C)

NOTE: SEE SHEET C-605 FOR DETAILS

BASED ON SITE SPECIFIC INVESTIGATION, THE BOUNDARY OF THE NYSDEC MAPPED WETLAND HA-3 WAS FOUND TO BE INACCURATE, AND FACILITY COMPONENTS WERE SITED TO MINIMIZE IMPACTS BASED ON ACTUAL FIELD CONDITIONS. HOWEVER THE JURISDICTIONAL BOUNDARIES OF ALL WETLANDS WILL BE DETERMINED THROUGH CONSULTATION WITH THE REGULATORY AGENCIES.

LEGEND	
ITEM	SYMBOL
DRAWING SHEET MATCH LINE	--- DRAWING NUMBER --- --- DRAWING NUMBER ---
WIND TURBINE DESIGNATION	T53
PARCEL BOUNDARY	---
115 KV OVERHEAD GENERATOR LEAD LINE	---
115 KV OVERHEAD GENERATOR LEAD LINE POLE	●
UNDERGROUND COLLECTION LINE	---
OVERHEAD COLLECTION LINE	---
EXISTING CONTOUR (2' INTERVAL)	---
EXISTING CONTOUR - INDEX (2' INTERVAL)	---
CONTOUR - FINISHED (2' INTERVAL)	---
CONTOUR - FINISHED - INDEX (2' INTERVAL)	---
ACCESS ROAD CENTERLINE	---
PERMANENT ACCESS ROAD EDGE	---
STORM PIPE / CULVERT	---
NYSDEC WETLAND	---
WETLAND BOUNDARY	---
STREAM BOUNDARY	---
APPROXIMATE WETLAND BOUNDARY	---
APPROXIMATE STREAM BOUNDARY	---
ENVIRONMENTALLY SENSITIVE AREA - RESTRICTED ACCESS	---
ENVIRONMENTALLY SENSITIVE AREA	---
WIND TURBINE CONSTRUCTION SITE	---
ROTOR LAYDOWN	---
WIND TURBINE	---
GRAVEL PAD	---
WORK AREA	---
CRANE PAD	---


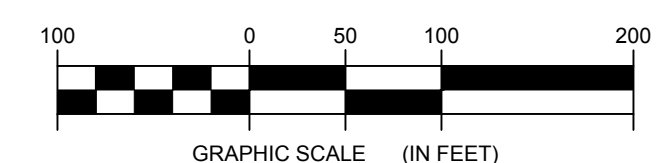


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PROFILE LEGEND	
ITEM	SYMBOL
EXISTING ELEVATION (FT)	1845.3
PROPOSED ELEVATION (FT)	1845.27
EXISTING GRADE	---
PROPOSED GRADE	---

NOTE: ELEVATIONS IN USGS DATUM.

1 PLAN VIEW - SPUR T6 ACCESS ROAD
Scale: 1"=100'

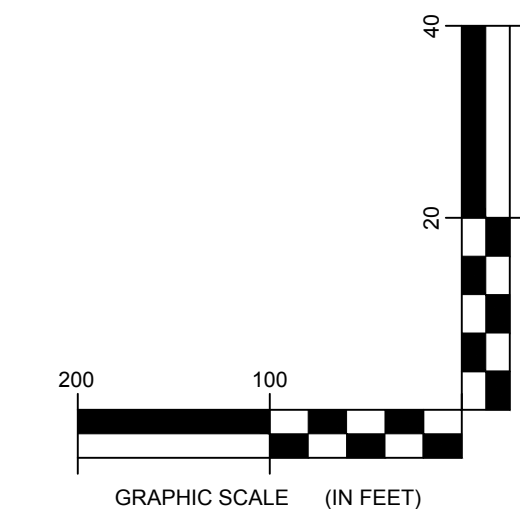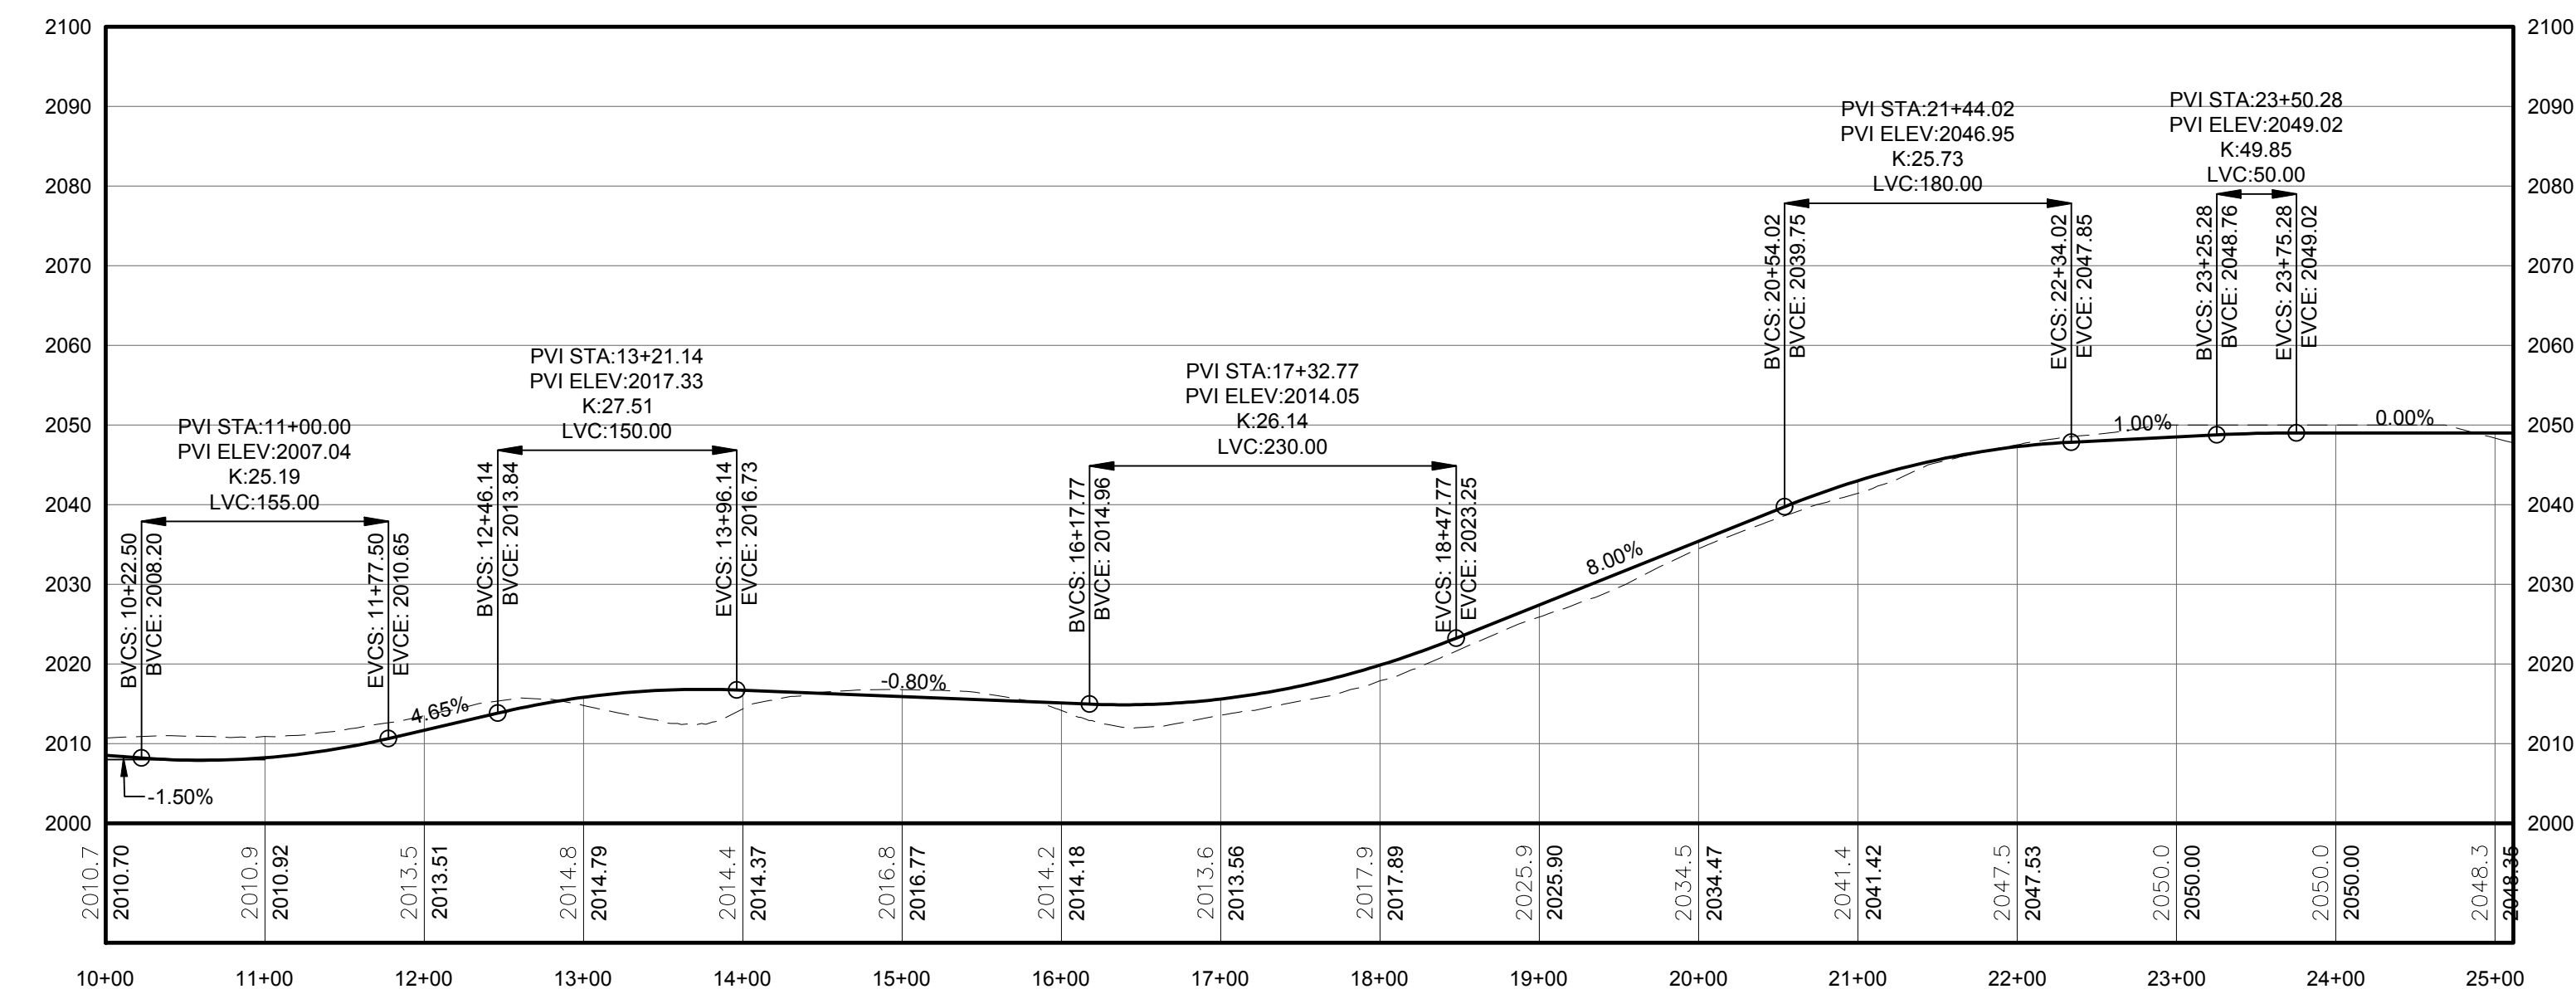

2 ACCESS ROAD PROFILE
Scale: H:1"=100' V:1"=20'




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NO.	DATE	REVISION

PROJECT TITLE: CASSADAGA WIND PROJECT
TOWNS OF CHARLOTTE, CHERRY CREEK, ARKWRIGHT, AND STOCKTON
PROJECT LOCATION: CHAUTAUGUS COUNTY, NEW YORK
CLIENT: CASSADAGA WIND LLC
DRAWING TITLE: ACCESS ROAD PLAN AND PROFILE

DATE:	APRIL 22, 2016
SCALE:	AS NOTED
JOB NO.:	14048
DRAWN BY:	AW, CB, ZR
CHECKED BY:	TD
FILE NAME:	14048_Working_SE.dwg
DRAWING NUMBER:	SE-104

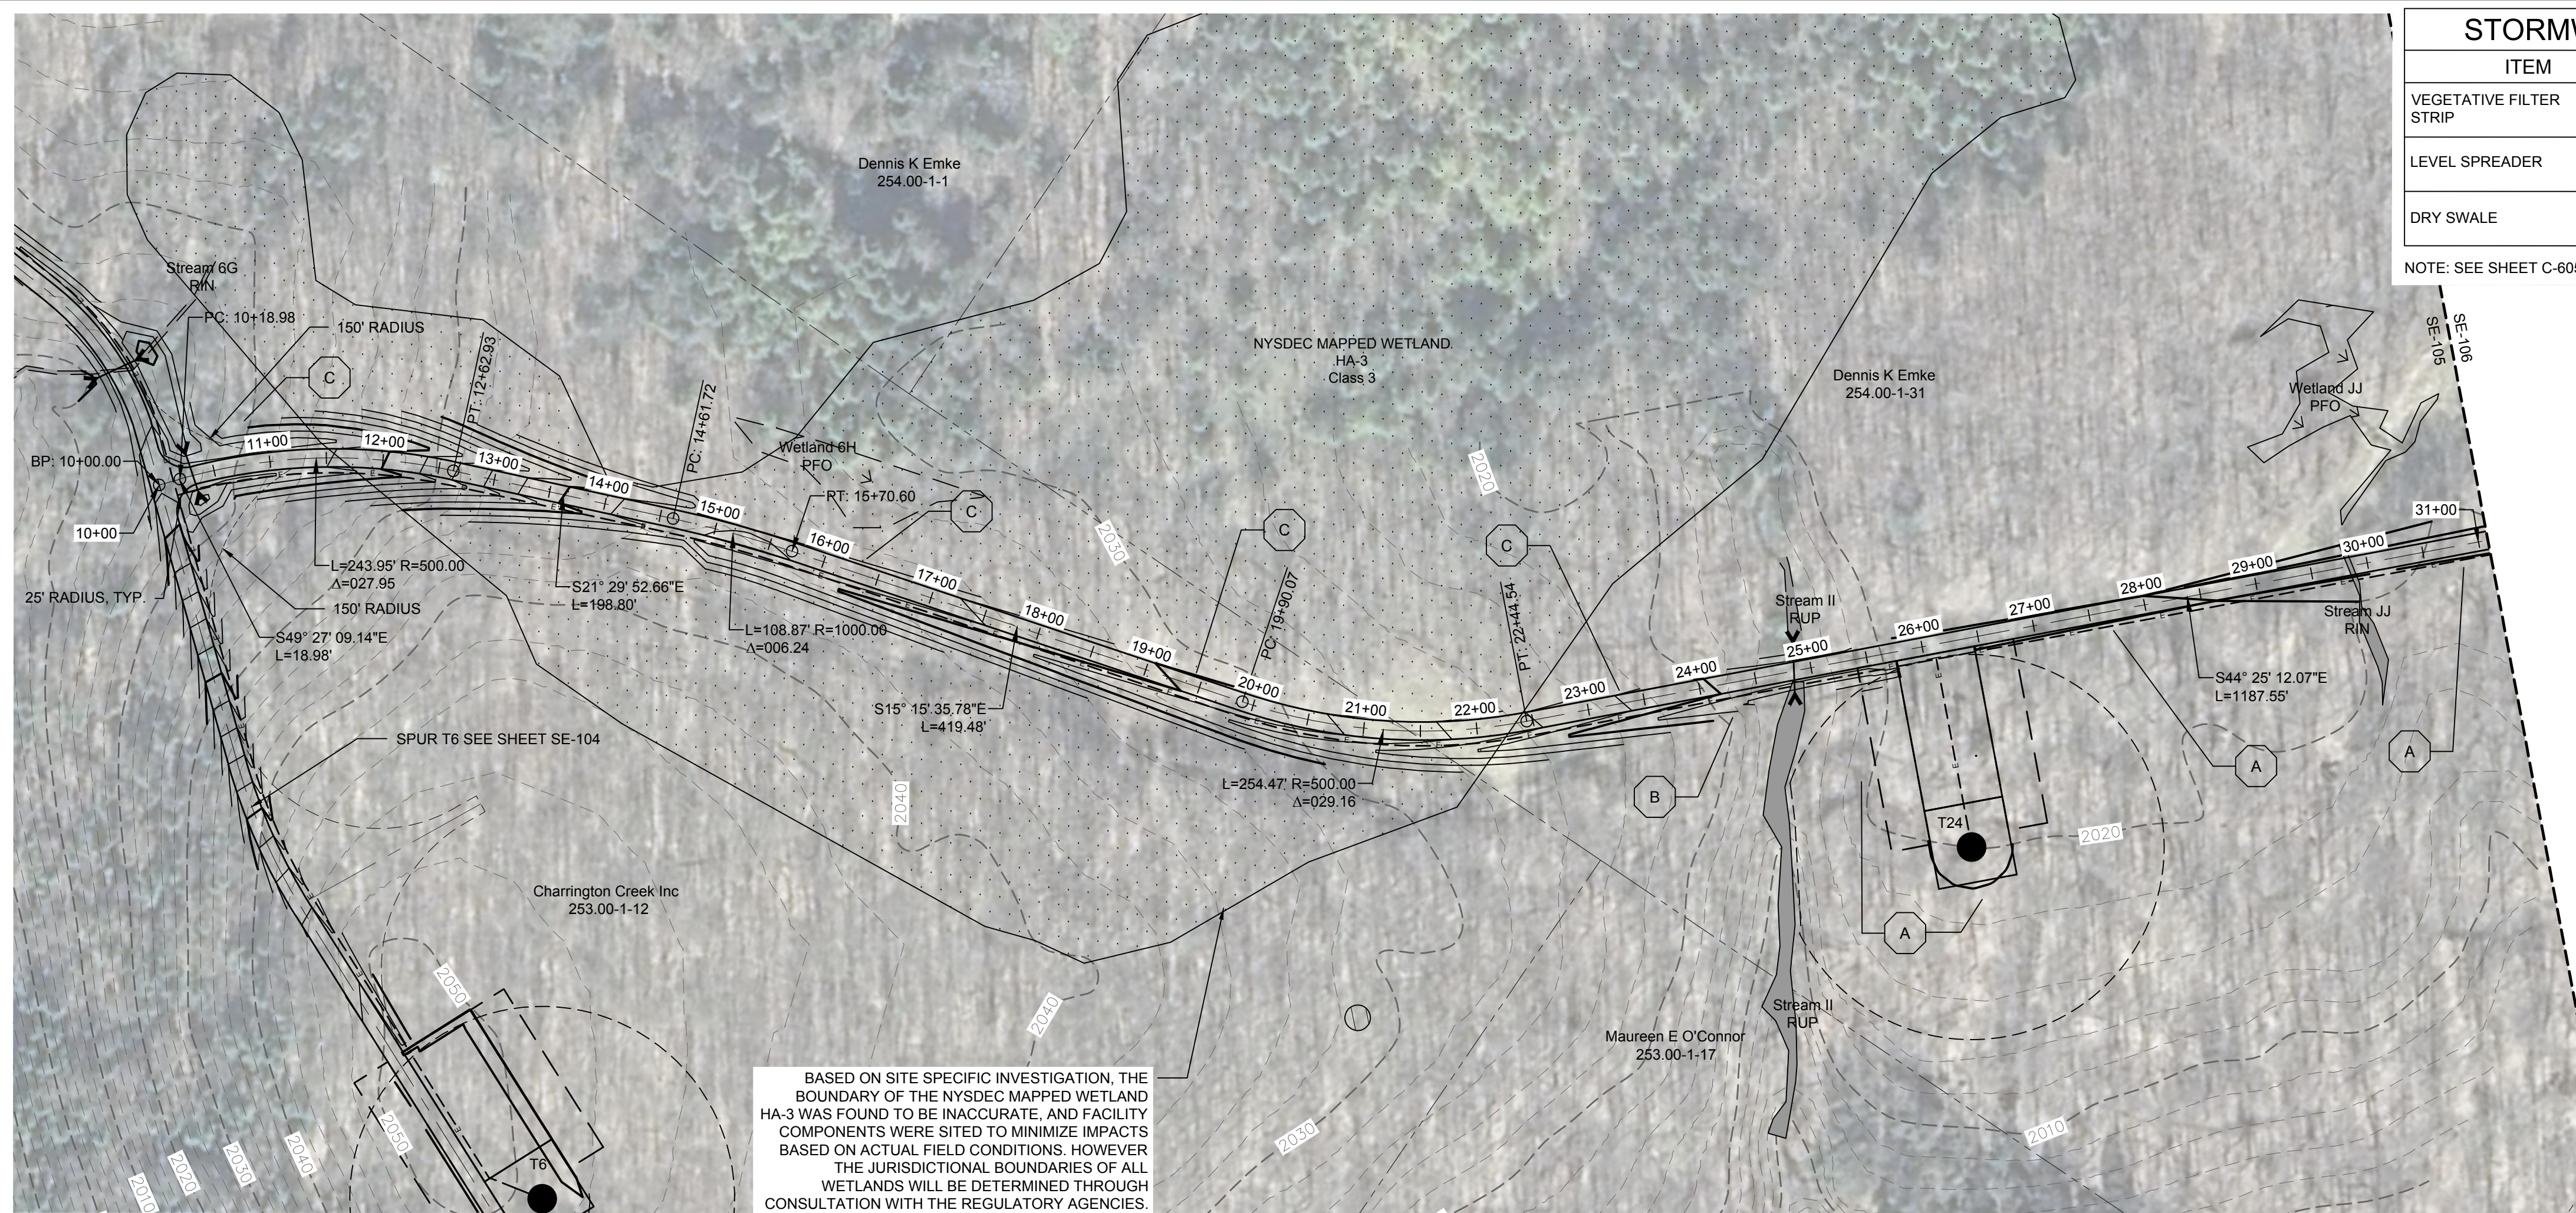


STORMWATER KEY NOTES	
ITEM	SYMBOL
VEGETATIVE FILTER STRIP	(A)
LEVEL SPREADER	(B)
DRY SWALE	(C)

NOTE: SEE SHEET C-605 FOR DETAILS

LEGEND	
ITEM	SYMBOL
DRAWING SHEET MATCH LINE	--- DRAWING NUMBER --- DRAWING NUMBER
WIND TURBINE DESIGNATION	T53
PARCEL BOUNDARY	---
115 KV OVERHEAD GENERATOR LEAD LINE	---
115 KV OVERHEAD GENERATOR LEAD LINE POLE	●
UNDERGROUND COLLECTION LINE	---
OVERHEAD COLLECTION LINE	---
EXISTING CONTOUR (2' INTERVAL)	(490)
EXISTING CONTOUR - INDEX (2' INTERVAL)	(490)
CONTOUR - FINISHED (2' INTERVAL)	(490)
CONTOUR - FINISHED - INDEX (2' INTERVAL)	(490)
ACCESS ROAD CENTERLINE	---
PERMANENT ACCESS ROAD EDGE	---
STORM PIPE / CULVERT	---
NYSDEC WETLAND	---
WETLAND BOUNDARY	---
STREAM BOUNDARY	---
APPROXIMATE WETLAND BOUNDARY	---
APPROXIMATE STREAM BOUNDARY	---
ENVIRONMENTALLY SENSITIVE AREA - RESTRICTED ACCESS	---
ENVIRONMENTALLY SENSITIVE AREA	---
WIND TURBINE CONSTRUCTION SITE	---
ROTOR LAYDOWN	---
WIND TURBINE	---
GRAVEL PAD	---
WORK AREA	---
CRANE PAD	---

BASED ON SITE SPECIFIC INVESTIGATION, THE BOUNDARY OF THE NYSDEC MAPPED WETLAND HA-3 WAS FOUND TO BE INACCURATE, AND FACILITY COMPONENTS WERE SITED TO MINIMIZE IMPACTS BASED ON ACTUAL FIELD CONDITIONS. HOWEVER THE JURISDICTIONAL BOUNDARIES OF ALL WETLANDS WILL BE DETERMINED THROUGH CONSULTATION WITH THE REGULATORY AGENCIES.


1 PLAN VIEW - SPUR T22 ACCESS ROAD
105 Scale: 1"=100'

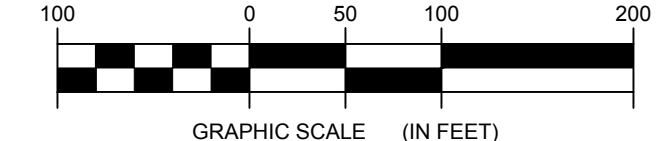


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PROFILE LEGEND	
ITEM	SYMBOL
EXISTING ELEVATION (FT)	1845.3
PROPOSED ELEVATION (FT)	1845.27
EXISTING GRADE	---
PROPOSED GRADE	---

NOTE: ELEVATIONS IN USGS DATUM.

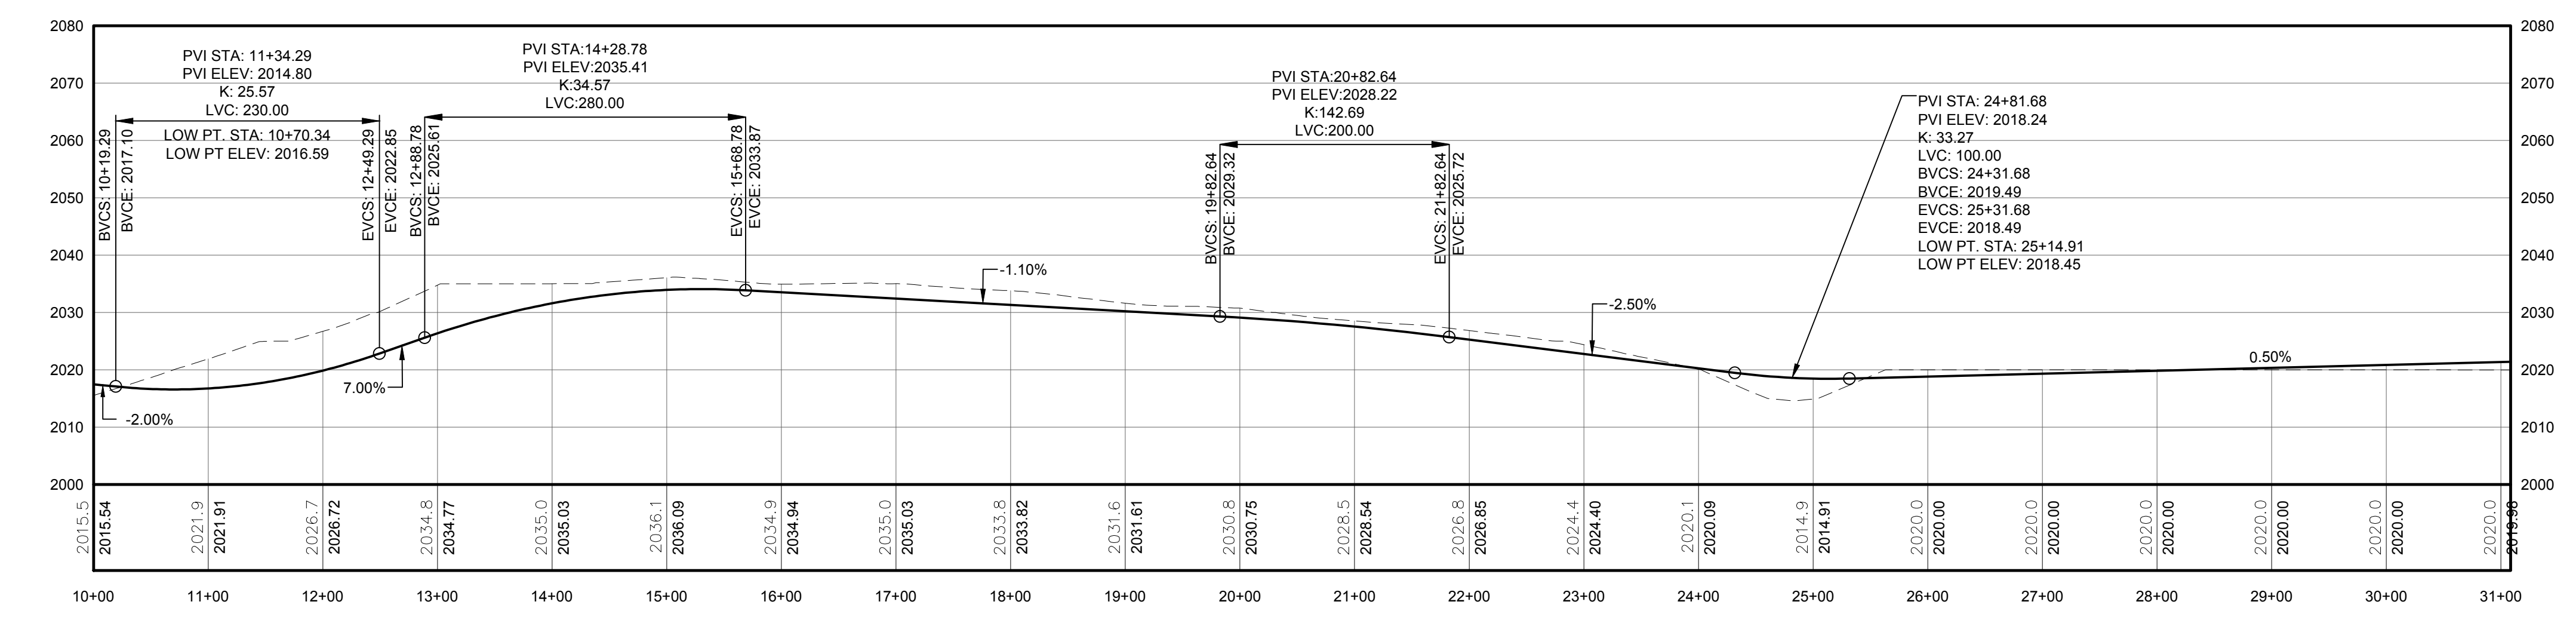


2 ACCESS ROAD PROFILE
105 Scale: H:1"=100' V:1"=20'

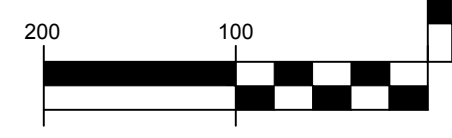

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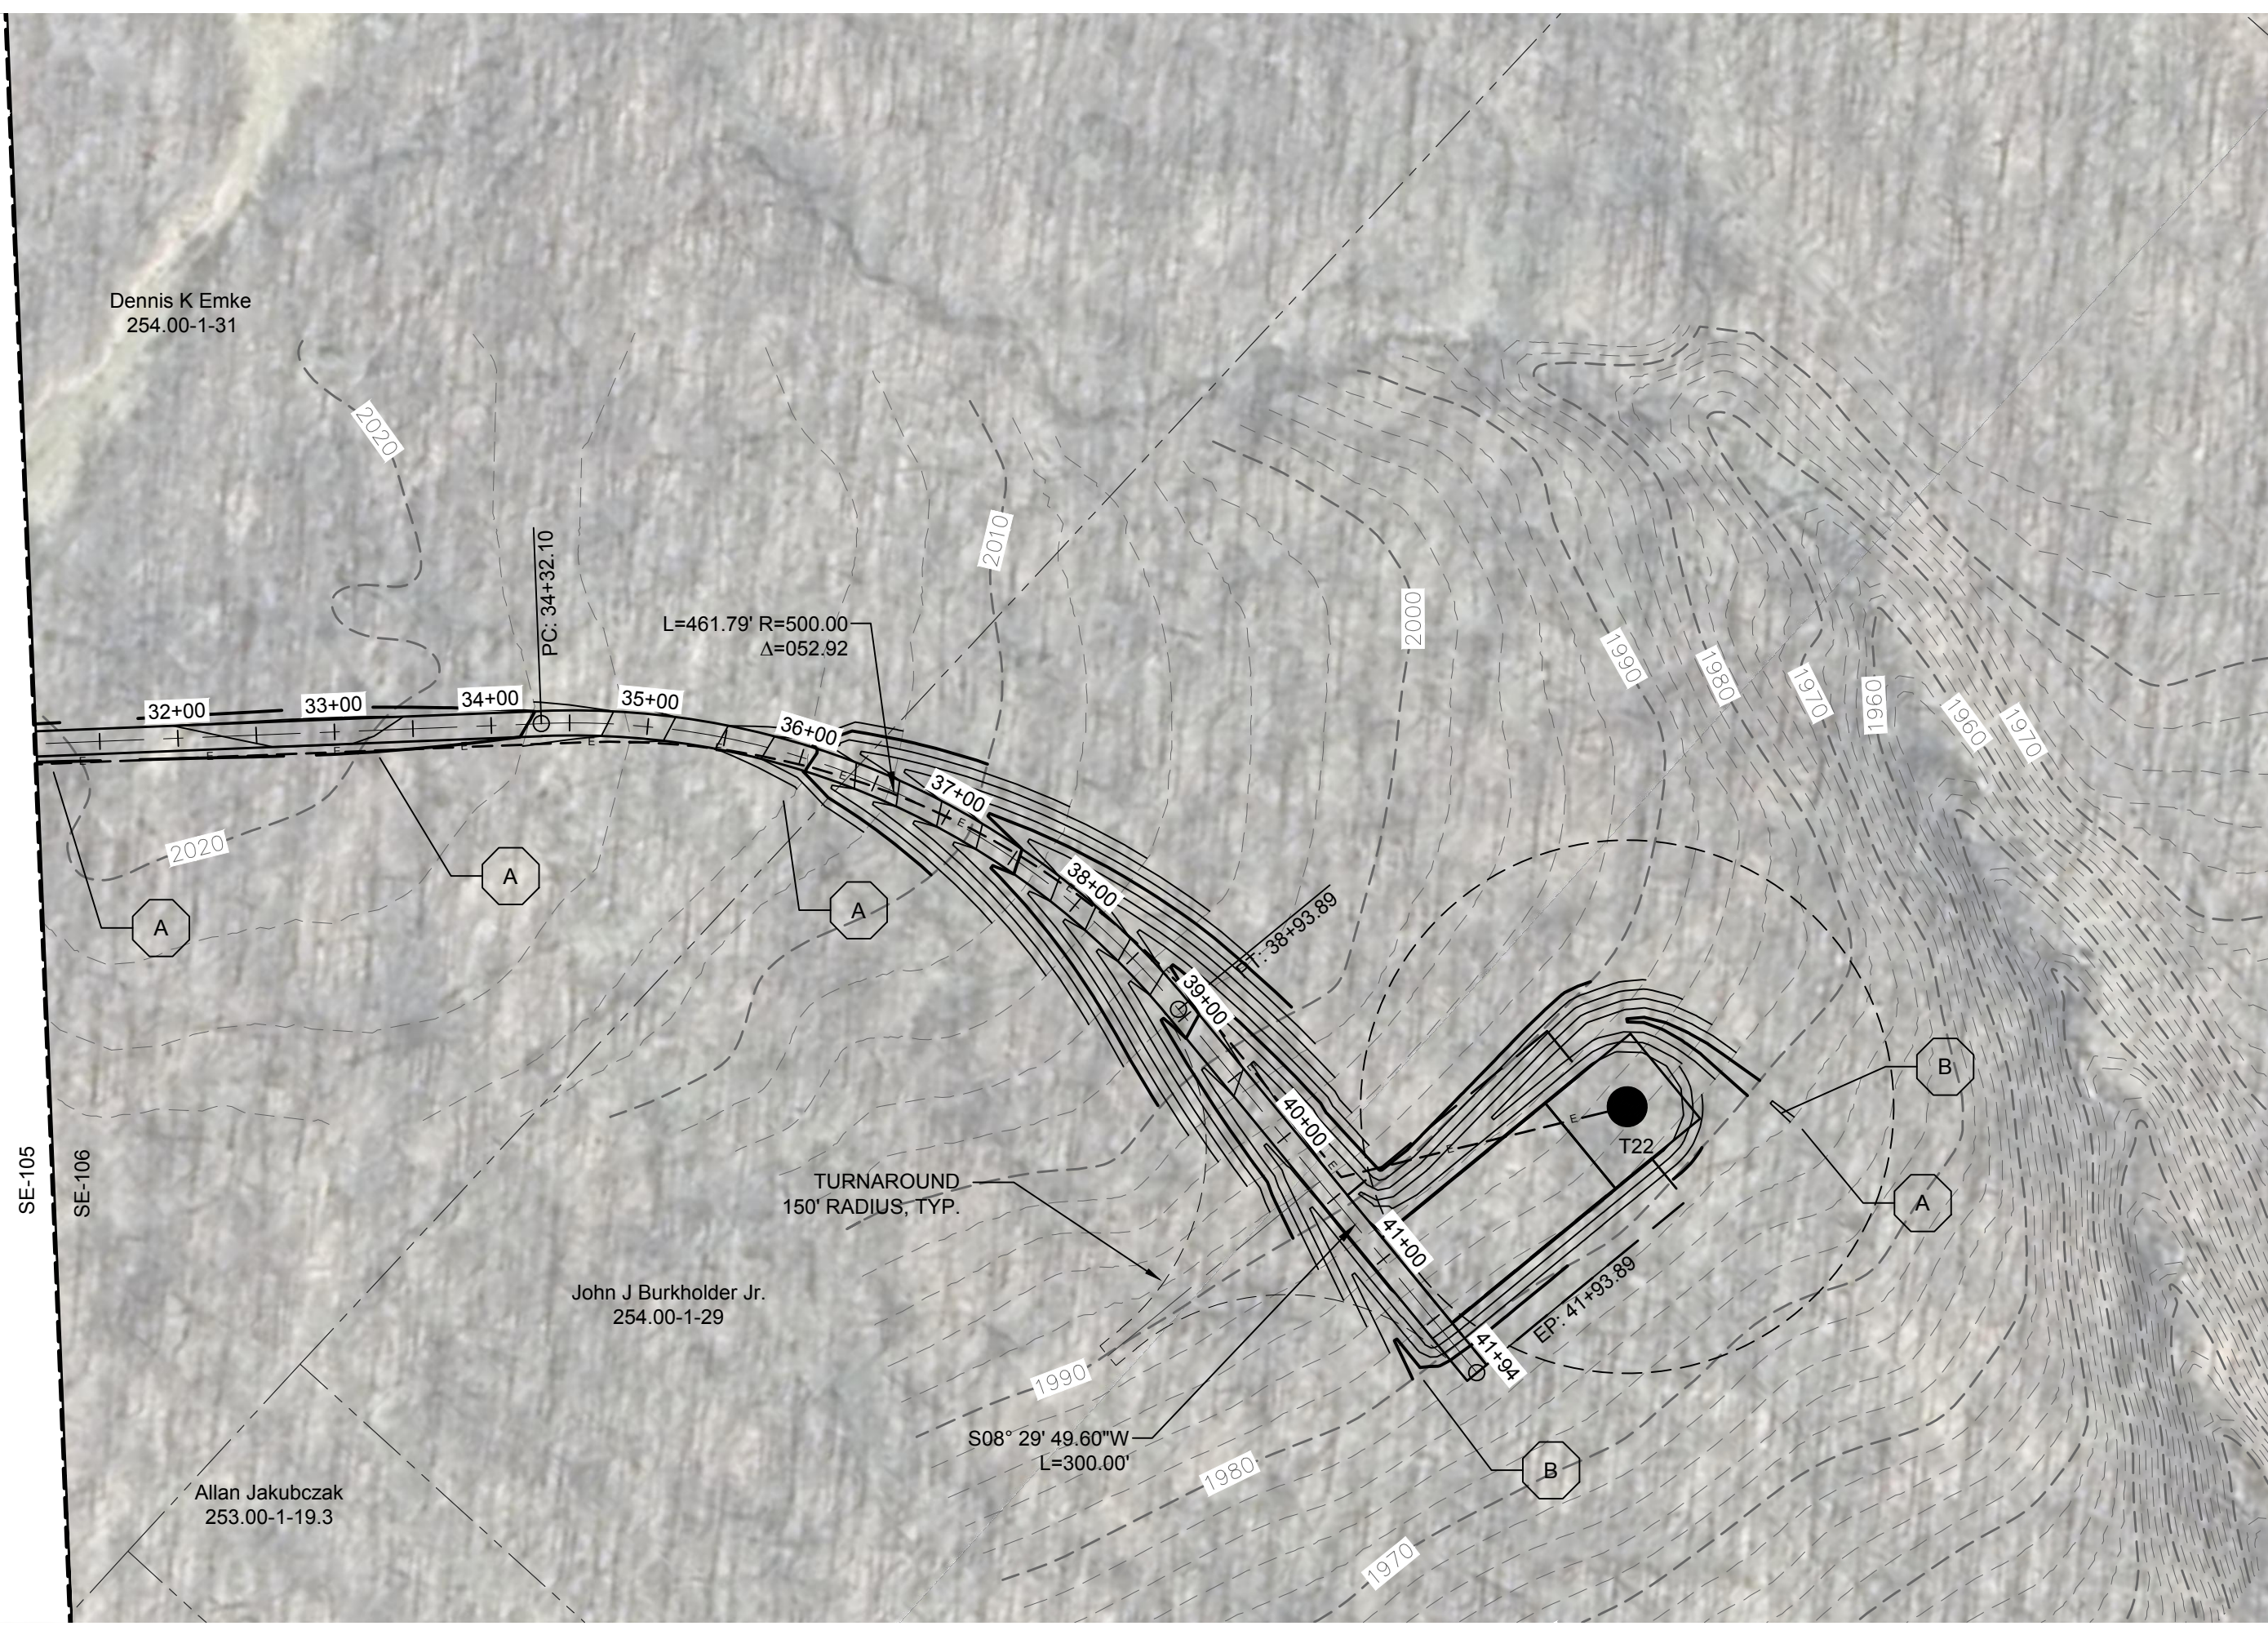
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NO.	DATE

PROJECT TITLE: **CASSADAGA WIND PROJECT**
TOWNS OF CHARLOTTE, CHERRY CREEK, ARKWRIGHT, AND STOCKTON
PROJECT LOCATION: CHAUTAUGUS COUNTY, NEW YORK
CLIENT: CASSADAGA WIND LLC
DRAWING TITLE: **ACCESS ROAD PLAN AND PROFILE**

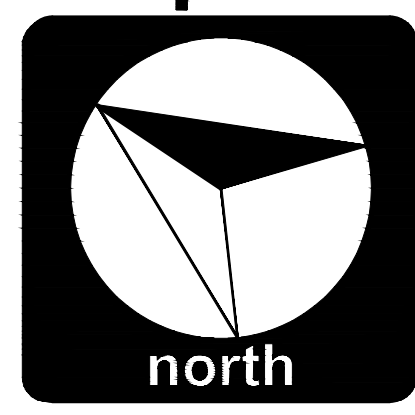
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SCALE:	AS NOTED
EDR JOB#:	14048
DRAWN BY:	AW, CB, ZR
CHECKED BY:	TD
FILE NAME:	14048_Working_SE.dwg
DRAWING NUMBER:	SE-105



STORMWATER KEY NOTES	
ITEM	SYMBOL
VEGETATIVE FILTER STRIP	(A)
LEVEL SPREADER	(B)
DRY SWALE	(C)

NOTE: SEE SHEET C-605 FOR DETAILS


LEGEND	
ITEM	SYMBOL
DRAWING SHEET MATCH LINE	--- DRAWING NUMBER --- DRAWING NUMBER
WIND TURBINE DESIGNATION	T53
PARCEL BOUNDARY	---
115 KV OVERHEAD GENERATOR LEAD LINE	--- 115KV ---
115 KV OVERHEAD GENERATOR LEAD LINE POLE	■
UNDERGROUND COLLECTION LINE	---
OVERHEAD COLLECTION LINE	---
EXISTING CONTOUR (2' INTERVAL)	---
EXISTING CONTOUR - INDEX (2' INTERVAL)	---(490)---
CONTOUR - FINISHED (2' INTERVAL)	---(498)---
CONTOUR - FINISHED - INDEX (2' INTERVAL)	---(490)---
ACCESS ROAD CENTERLINE	---
PERMANENT ACCESS ROAD EDGE	---
STORM PIPE / CULVERT	--->---
NYSDEC WETLAND	[Pattern]
WETLAND BOUNDARY	↓ ↓ ↓
STREAM BOUNDARY	[Pattern]
APPROXIMATE WETLAND BOUNDARY	↓ ↓ ↓
APPROXIMATE STREAM BOUNDARY	[Pattern]
ENVIRONMENTALLY SENSITIVE AREA - RESTRICTED ACCESS	[Pattern]
ENVIRONMENTALLY SENSITIVE AREA	[Pattern]
WIND TURBINE CONSTRUCTION SITE	[Diagram]
ROTOR LAYDOWN	[Diagram]
WIND TURBINE	[Diagram]
GRAVEL PAD	[Diagram]
WORK AREA	[Diagram]
CRANE PAD	[Diagram]

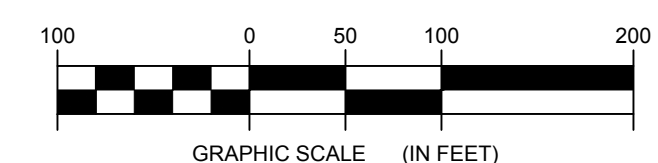


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PROFILE LEGEND	
ITEM	SYMBOL
EXISTING ELEVATION (FT)	1845.3
PROPOSED ELEVATION (FT)	1845.27
EXISTING GRADE	---
PROPOSED GRADE	---

NOTE: ELEVATIONS IN USGS DATUM.

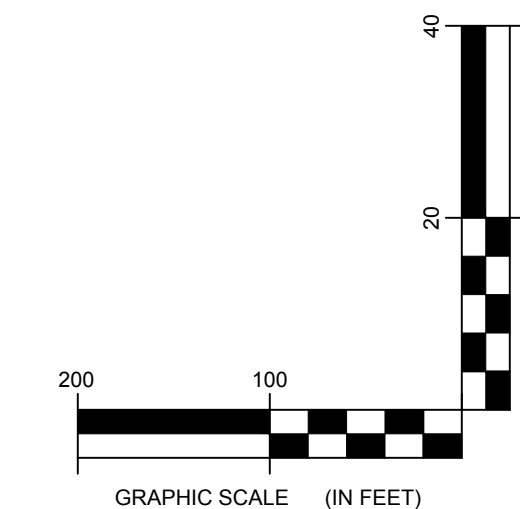



1 PLAN VIEW - SPUR T22
Scale: 1"=100'

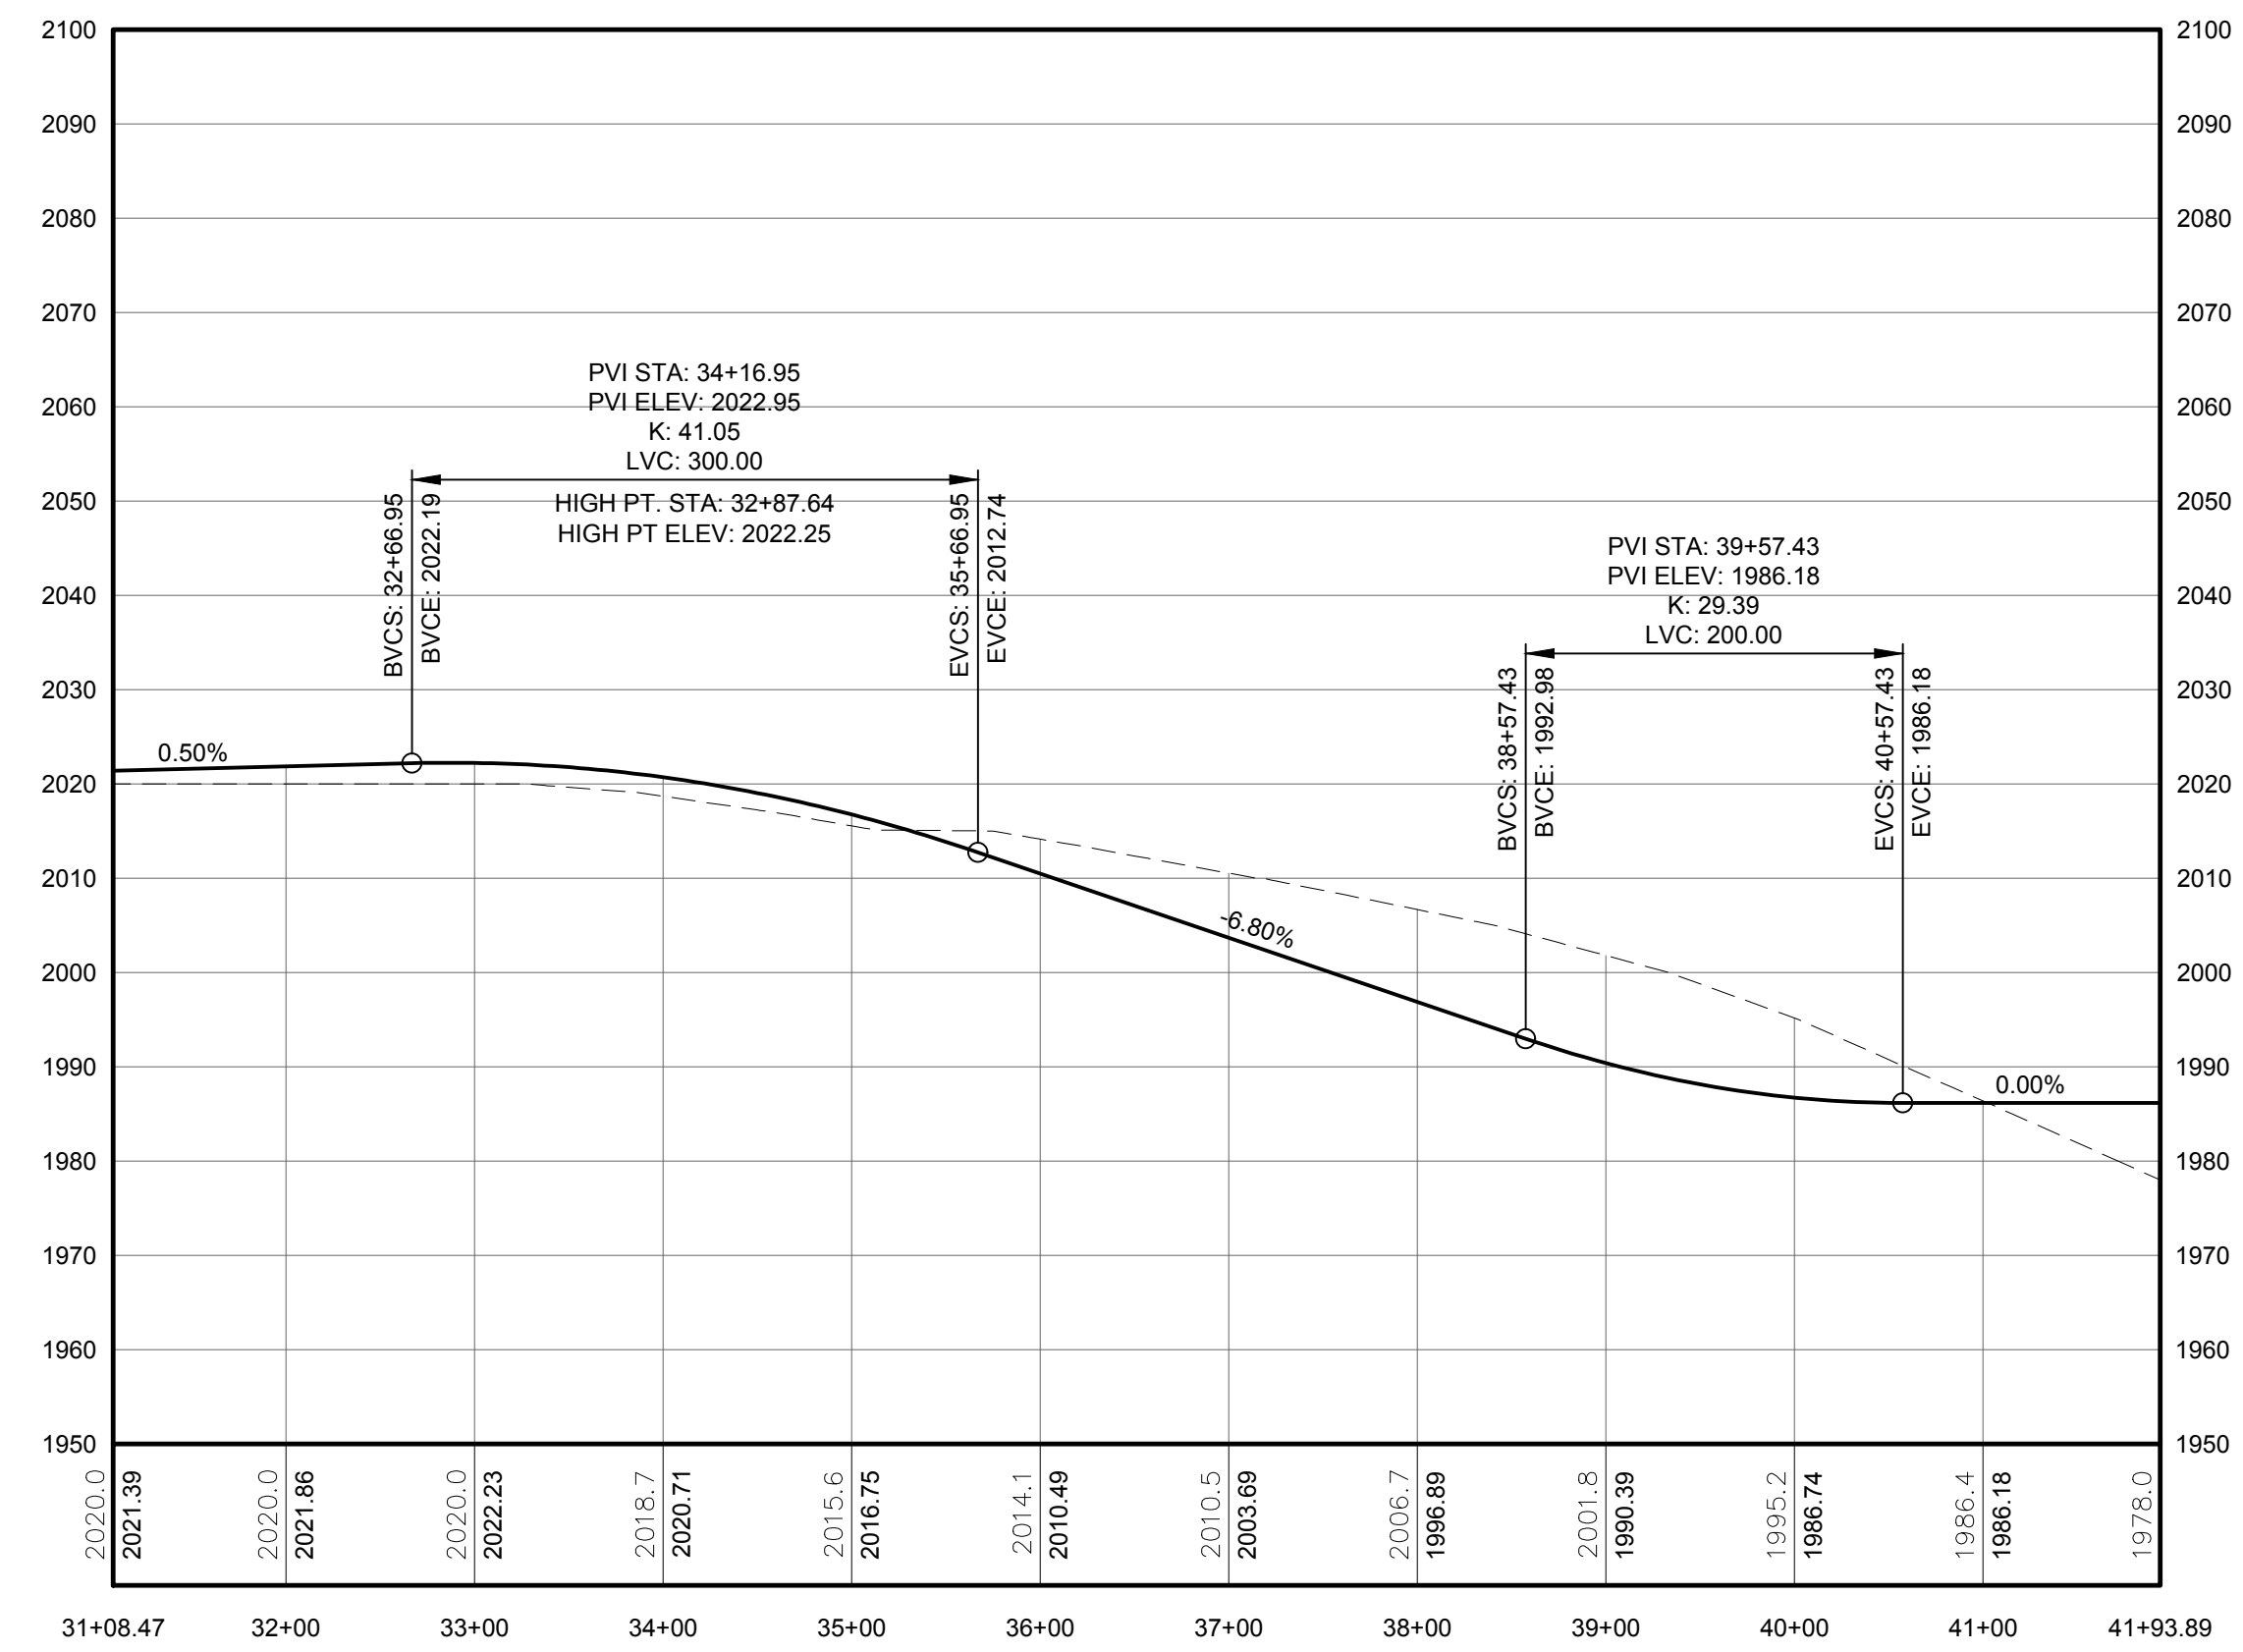

2 ACCESS ROAD PROFILE
Scale: H:1"=100' V:1"=20'



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NO.	DATE	REVISION

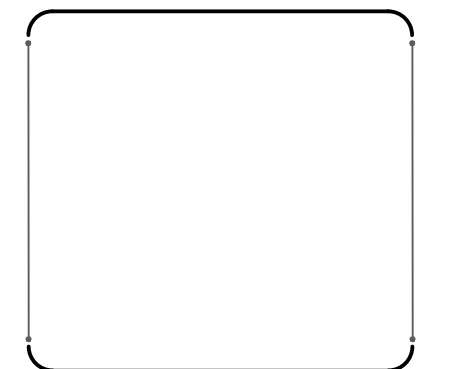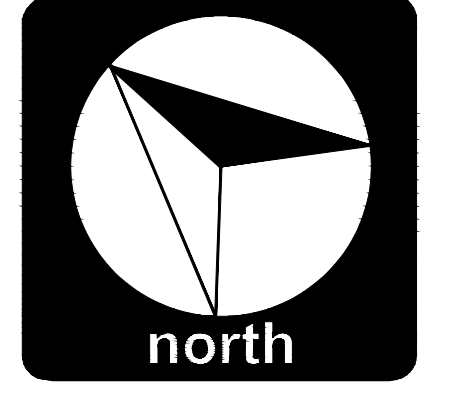PROJECT TITLE: CASSADAGA WIND PROJECT
TOWNS OF CHARLOTTE, CHERRY CREEK, ARKWRIGHT, AND STOCKTON
PROJECT LOCATION: CHAUTAUGUA COUNTY, NEW YORK
CLIENT: CASSADAGA WIND LLC
DRAWING TITLE: ACCESS ROAD PLAN AND PROFILE

DATE	APRIL 22, 2016
SCALE	AS NOTED
EDR JOB#	14048
DRAWN BY	AW, CB, ZR
CHECKED BY	TD
FILE NAME	14048_Working_SE.dwg
DRAWING NUMBER	SE-106



STORMWATER KEY NOTES	
ITEM	SYMBOL
VEGETATIVE FILTER STRIP	(A)
LEVEL SPREADER	(B)
DRY SWALE	(C)


NOTE: SEE SHEET C-605 FOR DETAILS

LEGEND	
ITEM	SYMBOL
DRAWING SHEET MATCH LINE	--- DRAWING NUMBER ---
WIND TURBINE DESIGNATION	T53
PARCEL BOUNDARY	---
115 KV OVERHEAD GENERATOR LEAD LINE	---
115 KV OVERHEAD GENERATOR LEAD LINE POLE	⊙
UNDERGROUND COLLECTION LINE	---
OVERHEAD COLLECTION LINE	---
EXISTING CONTOUR (2' INTERVAL)	---
EXISTING CONTOUR - INDEX (2' INTERVAL)	---
CONTOUR - FINISHED (2' INTERVAL)	---
CONTOUR - FINISHED - INDEX (2' INTERVAL)	---
ACCESS ROAD CENTERLINE	---
PERMANENT ACCESS ROAD EDGE	---
STORM PIPE / CULVERT	---
NYSDEC WETLAND	---
WETLAND BOUNDARY	---
STREAM BOUNDARY	---
APPROXIMATE WETLAND BOUNDARY	---
APPROXIMATE STREAM BOUNDARY	---
ENVIRONMENTALLY SENSITIVE AREA - RESTRICTED ACCESS	---
ENVIRONMENTALLY SENSITIVE AREA	---
WIND TURBINE CONSTRUCTION SITE	---
ROTOR LAYDOWN	---
WIND TURBINE	---
GRAVEL PAD	---
WORK AREA	---
CRANE PAD	---


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everpower™

1 PLAN VIEW - SPUR T37 - T1 ACCESS ROAD TO TURBINES 37, 12, 27, 9, 2, AND 1
 107 Scale: 1"=100'

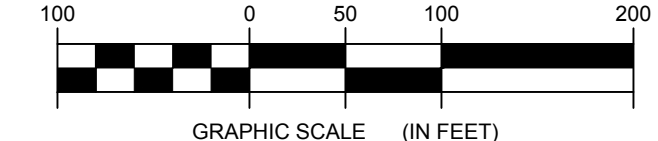


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PROFILE LEGEND	
ITEM	SYMBOL
EXISTING ELEVATION (FT)	1845.3
PROPOSED ELEVATION (FT)	1845.27
EXISTING GRADE	---
PROPOSED GRADE	---

NOTE: ELEVATIONS IN USGS DATUM.

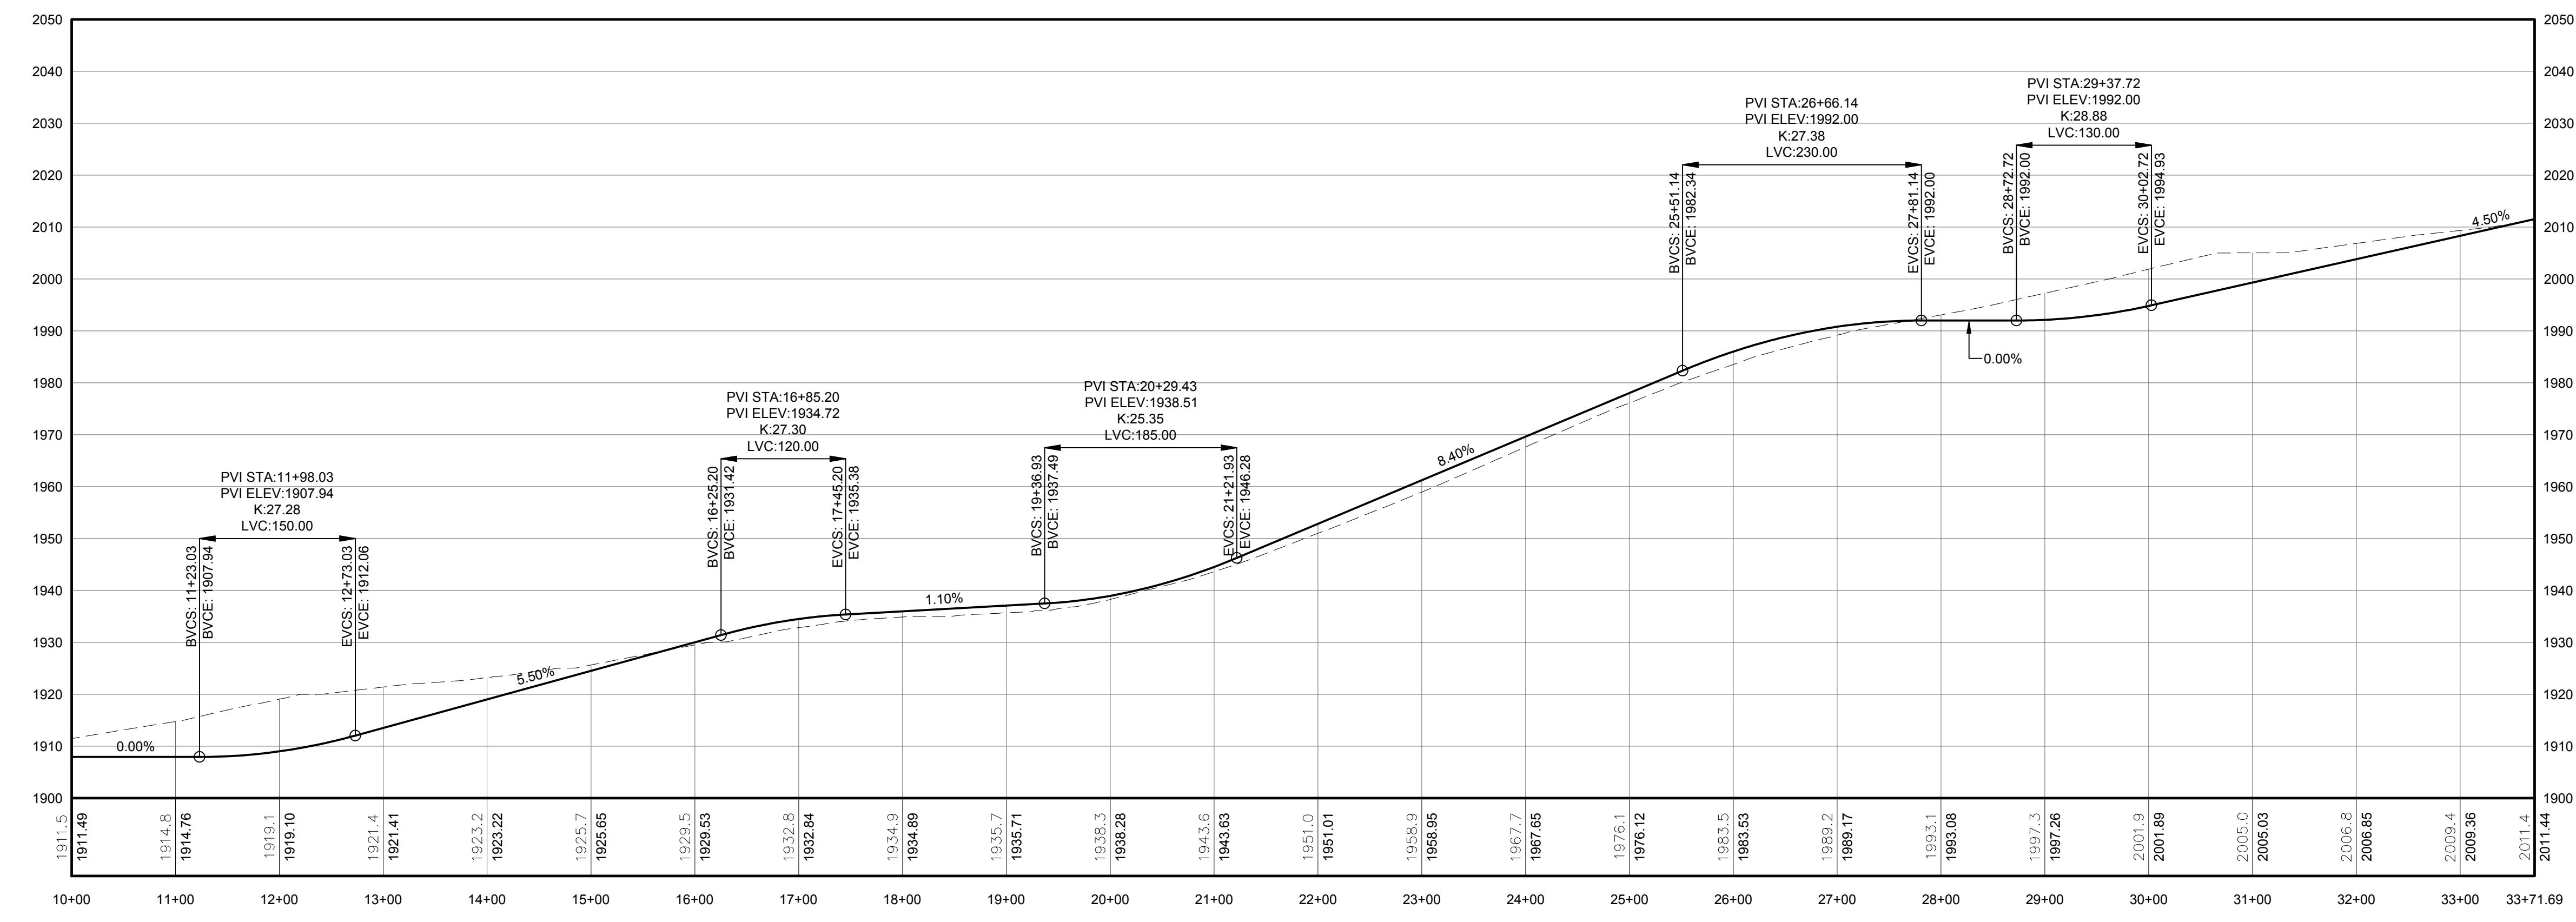


2 ACCESS ROAD PROFILE
 107 Scale: H:1"=100' V:1"=20'

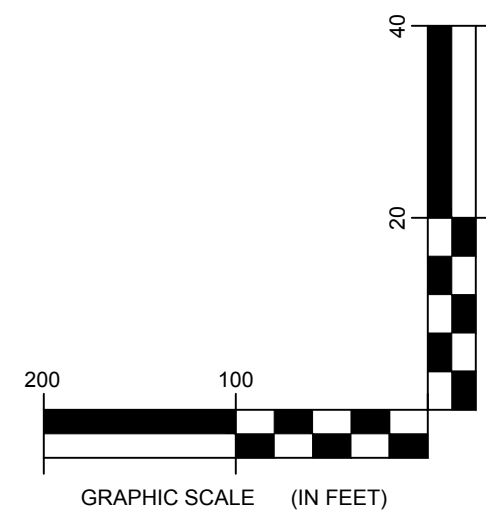DRAWING REVISIONS	
NO.	DATE

PROJECT TITLE: **CASSADAGA WIND PROJECT**
 TOWNS OF CHARLOTTE, CHERRY CREEK, ARKWRIGHT, AND STOCKTON
 PROJECT LOCATION: CHAUTAUGUS COUNTY, NEW YORK
 CLIENT: CASSADAGA WIND LLC
 DRAWING TITLE: **ACCESS ROAD PLAN AND PROFILE**


DATE:	APRIL 22, 2016
SCALE:	AS NOTED
EDR JOB#:	14048
DRAWN BY:	AW, CB, ZR
CHECKED BY:	TD
FILE NAME:	14048_Working_SE.dwg
DRAWING NUMBER:	SE-107

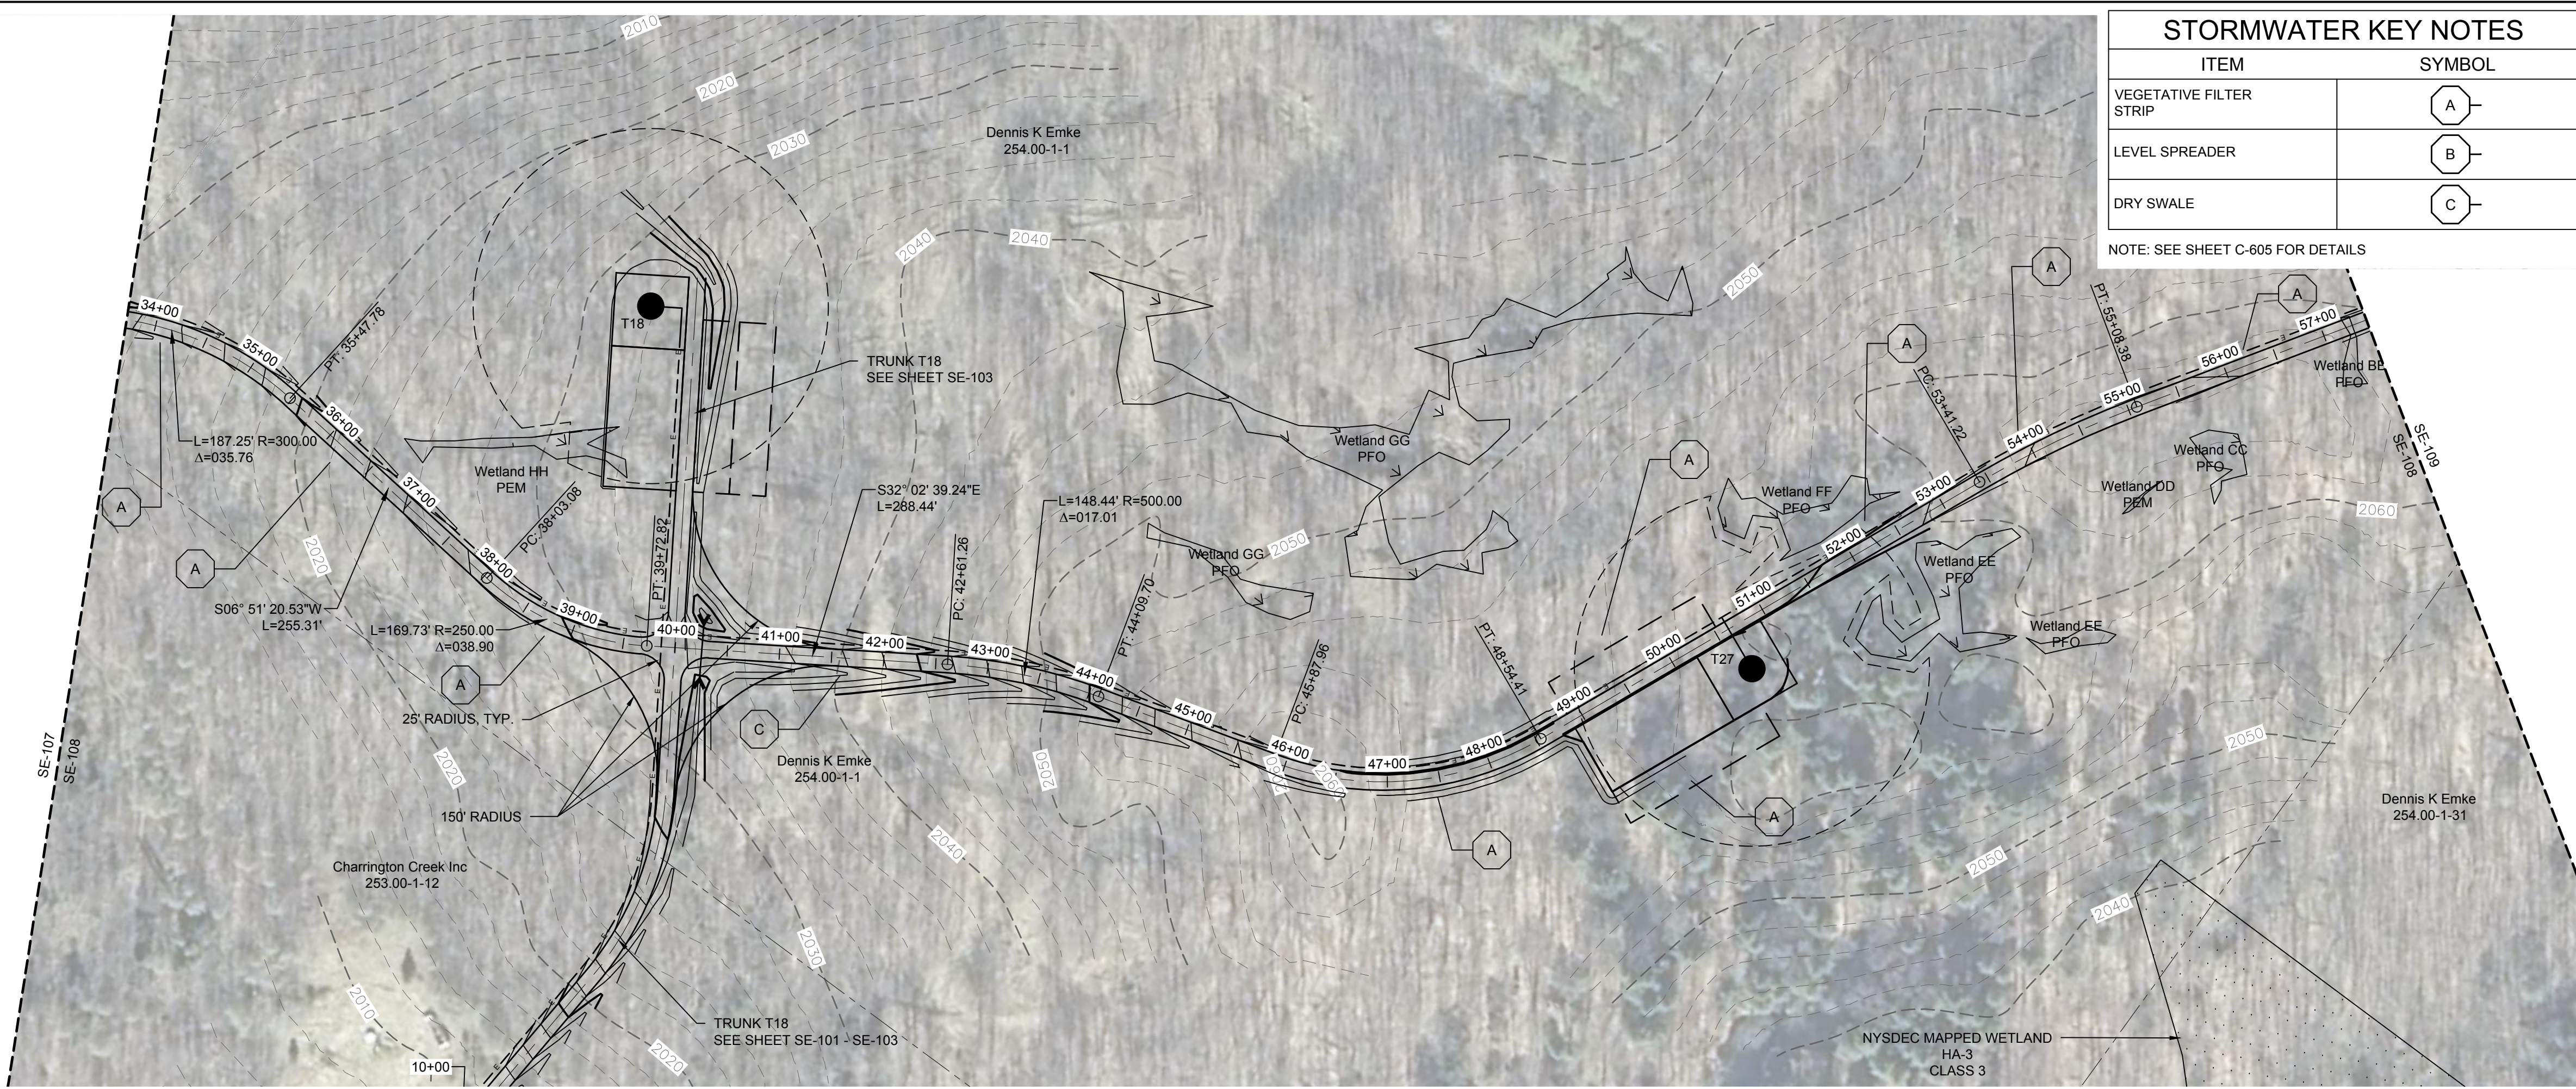


STORMWATER KEY NOTES	
ITEM	SYMBOL
VEGETATIVE FILTER STRIP	(A)
LEVEL SPREADER	(B)
DRY SWALE	(C)

LEGEND	
ITEM	SYMBOL
DRAWING SHEET MATCH LINE	--- DRAWING NUMBER --- --- DRAWING NUMBER ---
WIND TURBINE DESIGNATION	T53
PARCEL BOUNDARY	---
115 KV OVERHEAD GENERATOR LEAD LINE	---
115 KV OVERHEAD GENERATOR LEAD LINE POLE	⊙
UNDERGROUND COLLECTION LINE	---
OVERHEAD COLLECTION LINE	---
EXISTING CONTOUR (2' INTERVAL)	---
EXISTING CONTOUR - INDEX (2' INTERVAL)	---
CONTOUR - FINISHED (2' INTERVAL)	---
CONTOUR - FINISHED - INDEX (2' INTERVAL)	---
ACCESS ROAD CENTERLINE	---
PERMANENT ACCESS ROAD EDGE	---
STORM PIPE / CULVERT	---
NYSDEC WETLAND	▨
WETLAND BOUNDARY	---
STREAM BOUNDARY	---
APPROXIMATE WETLAND BOUNDARY	---
APPROXIMATE STREAM BOUNDARY	---
ENVIRONMENTALLY SENSITIVE AREA - RESTRICTED ACCESS	▨
ENVIRONMENTALLY SENSITIVE AREA	▨
WIND TURBINE CONSTRUCTION SITE	⊙
ROTOR LAYDOWN	---
WIND TURBINE	⊙
GRAVEL PAD	---
WORK AREA	---
CRANE PAD	---

1 PLAN VIEW - SPUR T37 - T1 ACCESS ROAD TO TURBINES 37, 12, 27, 9, 2, AND 1
108 Scale: 1"=100'

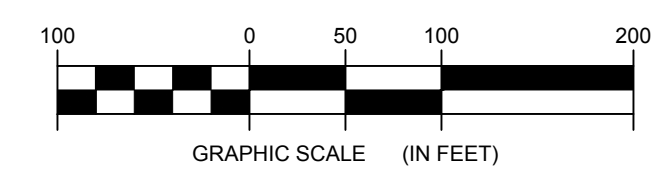


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PROFILE LEGEND	
ITEM	SYMBOL
EXISTING ELEVATION (FT)	1845.3
PROPOSED ELEVATION (FT)	1845.27
EXISTING GRADE	---
PROPOSED GRADE	---

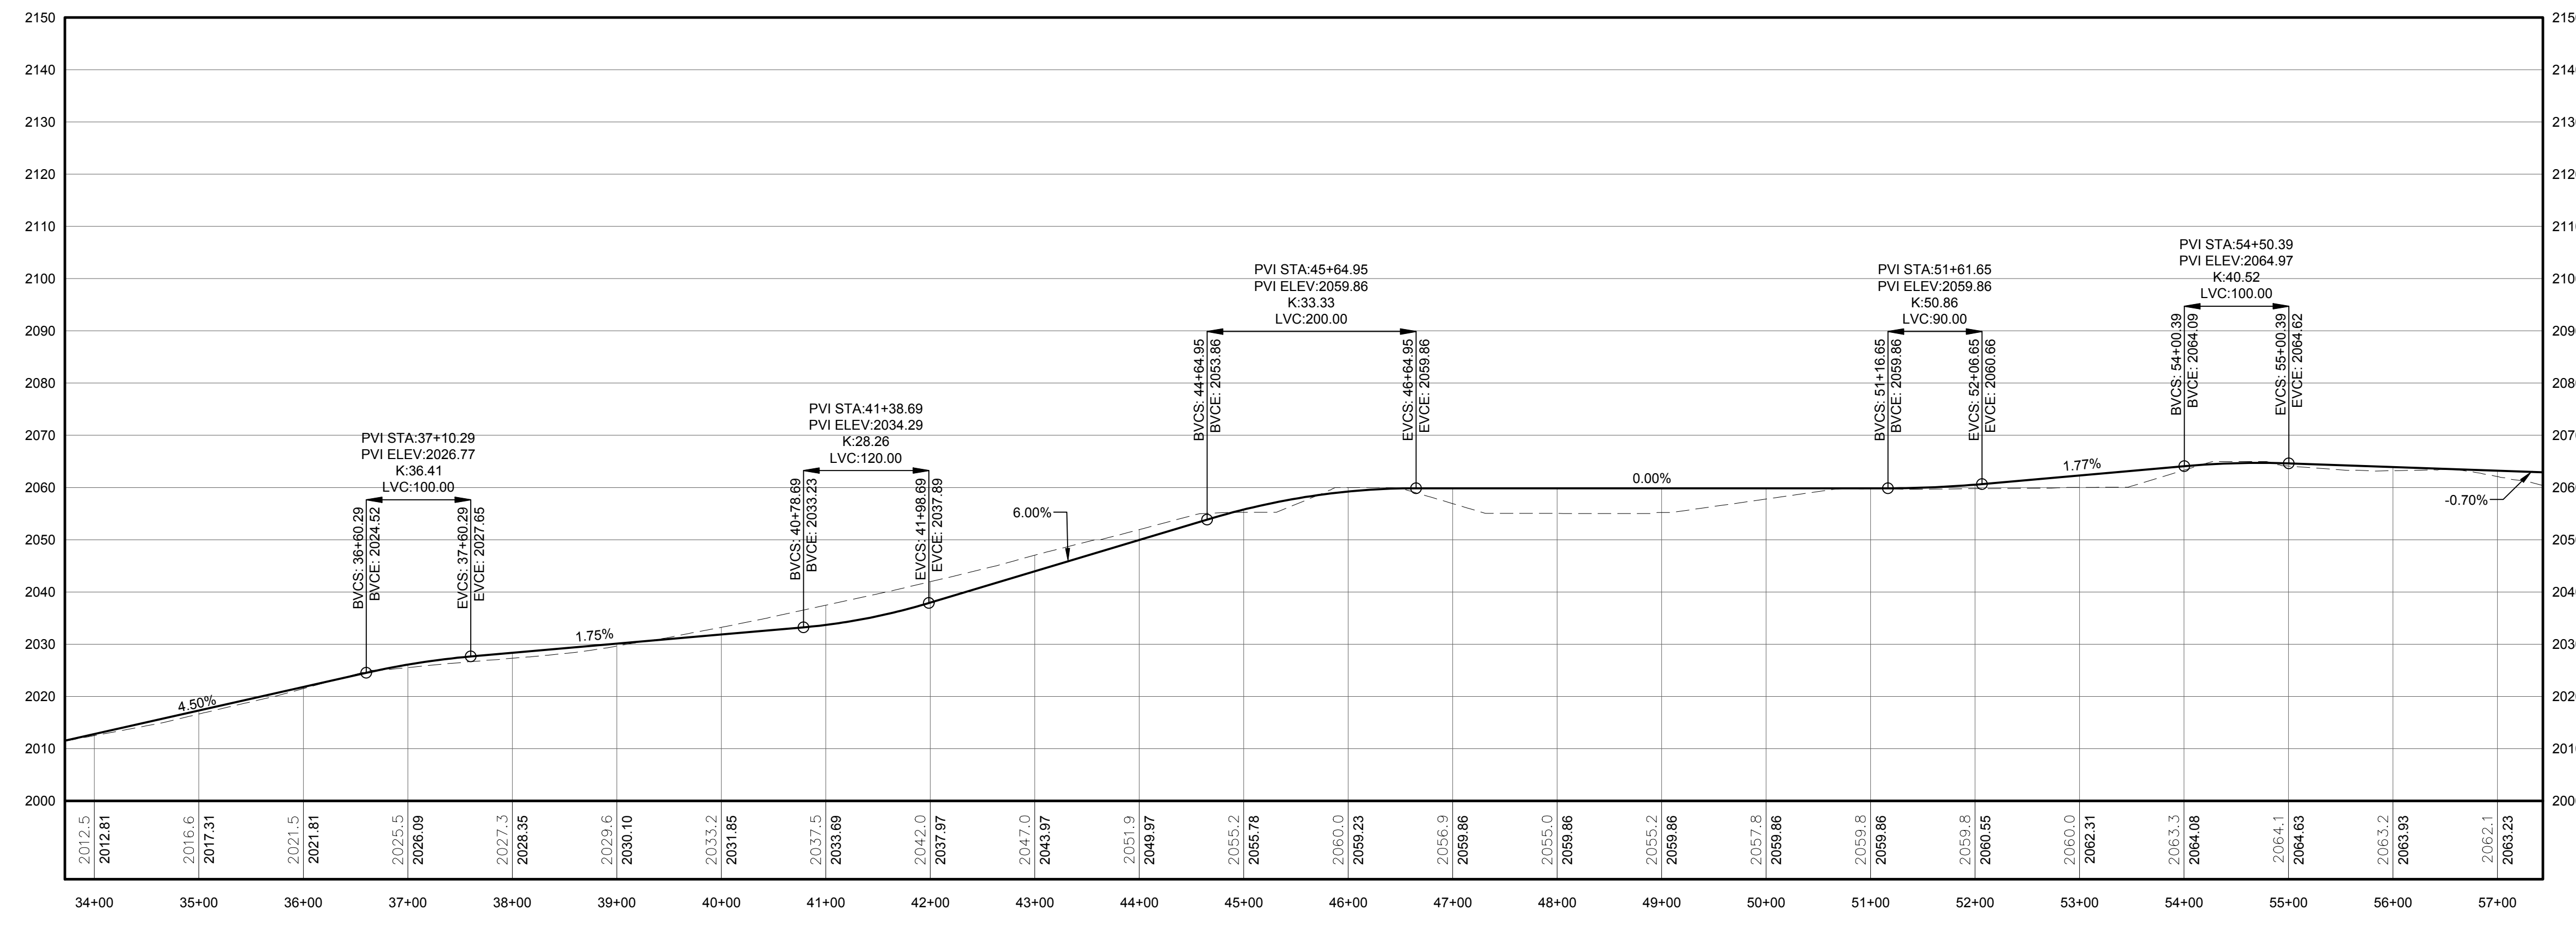NOTE: ELEVATIONS IN USGS DATUM.




2 ACCESS ROAD PROFILE
108 Scale: H:1"=100' V:1"=20'

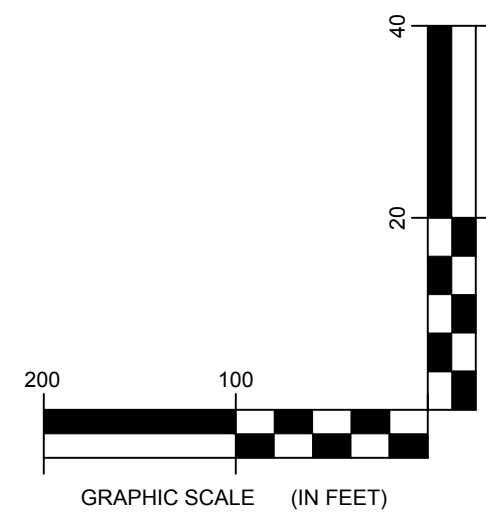108

DRAWING REVISIONS	
NO.	DATE

PROJECT TITLE:	CASSADAGA WIND PROJECT
TOWNS OF:	CHARLOTTE, CHERRY CREEK, ARKWRIGHT, AND STOCKTON
PROJECT LOCATION:	CHAUTAUGUA COUNTY, NEW YORK
CLIENT:	CASSADAGA WIND LLC
DRAWING TITLE:	ACCESS ROAD PLAN AND PROFILE

DATE:	APRIL 22, 2016
SCALE:	AS NOTED
EDR JOB#: 14048	
DRAWN BY:	AW, CB, ZR
CHECKED BY:	TD
FILE NAME:	14048_Working_SE.dwg
DRAWING NUMBER:	SE-108

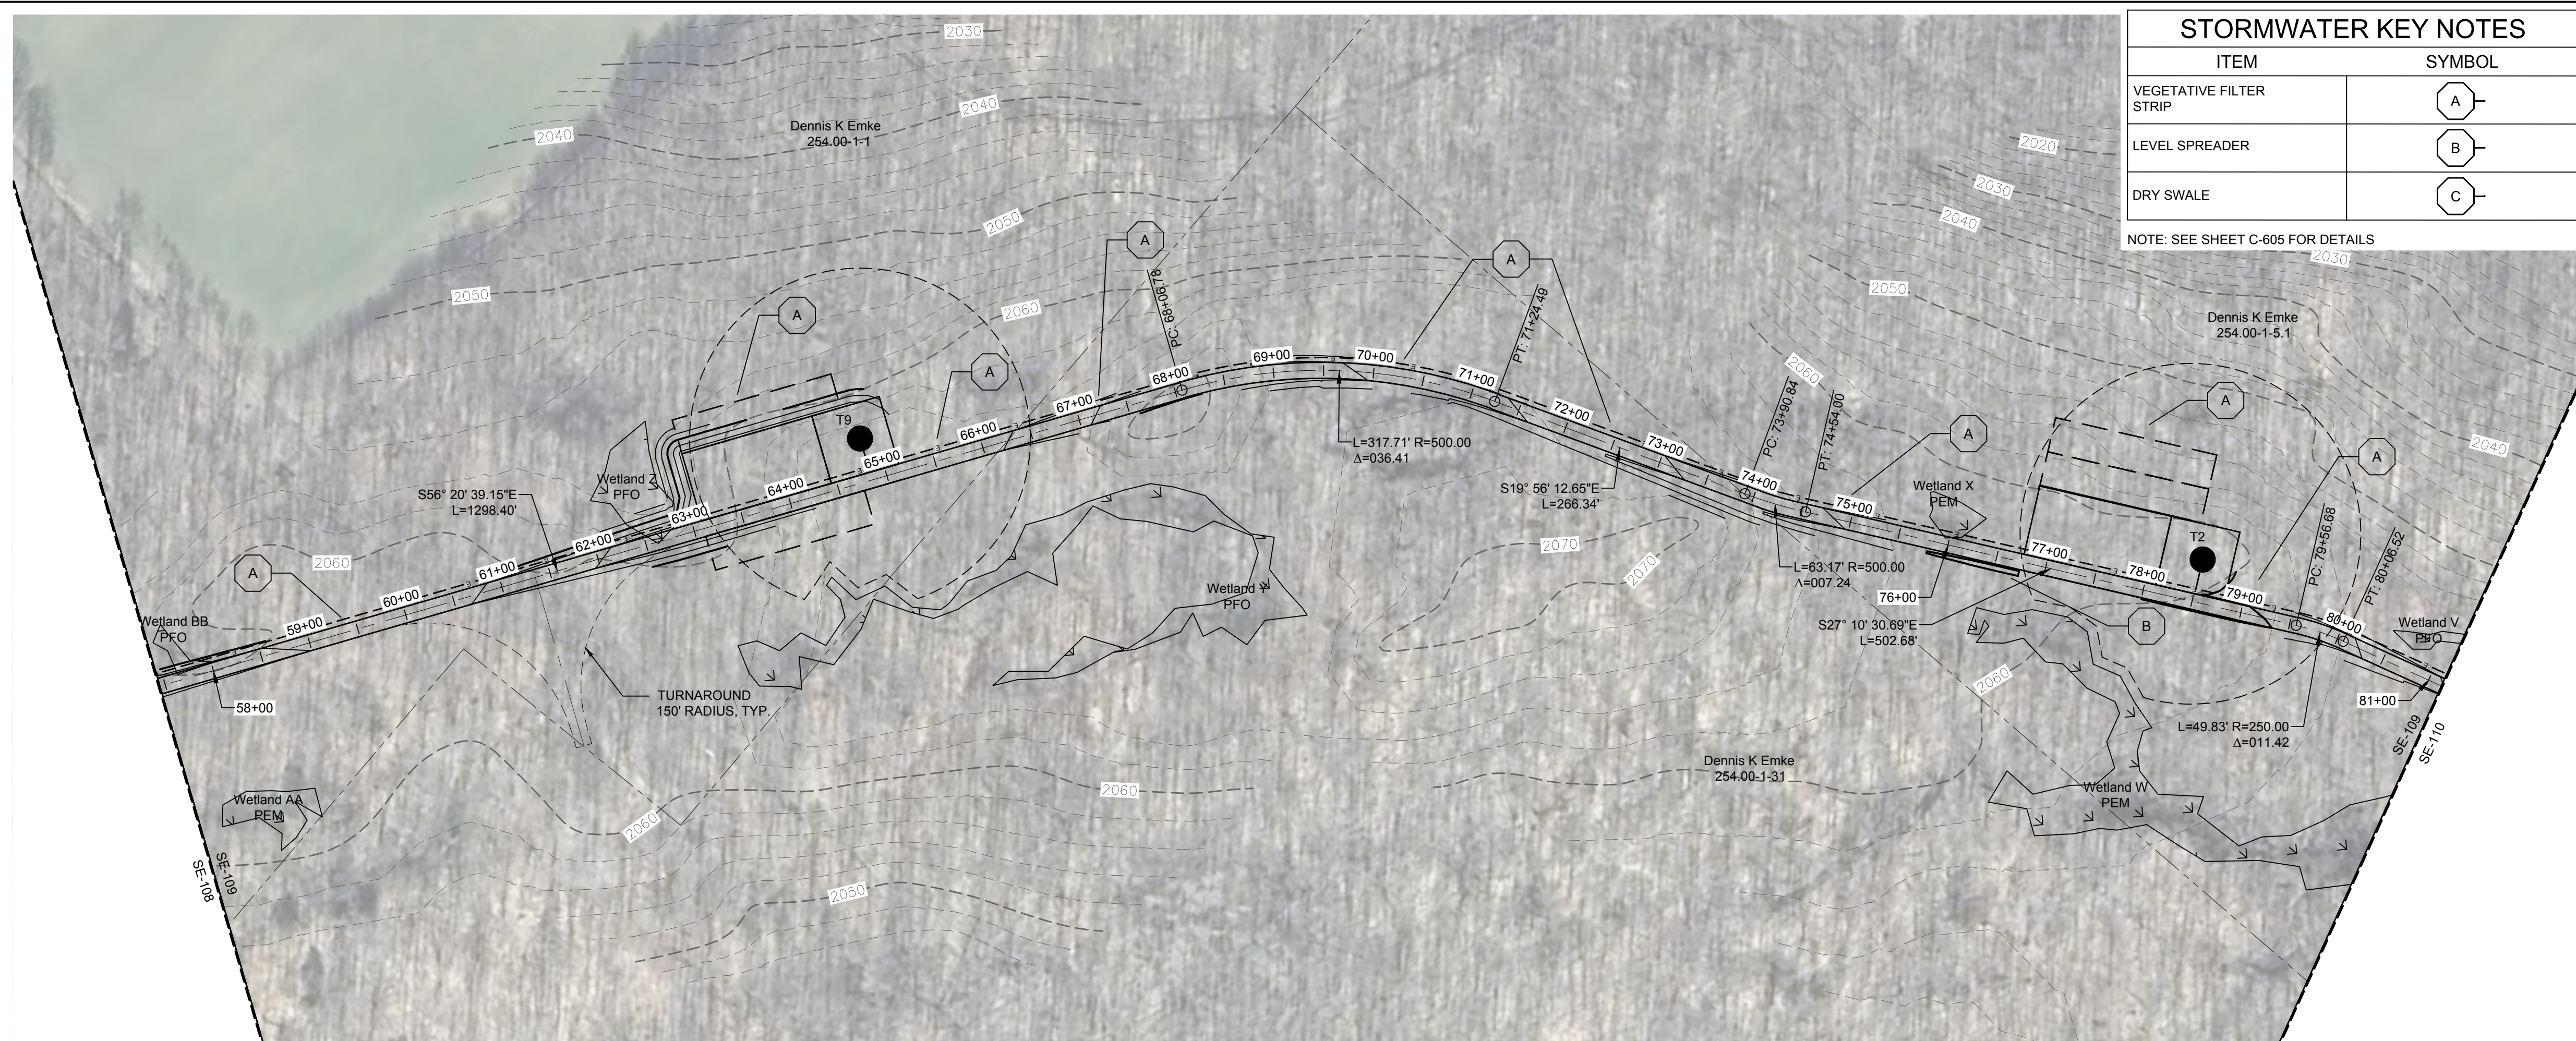

STORMWATER KEY NOTES


ITEM	SYMBOL
VEGETATIVE FILTER STRIP	(A)
LEVEL SPREADER	(B)
DRY SWALE	(C)

NOTE: SEE SHEET C-605 FOR DETAILS


LEGEND

ITEM	SYMBOL
DRAWING SHEET MATCH LINE	---
WIND TURBINE DESIGNATION	T53
PARCEL BOUNDARY	---
115 KV OVERHEAD GENERATOR LEAD LINE	---
115 KV OVERHEAD GENERATOR LEAD LINE POLE	⊙
UNDERGROUND COLLECTION LINE	---
OVERHEAD COLLECTION LINE	---
EXISTING CONTOUR (2' INTERVAL)	---
EXISTING CONTOUR - INDEX (2' INTERVAL)	---
CONTOUR - FINISHED (2' INTERVAL)	---
CONTOUR - FINISHED - INDEX (2' INTERVAL)	---
ACCESS ROAD CENTERLINE	---
PERMANENT ACCESS ROAD EDGE	---
STORM PIPE / CULVERT	---
NYSDEC WETLAND	---
WETLAND BOUNDARY	---
STREAM BOUNDARY	---
APPROXIMATE WETLAND BOUNDARY	---
APPROXIMATE STREAM BOUNDARY	---
ENVIRONMENTALLY SENSITIVE AREA - RESTRICTED ACCESS	---
ENVIRONMENTALLY SENSITIVE AREA	---
WIND TURBINE CONSTRUCTION SITE	---
ROTOR LAYDOWN	---
WIND TURBINE	---
GRAVEL PAD	---
WORK AREA	---
CRANE PAD	---

1 PLAN VIEW - SPUR T37 - T1 ACCESS ROAD TO TURBINES 37, 12, 27, 9, 2, AND 1
 109 Scale: 1"=100'

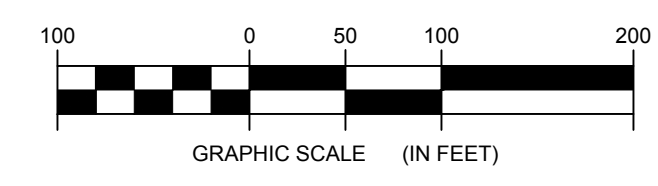


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PROFILE LEGEND

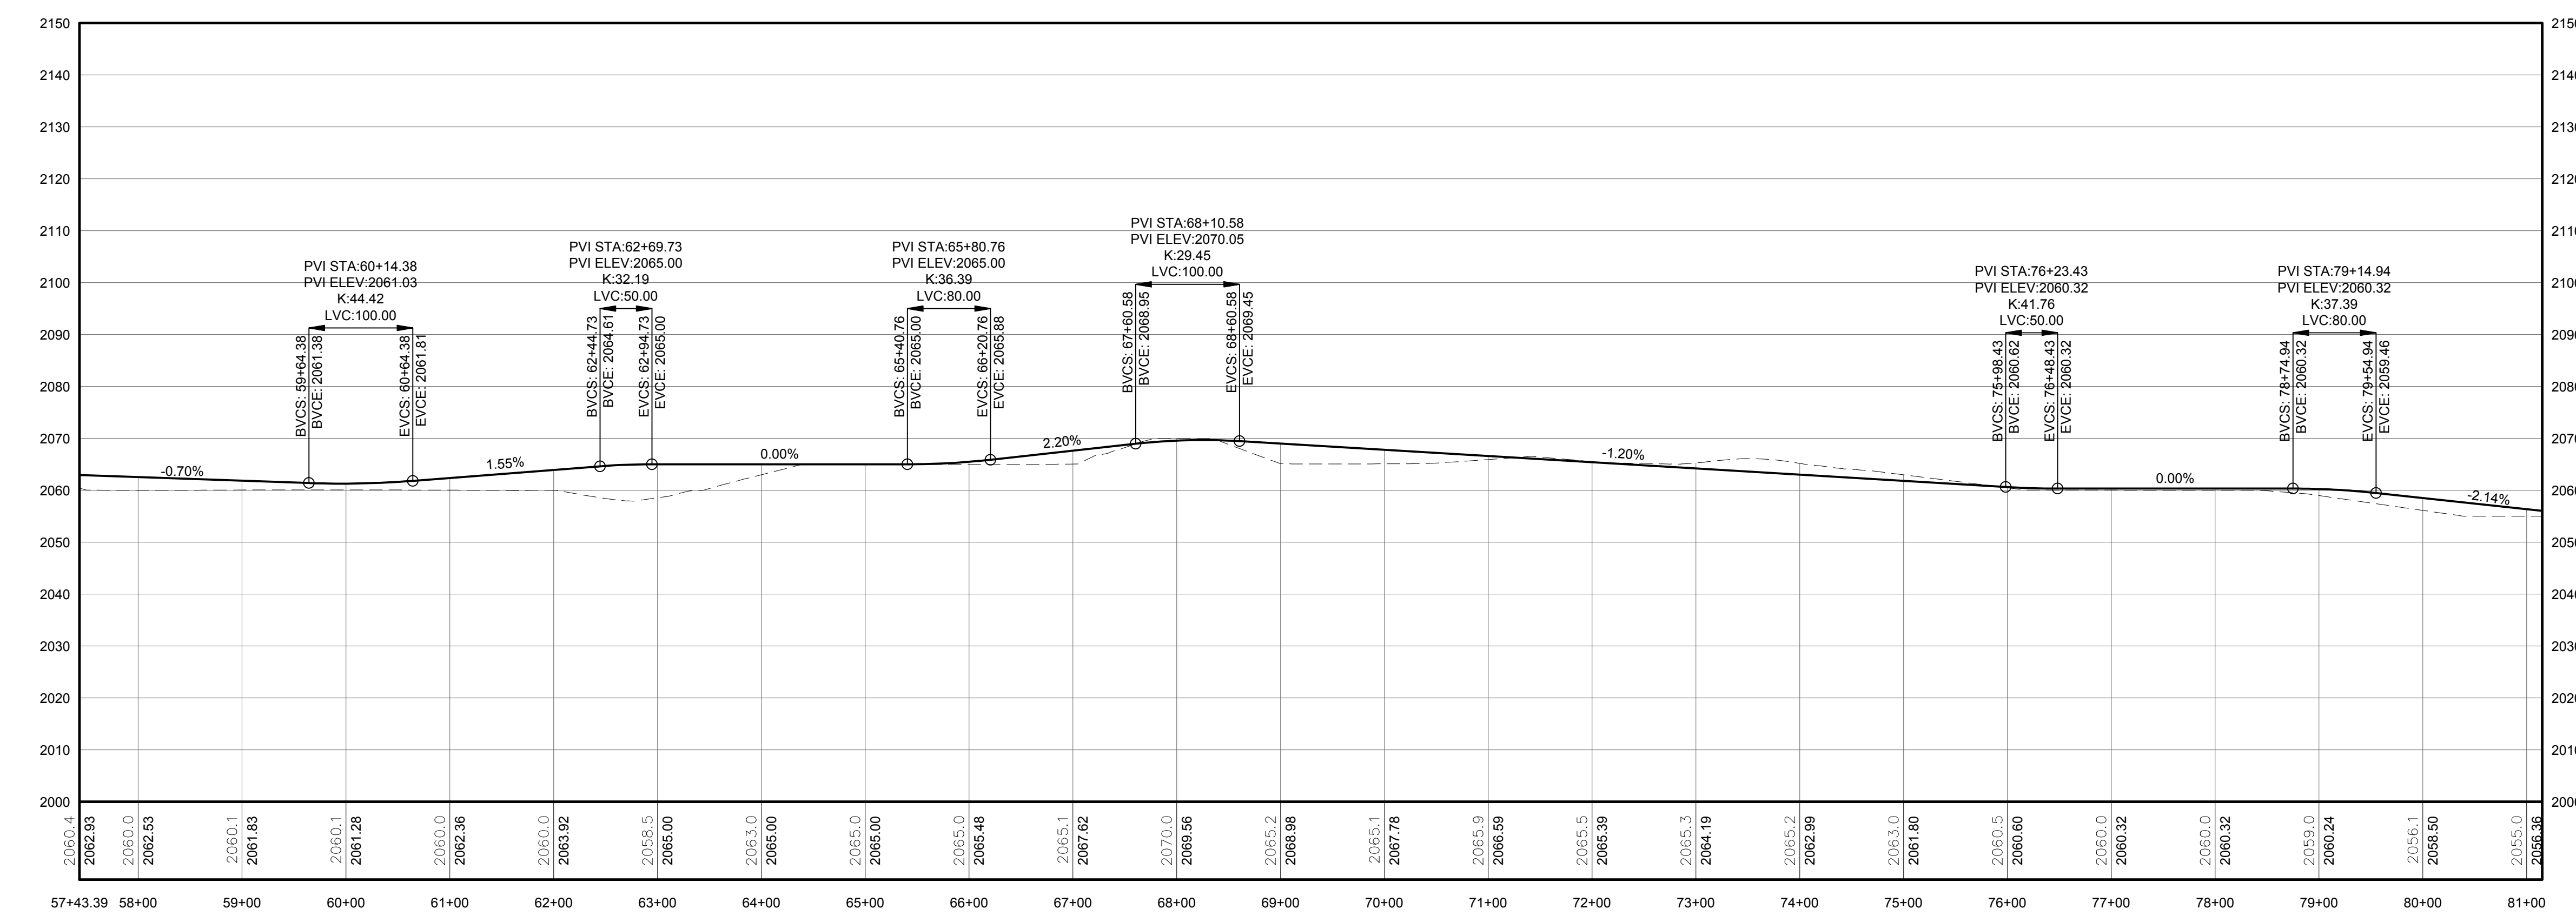ITEM	SYMBOL
EXISTING ELEVATION (FT)	1845.3
PROPOSED ELEVATION (FT)	1845.27
EXISTING GRADE	---
PROPOSED GRADE	---

NOTE: ELEVATIONS IN USGS DATUM.



2 ACCESS ROAD PROFILE
 109 Scale: H:1"=100' V:1"=20'

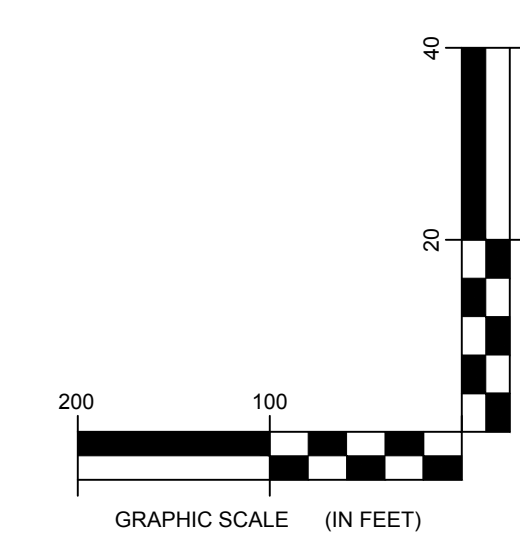


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NO.	DATE	REVISION

PROJECT TITLE	DATE
CASSADAGA WIND PROJECT	APRIL 22, 2016

PROJECT TITLE: CASSADAGA WIND PROJECT
TOWNS OF CHARLOTTE, CHERRY CREEK, ARKWRIGHT, AND STOCKTON
PROJECT LOCATION: CHAUTAUGUS COUNTY, NEW YORK
CLIENT: CASSADAGA WIND LLC
DRAWING TITLE: ACCESS ROAD PLAN AND PROFILE


DATE: APRIL 22, 2016
SCALE: AS NOTED
JOB NO: 14048
DRAWN BY: AW, CB, ZR
CHECKED BY: TD
FILE NAME: 14048_Working_SE.dwg
DRAWING NUMBER: SE-109

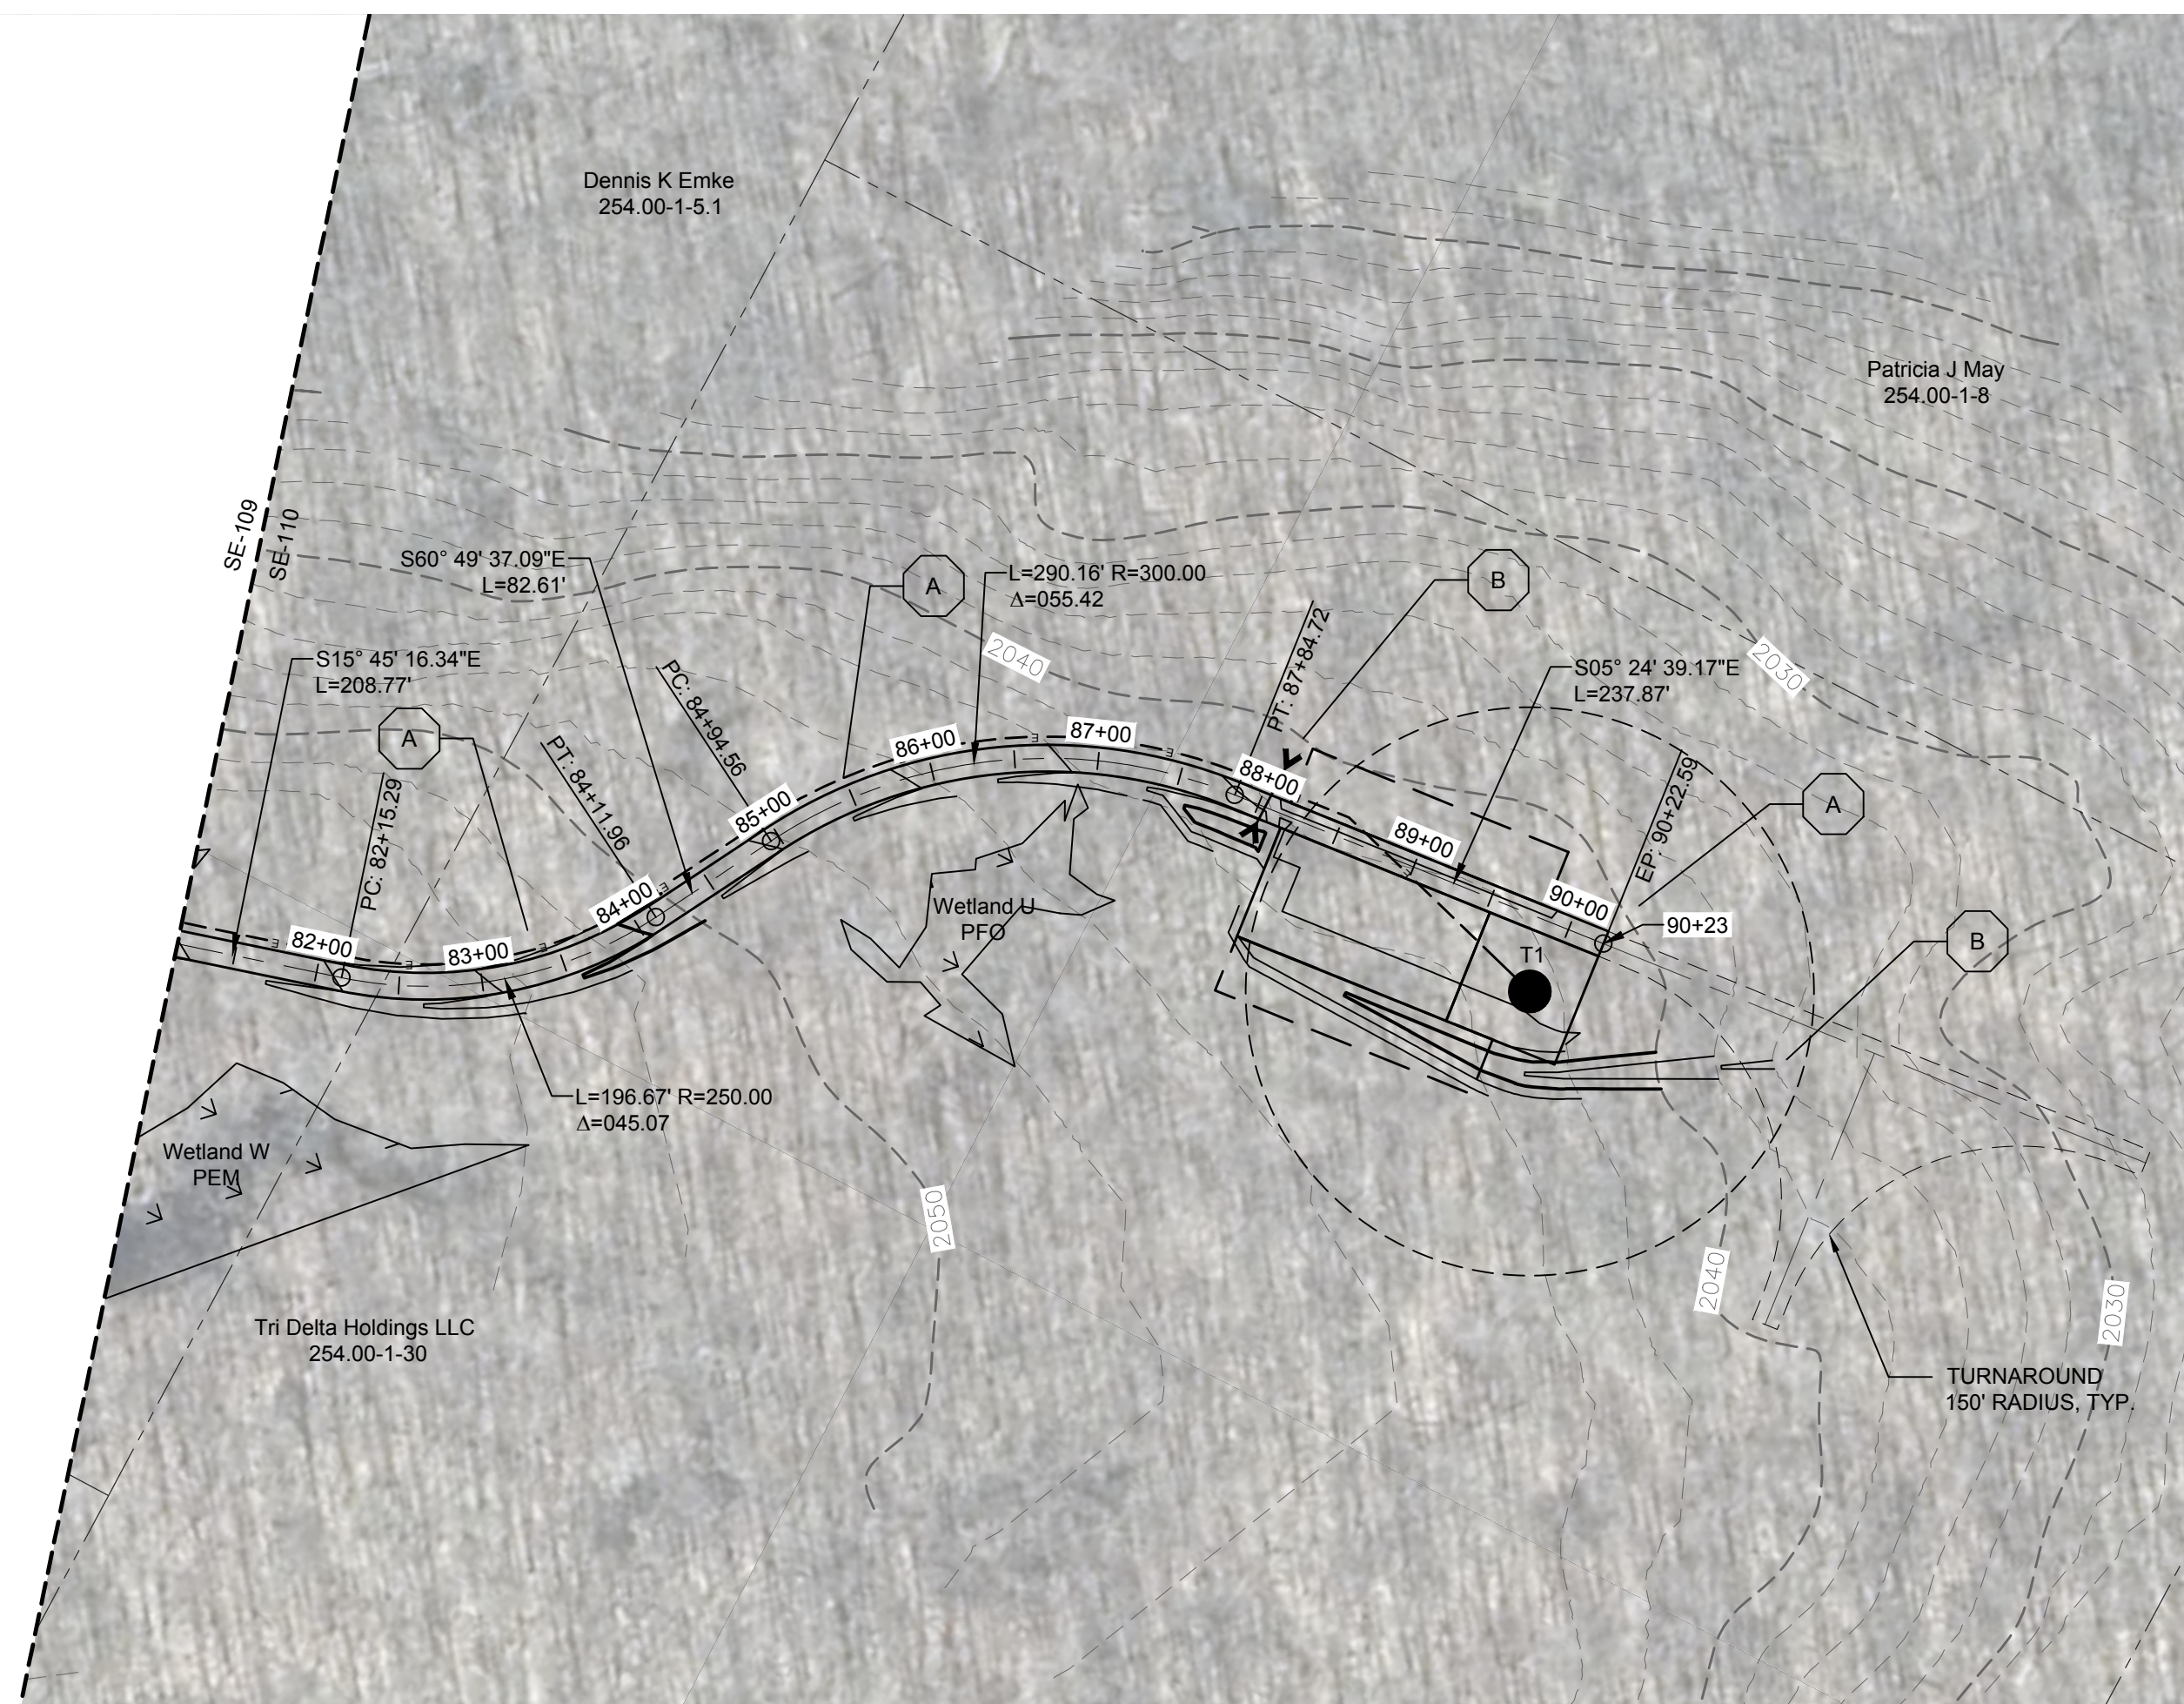

STORMWATER KEY NOTES	
ITEM	SYMBOL
VEGETATIVE FILTER STRIP	(A)
LEVEL SPREADER	(B)
DRY SWALE	(C)

NOTE: SEE SHEET C-605 FOR DETAILS

LEGEND	
ITEM	SYMBOL
DRAWING SHEET MATCH LINE	--- DRAWING NUMBER --- DRAWING NUMBER
WIND TURBINE DESIGNATION	T53
PARCEL BOUNDARY	---
115 KV OVERHEAD GENERATOR LEAD LINE	--- 115KV ---
115 KV OVERHEAD GENERATOR LEAD LINE POLE	⊥
UNDERGROUND COLLECTION LINE	---
OVERHEAD COLLECTION LINE	---
EXISTING CONTOUR (2' INTERVAL)	---
EXISTING CONTOUR - INDEX (2' INTERVAL)	---
CONTOUR - FINISHED (2' INTERVAL)	---
CONTOUR - FINISHED - INDEX (2' INTERVAL)	---
ACCESS ROAD CENTERLINE	---
PERMANENT ACCESS ROAD EDGE	---
STORM PIPE / CULVERT	---
NYSDEC WETLAND	---
WETLAND BOUNDARY	---
STREAM BOUNDARY	---
APPROXIMATE WETLAND BOUNDARY	---
APPROXIMATE STREAM BOUNDARY	---
ENVIRONMENTALLY SENSITIVE AREA - RESTRICTED ACCESS	---
ENVIRONMENTALLY SENSITIVE AREA	---
WIND TURBINE CONSTRUCTION SITE	---
ROTOR LAYDOWN	---
WIND TURBINE	---
GRAVEL PAD	---
WORK AREA	---
CRANE PAD	---


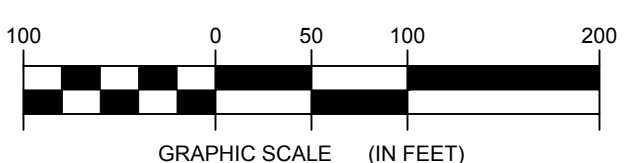


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PROFILE LEGEND	
ITEM	SYMBOL
EXISTING ELEVATION (FT)	1845.3
PROPOSED ELEVATION (FT)	1845.27
EXISTING GRADE	---
PROPOSED GRADE	---


NOTE: ELEVATIONS IN USGS DATUM.

1 PLAN VIEW - SPUR T37 - T1 ACCESS ROAD TO TURBINES 37, 12, 27, 9, 2, AND 1
Scale: 1"=100'

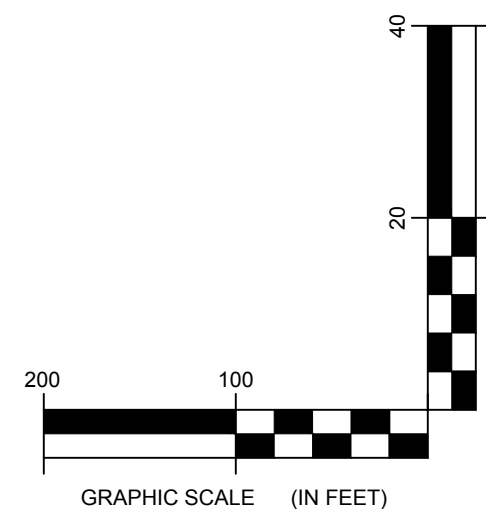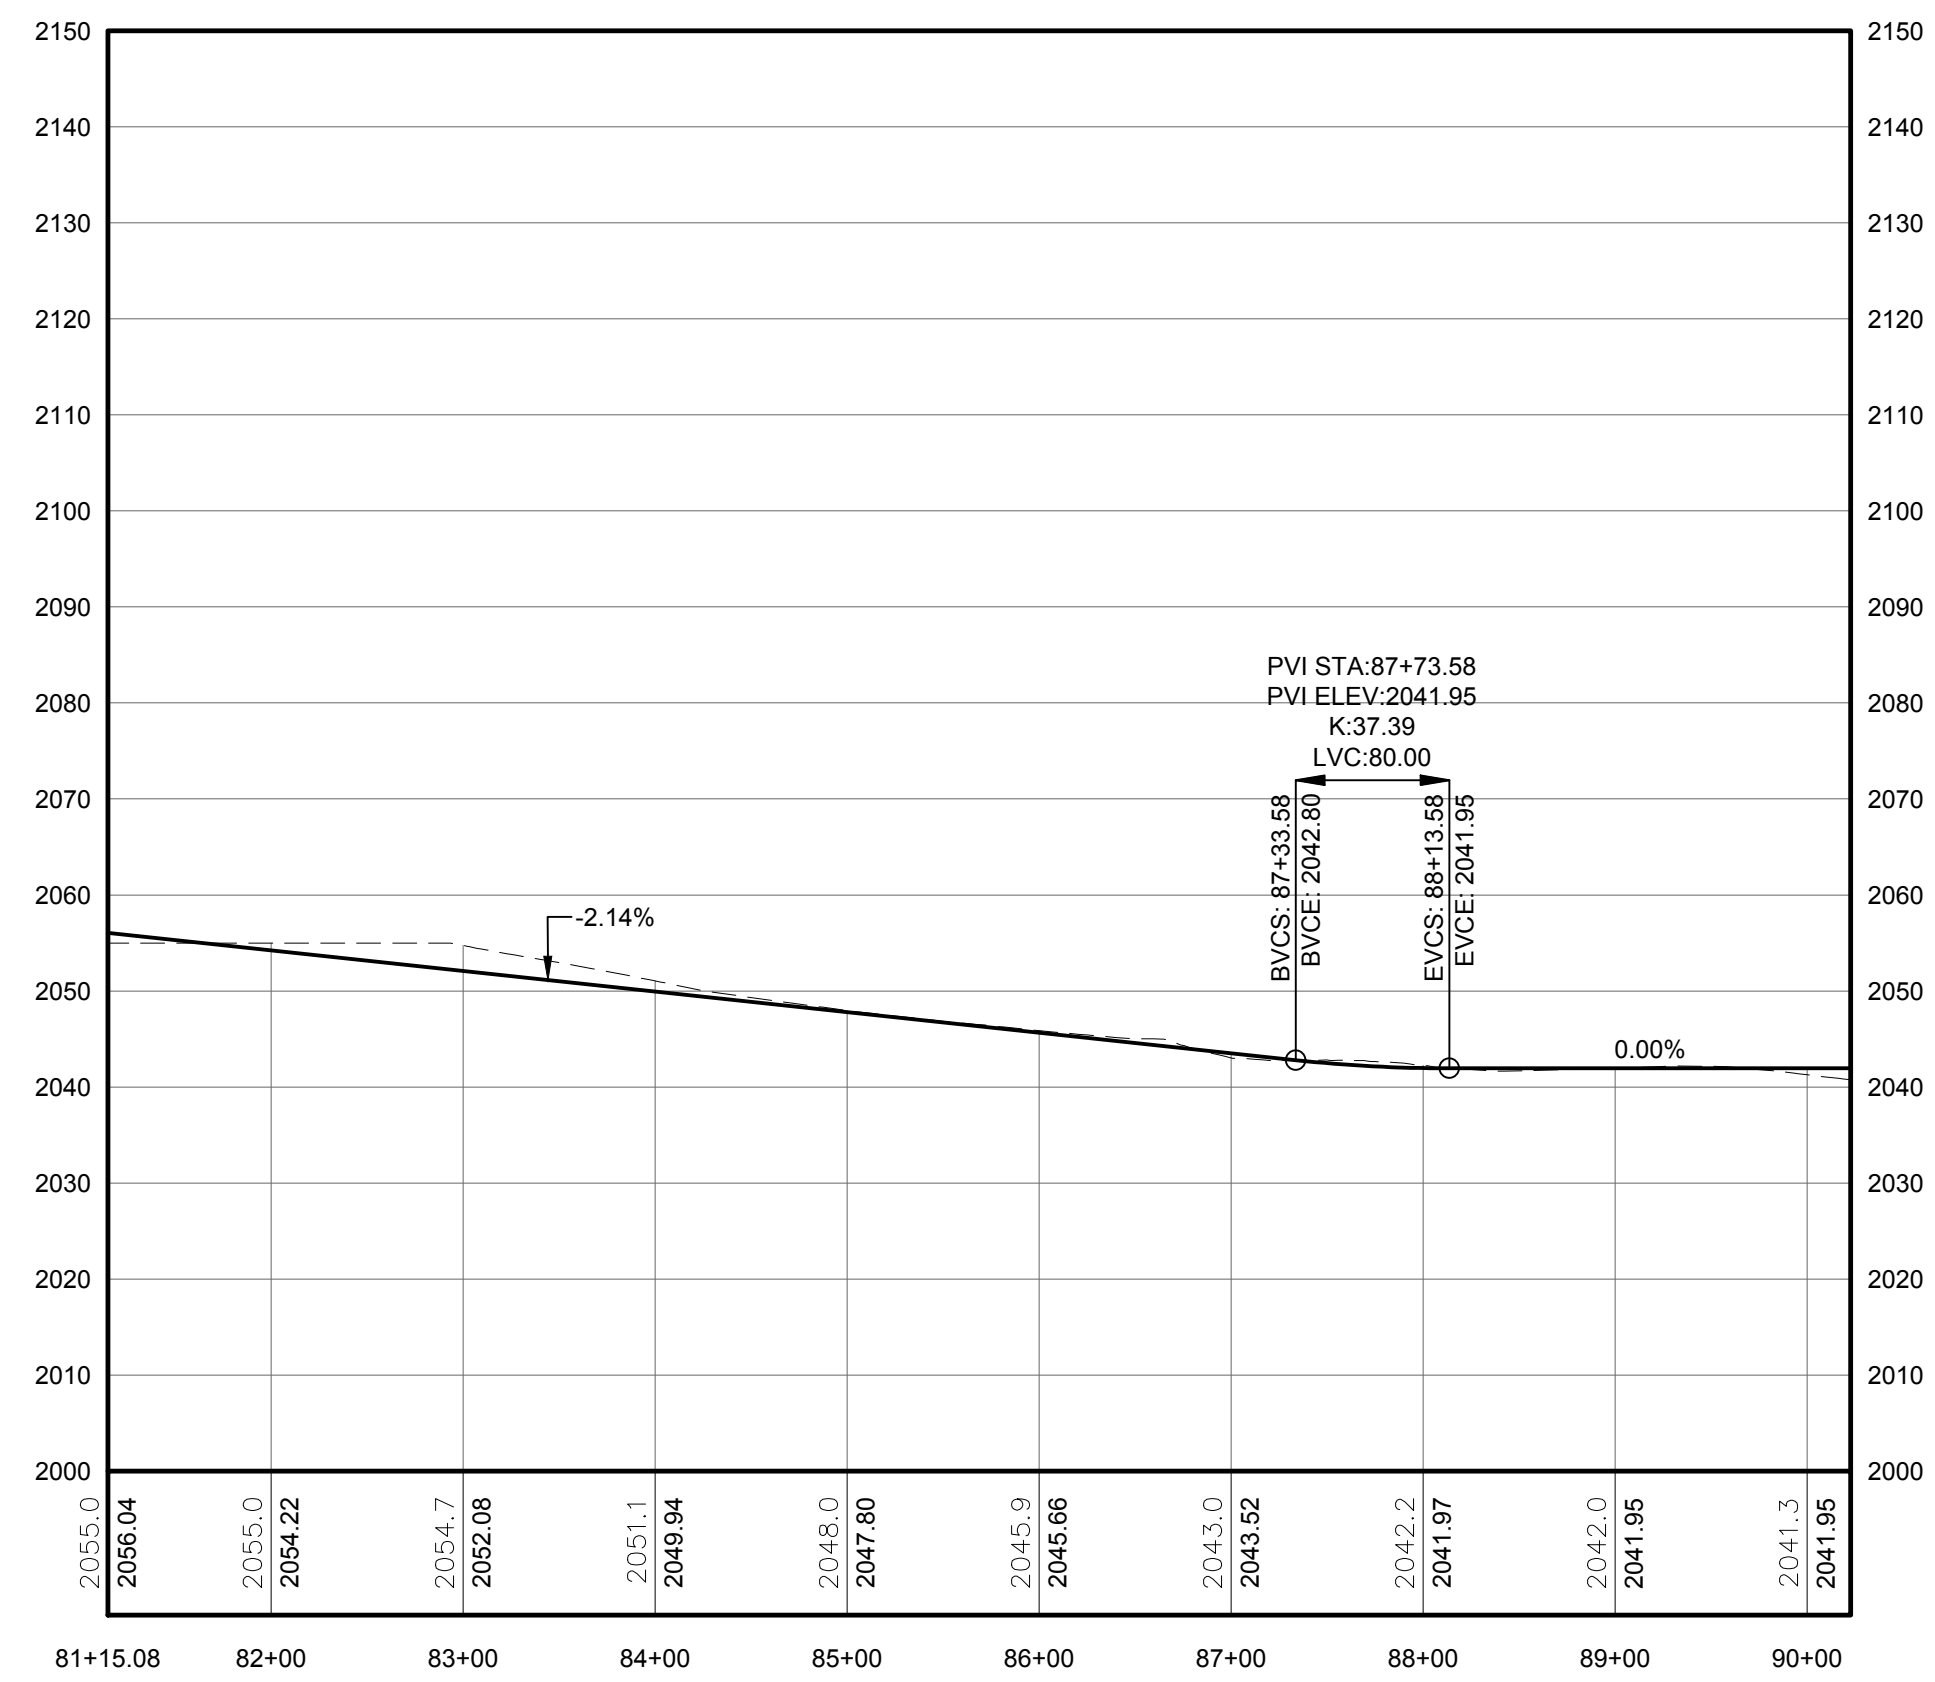

2 ACCESS ROAD PROFILE
Scale: H:1"=100' V:1"=20'

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NO.	DATE

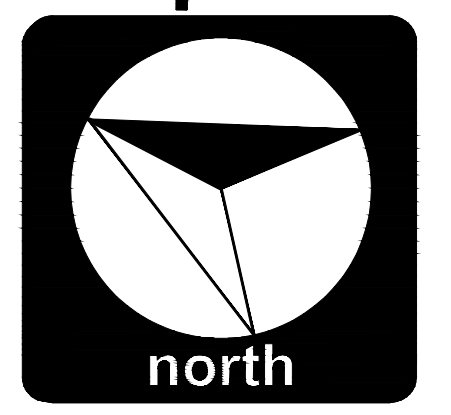PROJECT TITLE: **CASSADAGA WIND PROJECT**
TOWNS OF CHARLOTTE, CHERRY CREEK, ARKWRIGHT, AND STOCKTON
PROJECT LOCATION: CHAUTAQUA COUNTY, NEW YORK
CLIENT: CASSADAGA WIND LLC
DRAWING TITLE: **ACCESS ROAD PLAN AND PROFILE**


DATE:	APRIL 22, 2016
SCALE:	AS NOTED
JOB NO.:	14048
DRAWN BY:	AW, CB, ZR
CHECKED BY:	TD
FILE NAME:	14048_Working_SE.dwg
DRAWING NUMBER:	SE-110



1 PLAN VIEW - LAYDOWN AREA
101 Scale: 1"=100'

LEGEND	
ITEM	SYMBOL
DRAWING SHEET MATCH LINE	--- DRAWING NUMBER --- DRAWING NUMBER
WIND TURBINE DESIGNATION	T53
PARCEL BOUNDARY	---
115 KV OVERHEAD GENERATOR LEAD LINE	— 115KV —
115 KV OVERHEAD GENERATOR LEAD LINE POLE	⊥
UNDERGROUND COLLECTION LINE	---
OVERHEAD COLLECTION LINE	—
EXISTING CONTOUR (2' INTERVAL)	--- (490) ---
EXISTING CONTOUR - INDEX (2' INTERVAL)	--- (490) ---
CONTOUR - FINISHED (2' INTERVAL)	--- (498) ---
CONTOUR - FINISHED - INDEX (2' INTERVAL)	--- (490) ---
ACCESS ROAD CENTERLINE	---
PERMANENT ACCESS ROAD EDGE	---
STORM PIPE / CULVERT	--->---
NYSDEC WETLAND	▨
WETLAND BOUNDARY	▾
STREAM BOUNDARY	▬
APPROXIMATE WETLAND BOUNDARY	▾
APPROXIMATE STREAM BOUNDARY	▬
ENVIRONMENTALLY SENSITIVE AREA - RESTRICTED ACCESS	▨
ENVIRONMENTALLY SENSITIVE AREA	▨
WIND TURBINE CONSTRUCTION SITE	○
ROTOR LAYDOWN	○
WIND TURBINE	●
GRAVEL PAD	▭
WORK AREA	▭
CRANE PAD	▭

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PROJECT TITLE: CASSADAGA WIND PROJECT
TOWNS OF CHARLOTTE, CHERRY CREEK, ARKWRIGHT, AND STOCKTON
PROJECT LOCATION: CHAUTAUGUA COUNTY, NEW YORK
CLIENT: CASSADAGA WIND LLC
DRAWING TITLE: LAYDOWN AREA PLAN

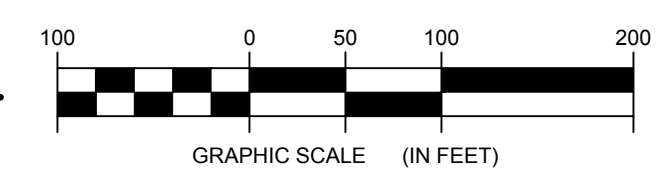DATE: APRIL 22, 2016
SCALE: AS NOTED
EDR JOB#: 14048
DRAWN BY: AW, CB, ZR
CHECKED BY: TD
FILE NAME: 14048_Working_SE.dwg
DRAWING NUMBER: SE-111

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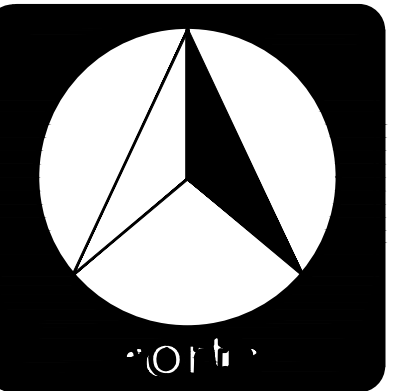
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NOTE: ENTIRE SOUTHEAST REGION IS LOCATED WITHIN THE TOWN OF CHERRY CREEK



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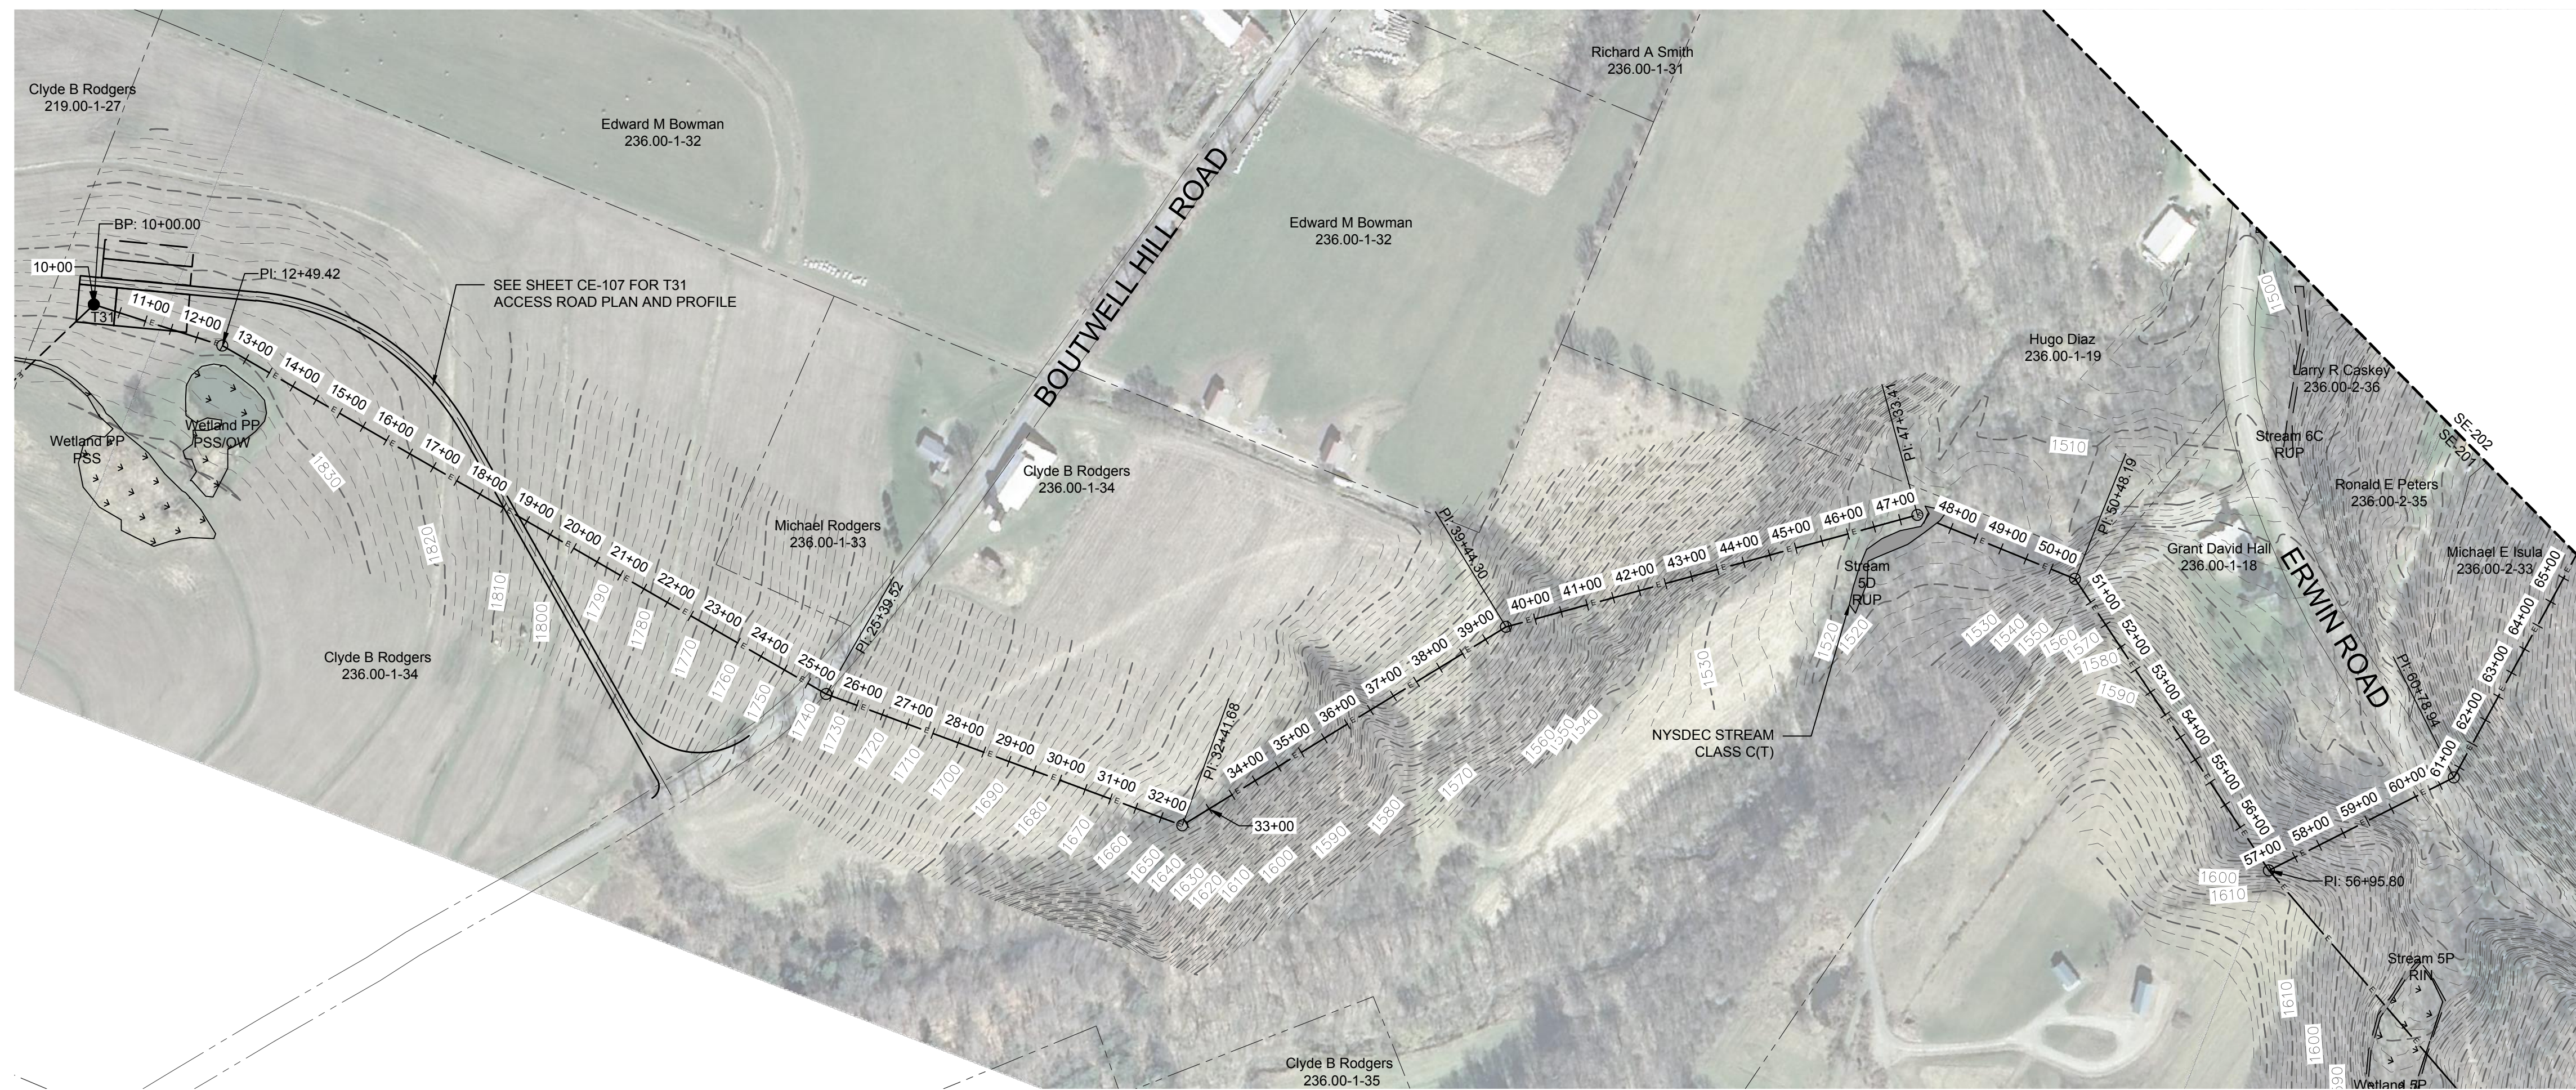


NO.	DATE	REVISION

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PROJECT TITLE: CASSADAGA WIND PROJECT
TOWNS OF CHARLOTTE, CHERRY CREEK, ARKWRIGHT, AND STOCKTON
PROJECT LOCATION: CHAUTAQUA COUNTY, NEW YORK
CLIENT: CASSADAGA WIND LLC
DRAWING TITLE: COLLECTION LINE PLAN AND PROFILE INDEX SHEET



DATE: APRIL 22, 2016
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EDR JOB#: 14048
DRAWN BY: AW, CB, ZR
CHECKED BY: TD
FILE NAME: 14048_Working_SE.dwg
DRAWING NUMBER: SE-200



LEGEND	
ITEM	SYMBOL
DRAWING SHEET MATCH LINE	---
WIND TURBINE DESIGNATION	T53
PARCEL BOUNDARY	---
115 kV OVERHEAD GENERATOR LEAD LINE	---
115 kV OVERHEAD GENERATOR LEAD LINE POLE	⊙
UNDERGROUND COLLECTION LINE	---
OVERHEAD COLLECTION LINE	---
EXISTING CONTOUR (2' INTERVAL)	---
EXISTING CONTOUR - INDEX (2' INTERVAL)	---
PERMANENT ACCESS ROAD EDGE	---
PERMANENT ACCESS ROAD CENTERLINE	---
STORM PIPE / CULVERT	---
NYSDEC WETLAND	---
WETLAND BOUNDARY	---
STREAM BOUNDARY	---
APPROXIMATE WETLAND BOUNDARY	---
APPROXIMATE STREAM BOUNDARY	---
ENVIRONMENTALLY SENSITIVE AREA - RESTRICTED ACCESS	---
ENVIRONMENTALLY SENSITIVE AREA	---
WIND TURBINE CONSTRUCTION SITE	---
ROTOR LAYDOWN	---
WIND TURBINE	---
GRAVEL PAD	---
WORK AREA	---
CRANE PAD	---




1 COLLECTION LINE PLAN VIEW - PREFERRED ROUTE FROM T31 TO T12
201 Scale: 1"=200'

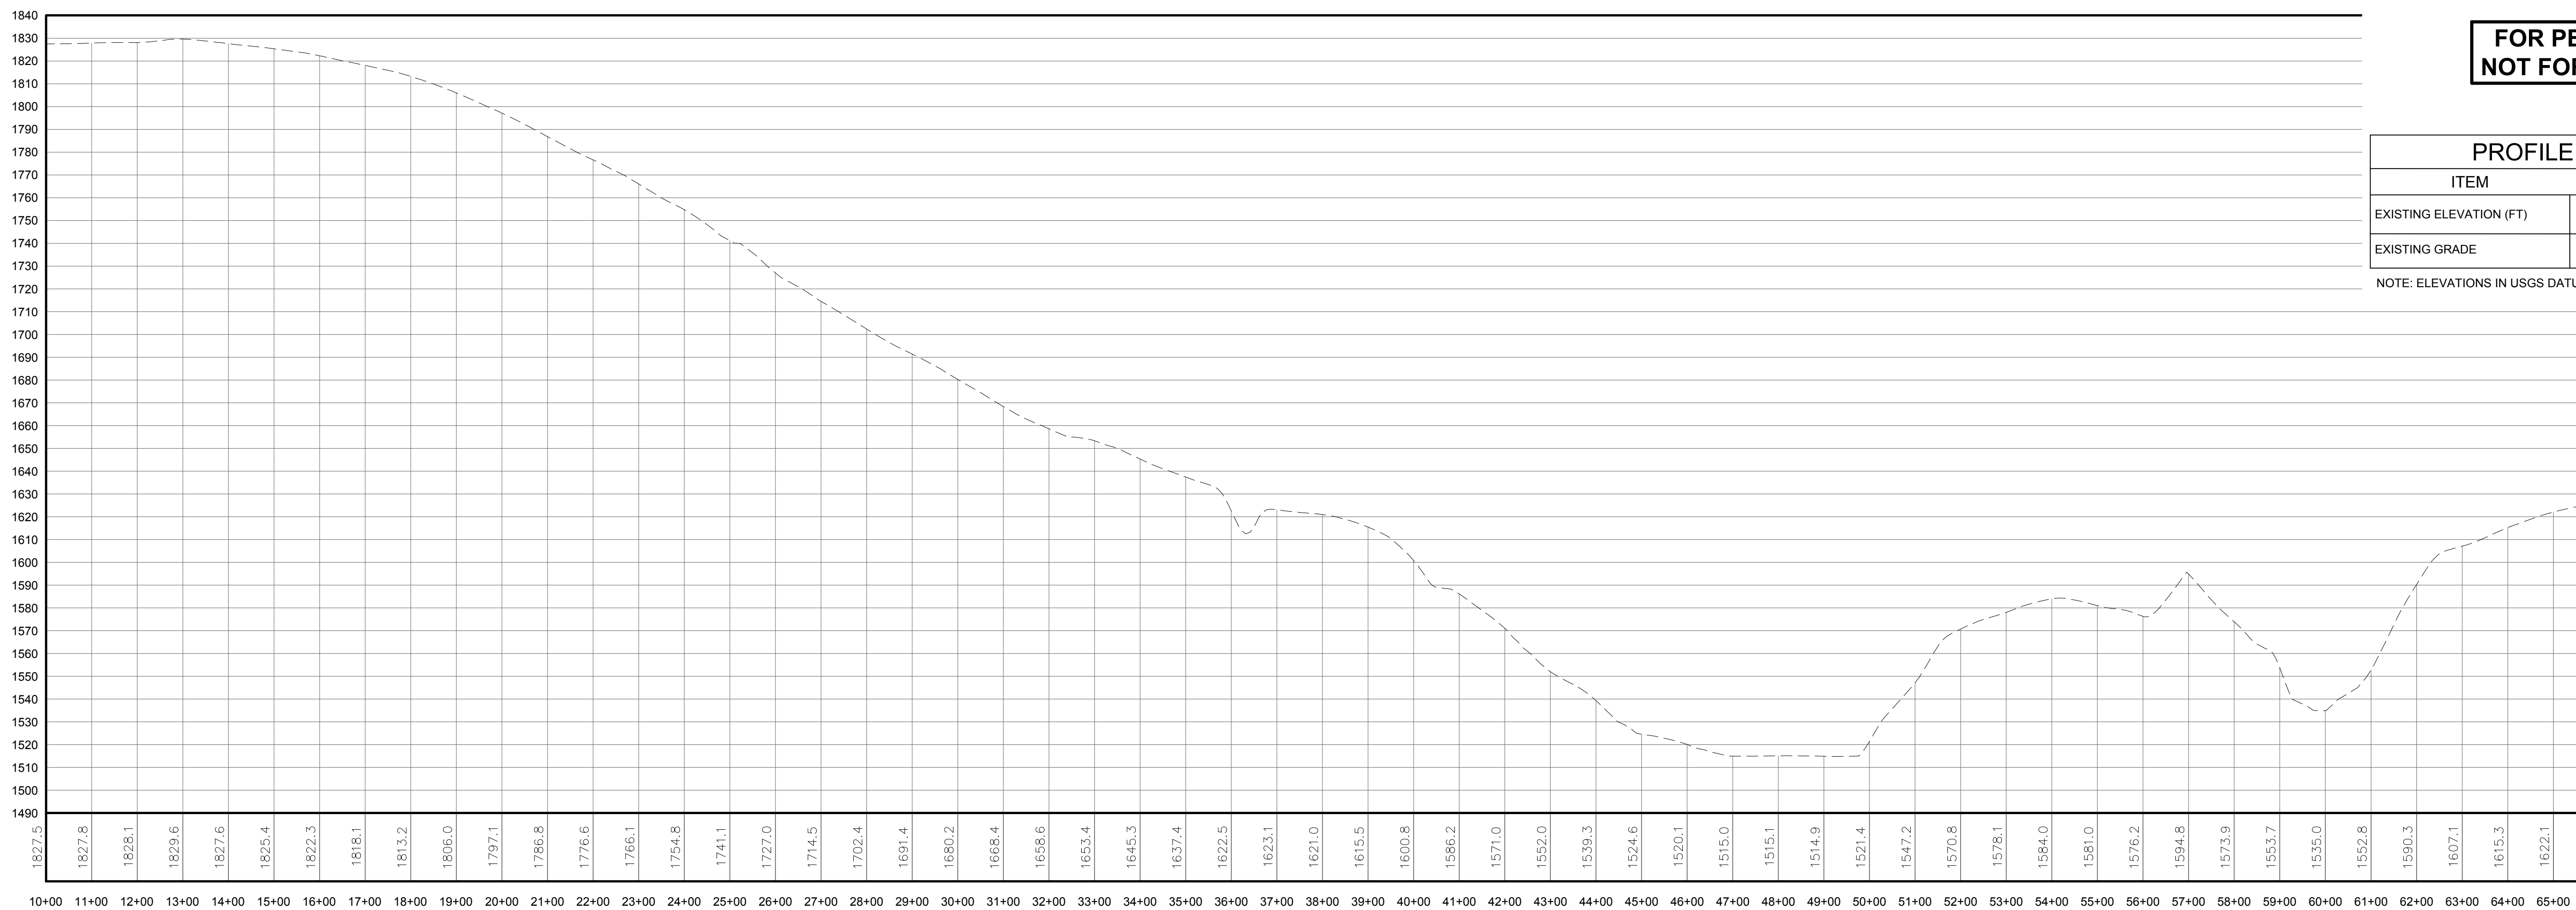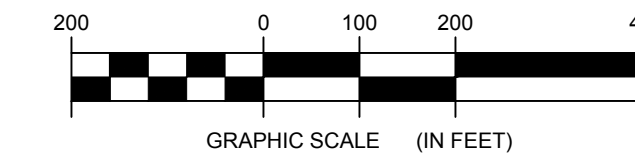

PROFILE LEGEND	
ITEM	SYMBOL
EXISTING ELEVATION (FT)	1845.3
EXISTING GRADE	---

NOTE: ELEVATIONS IN USGS DATUM.

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2 COLLECTION LINE PROFILE
201 Scale: H:1"=200' V:1"=40'

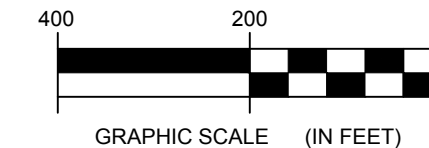
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DRAWING REVISIONS	
NO.	DATE



PROJECT TITLE: **CASSADAGA WIND PROJECT**
 TOWNS OF CHARLOTTE, CHERRY CREEK, ARKWRIGHT, AND STOCKTON
 PROJECT LOCATION: CHAUTAUGUS COUNTY, NEW YORK
 CLIENT: CASSADAGA WIND LLC
 DRAWING TITLE: COLLECTION LINE PLAN AND PROFILE

DATE: APRIL 22, 2016
 SCALE: AS NOTED
 JOB NO: 14048
 DRAWN BY: AW, CB, ZR
 CHECKED BY: TD
 FILE NAME: 14048_Working_SE.dwg
 DRAWING NUMBER: **SE-201**


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1 COLLECTION LINE PLAN VIEW - PREFERRED ROUTE FROM T31 TO T12
202 Scale: 1"=200'

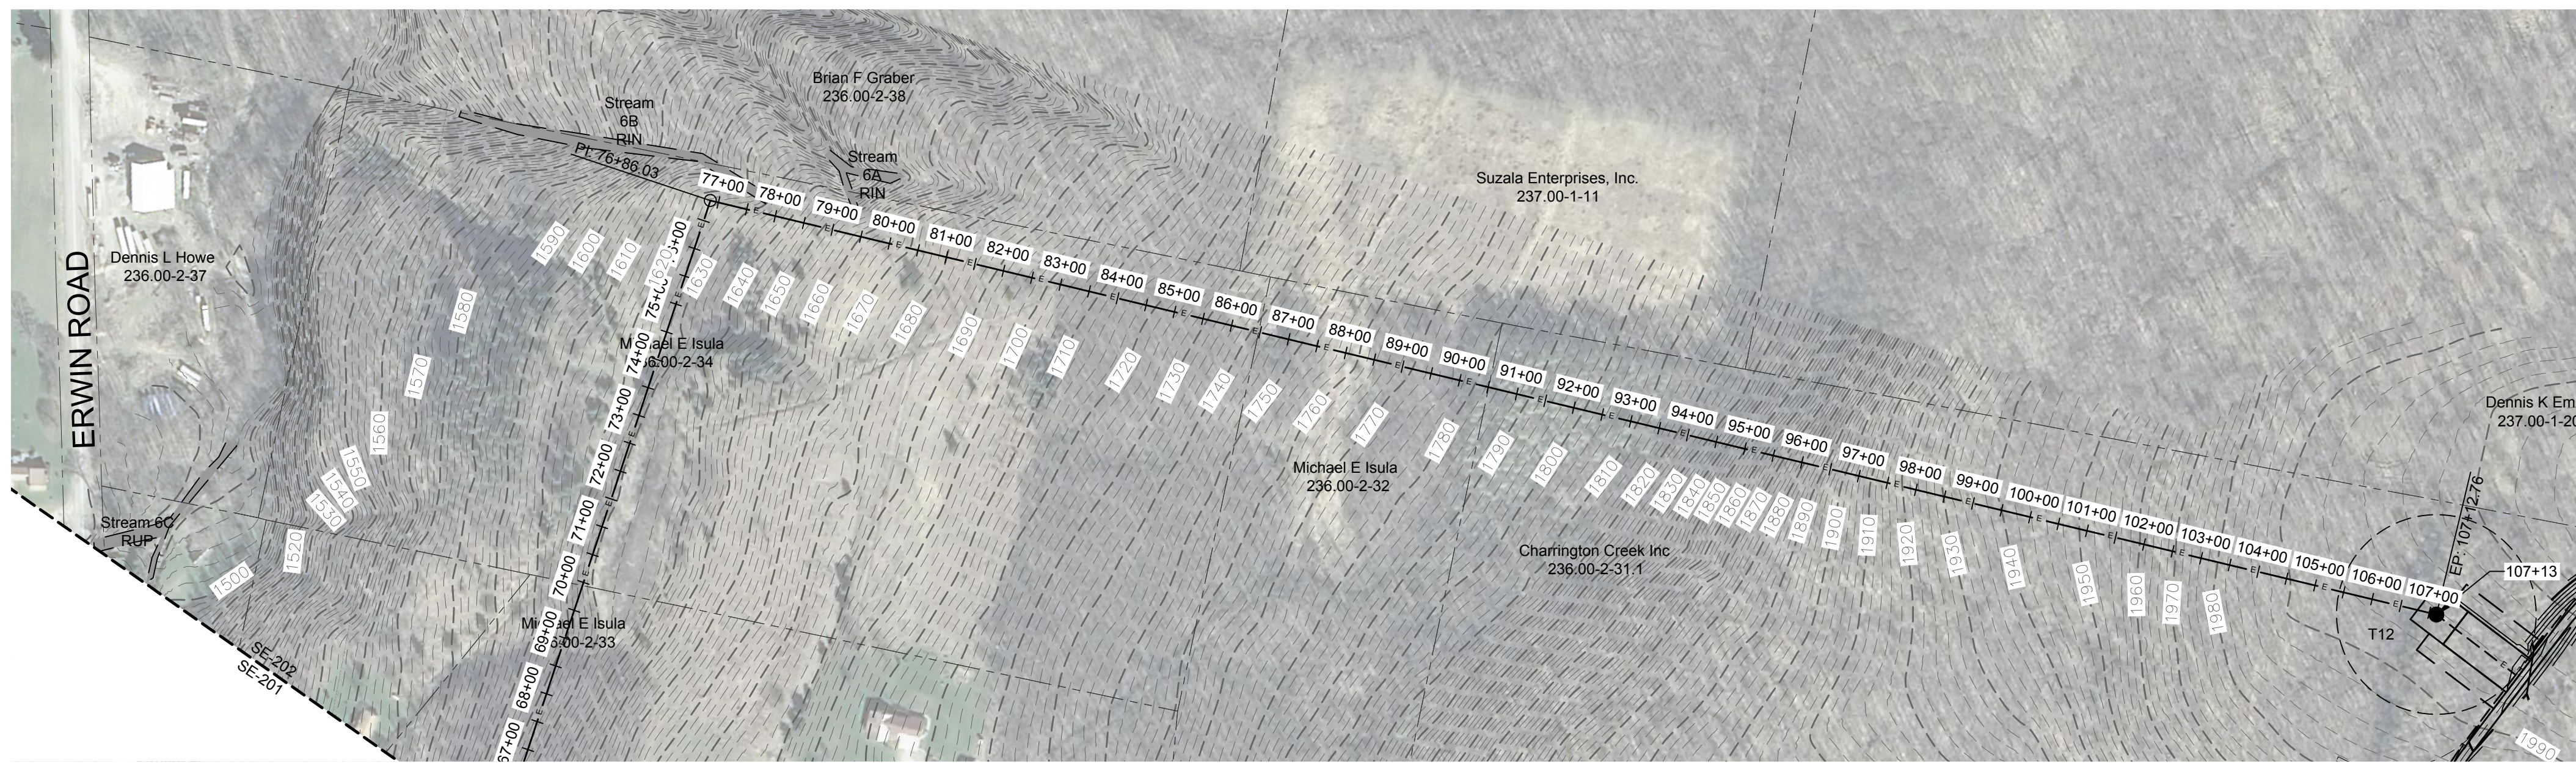

2 COLLECTION LINE PROFILE
202 Scale: H:1"=200' V:1"=40'

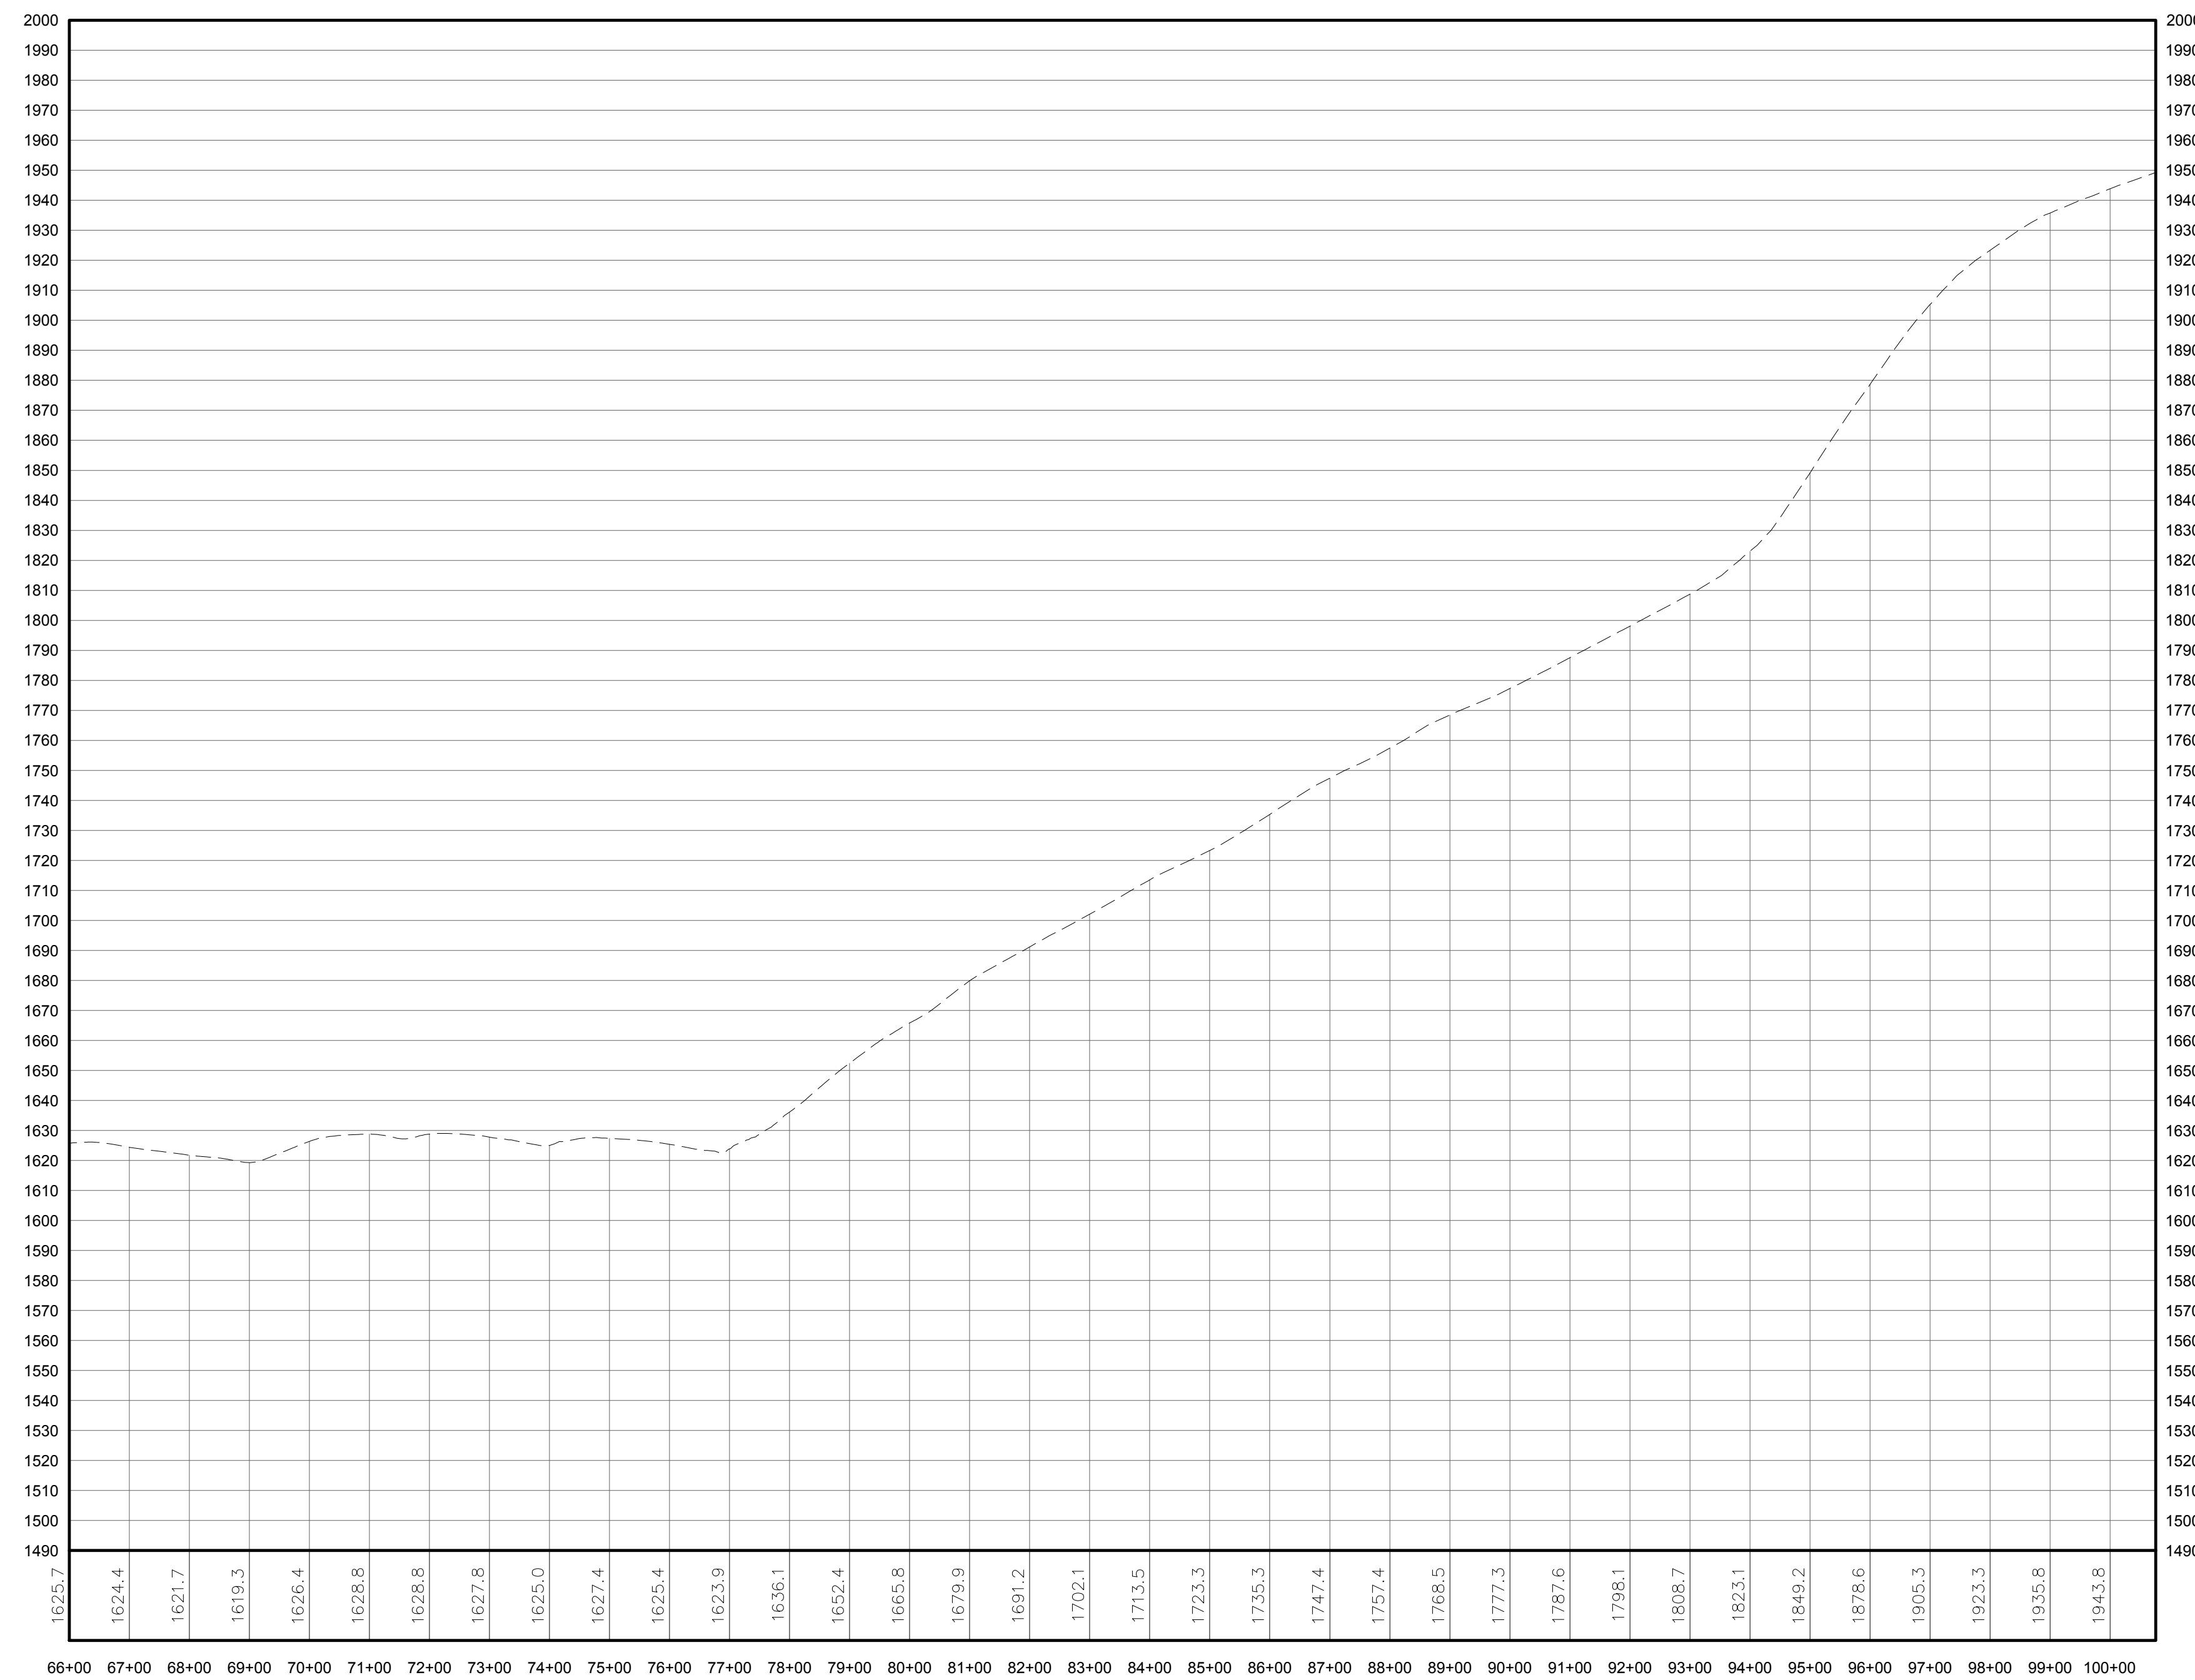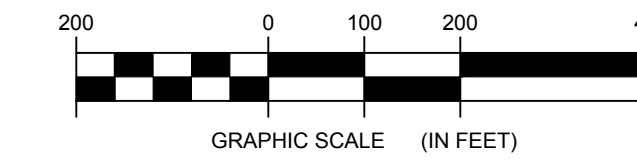

LEGEND	
ITEM	SYMBOL
DRAWING SHEET MATCH LINE	-----
WIND TURBINE DESIGNATION	T53
PARCEL BOUNDARY	-----
115 KV OVERHEAD GENERATOR LEAD LINE	-----
115 KV OVERHEAD GENERATOR LEAD LINE POLE	⊗
UNDERGROUND COLLECTION LINE	-----
OVERHEAD COLLECTION LINE	-----
EXISTING CONTOUR (2' INTERVAL)	-----
EXISTING CONTOUR - INDEX (2' INTERVAL)	-----
PERMANENT ACCESS ROAD EDGE	-----
PERMANENT ACCESS ROAD CENTERLINE	-----
STORM PIPE / CULVERT	-----
NYSDEC WETLAND	-----
WETLAND BOUNDARY	-----
STREAM BOUNDARY	-----
APPROXIMATE WETLAND BOUNDARY	-----
APPROXIMATE STREAM BOUNDARY	-----
ENVIRONMENTALLY SENSITIVE AREA - RESTRICTED ACCESS	-----
ENVIRONMENTALLY SENSITIVE AREA	-----
WIND TURBINE CONSTRUCTION SITE	-----
ROTOR LAYDOWN	-----
WIND TURBINE	-----
GRAVEL PAD	-----
WORK AREA	-----
CRANE PAD	-----
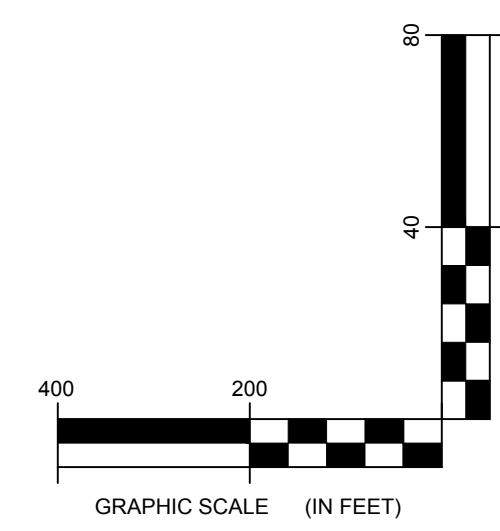
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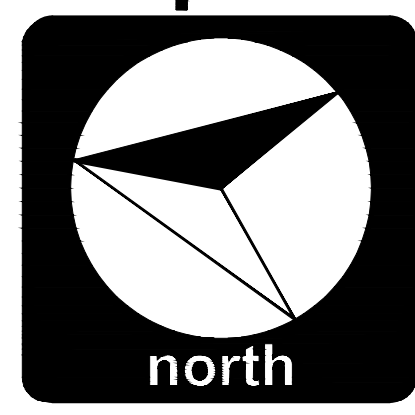
PROFILE LEGEND	
ITEM	SYMBOL
EXISTING ELEVATION (FT)	1845.3
EXISTING GRADE	-----

NOTE: ELEVATIONS IN USGS DATUM.



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DRAWING REVISIONS	
NO.	DATE


PROJECT TITLE: **CASSADAGA WIND PROJECT**
TOWNS OF CHARLOTTE, CHERRY CREEK, ARKWRIGHT, AND STOCKTON
PROJECT LOCATION: CHAUTAUGUS COUNTY, NEW YORK
CLIENT: CASSADAGA WIND LLC
DRAWING TITLE: **COLLECTION LINE PLAN AND PROFILE**

DATE:	APRIL 22, 2016
SCALE:	AS NOTED
edr JOB#: 14048	
DRAWN BY:	AW, CB, ZR
CHECKED BY:	TD
FILE NAME:	14048_Working_SE.dwg
DRAWING NUMBER:	SE-202




LEGEND	
ITEM	SYMBOL
DRAWING SHEET MATCH LINE	-----
WIND TURBINE DESIGNATION	T53
PARCEL BOUNDARY	-----
115 kV OVERHEAD GENERATOR LEAD LINE	-----
115 kV OVERHEAD GENERATOR LEAD LINE POLE	⊕
UNDERGROUND COLLECTION LINE	-----
OVERHEAD COLLECTION LINE	-----
EXISTING CONTOUR (2' INTERVAL)	-----
EXISTING CONTOUR - INDEX (2' INTERVAL)	-----
PERMANENT ACCESS ROAD EDGE	-----
PERMANENT ACCESS ROAD CENTERLINE	-----
STORM PIPE / CULVERT	-----
NYSDEC WETLAND	-----
WETLAND BOUNDARY	-----
STREAM BOUNDARY	-----
APPROXIMATE WETLAND BOUNDARY	-----
APPROXIMATE STREAM BOUNDARY	-----
ENVIRONMENTALLY SENSITIVE AREA - RESTRICTED ACCESS	-----
ENVIRONMENTALLY SENSITIVE AREA	-----
WIND TURBINE CONSTRUCTION SITE	-----
ROTOR LAYDOWN	-----
WIND TURBINE	-----
GRAVEL PAD	-----
WORK AREA	-----
CRANE PAD	-----

1 COLLECTION LINE PLAN VIEW - ALTERNATE ROUTE TO T37
203 Scale: 1"=200'

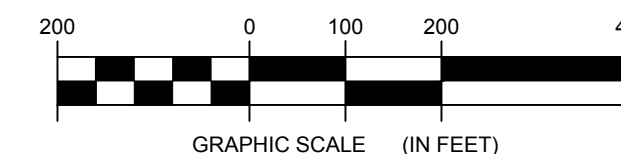


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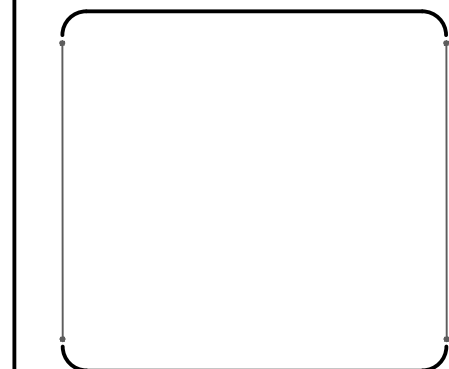


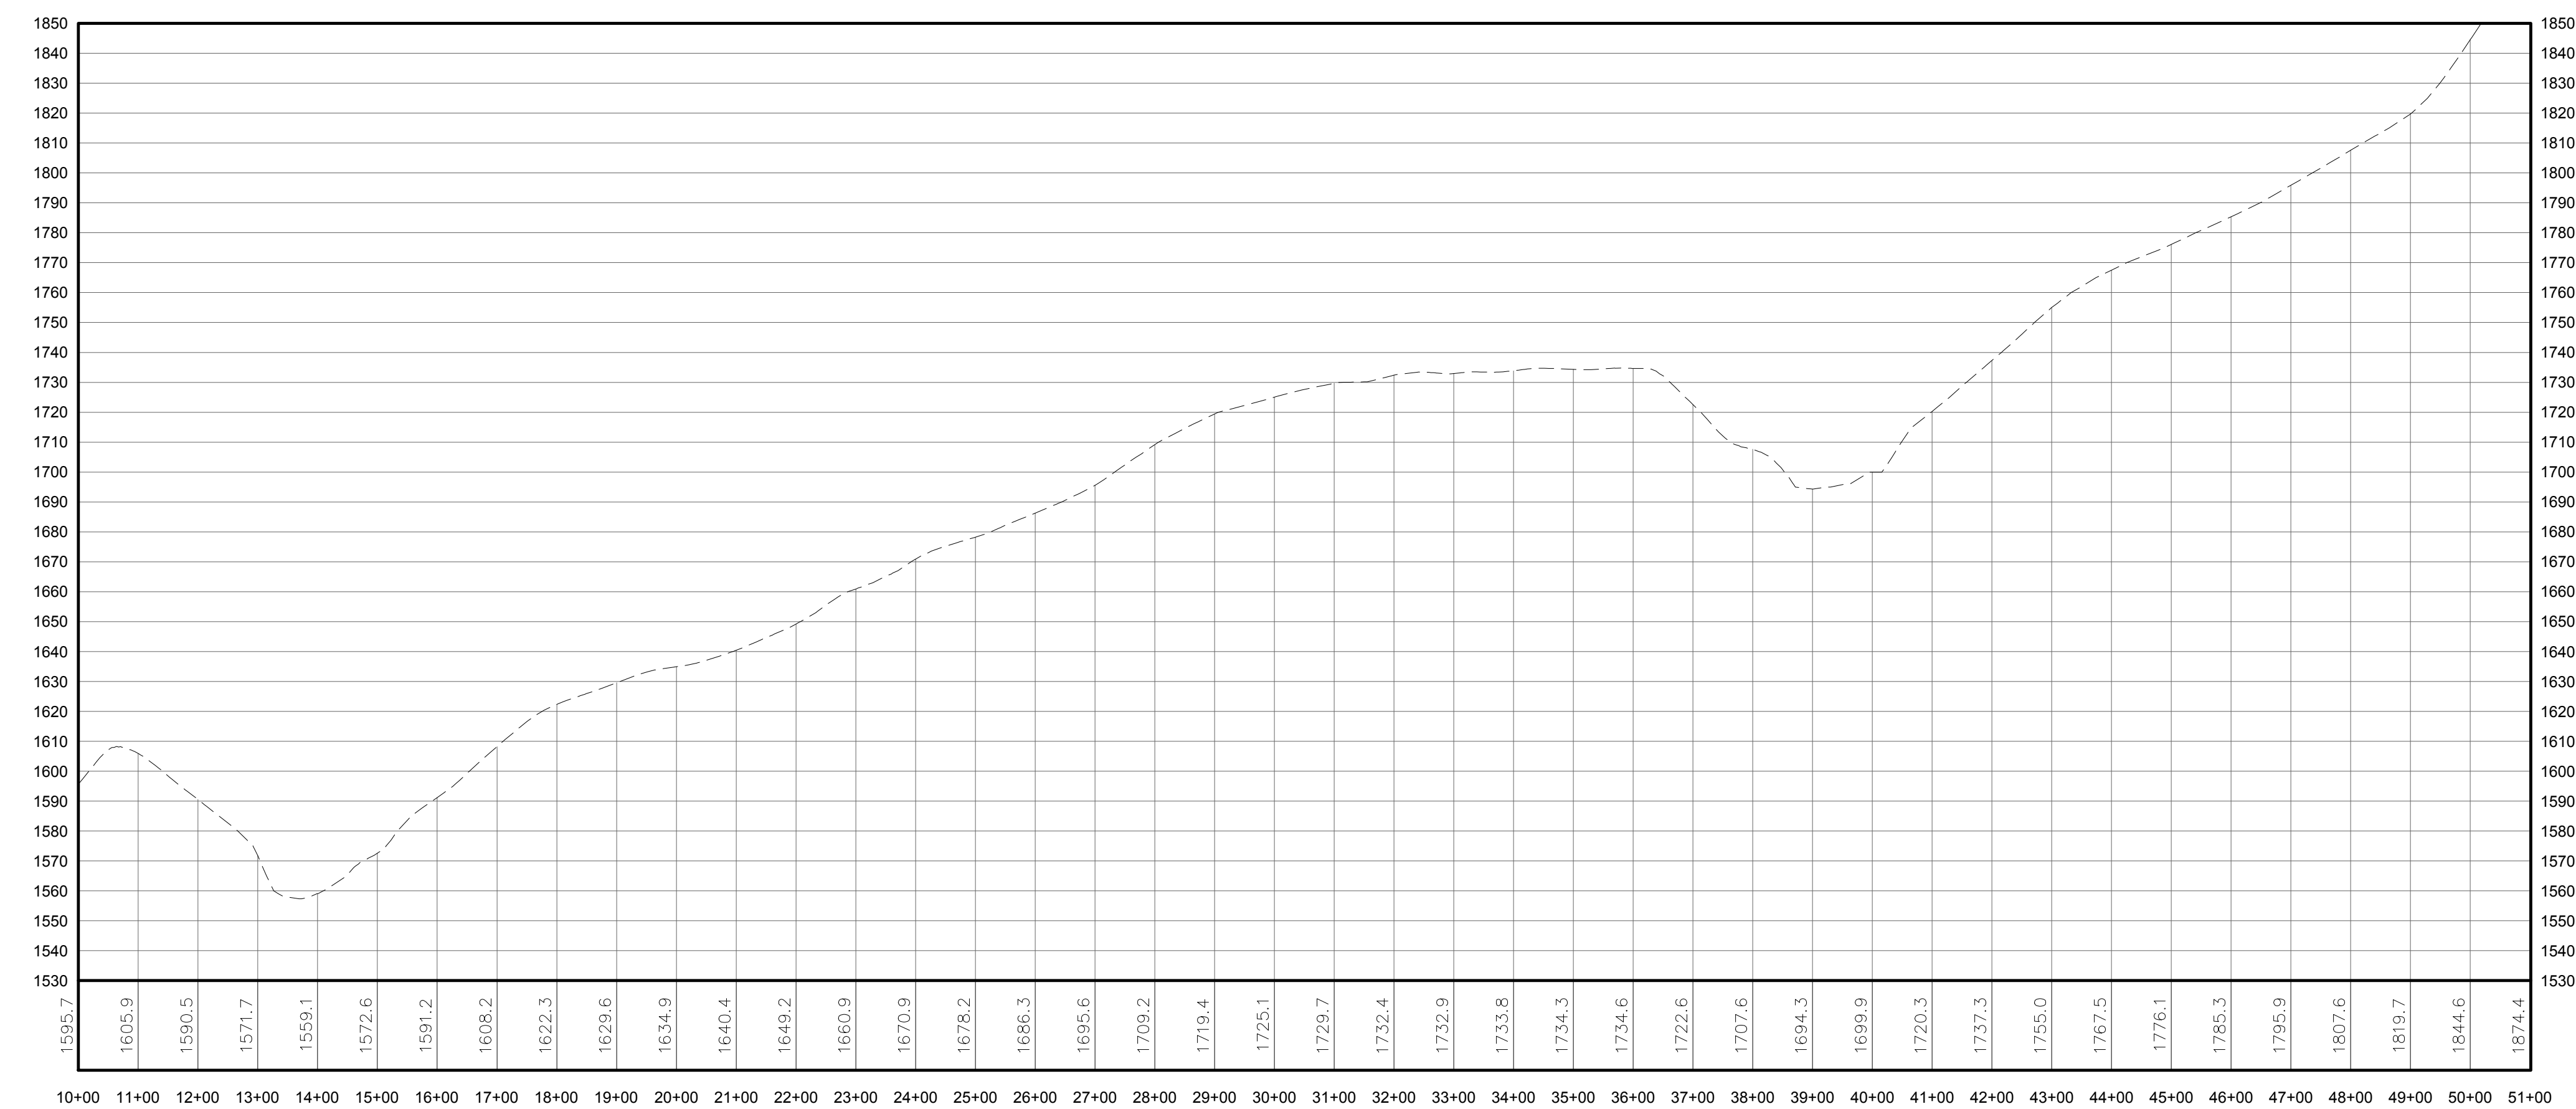PROFILE LEGEND	
ITEM	SYMBOL
EXISTING ELEVATION (FT)	1845.3
EXISTING GRADE	-----

NOTE: ELEVATIONS IN USGS DATUM.

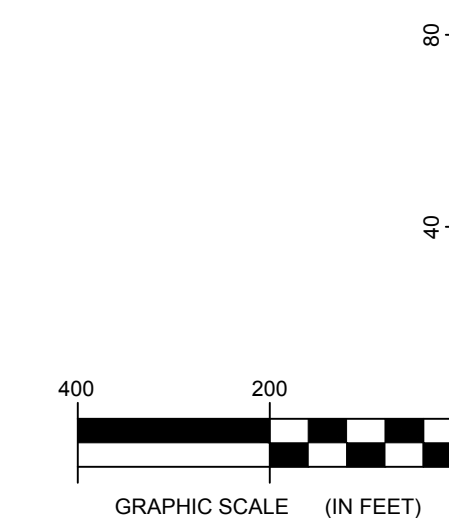

2 COLLECTION LINE PROFILE
203 Scale: H:1"=200' V:1"=40'




DRAWING REVISIONS	
NO.	DATE

PROJECT TITLE: CASSADAGA WIND PROJECT
PROJECT LOCATION: TOWNS OF CHARLOTTE, CHERRY CREEK, ARKWRIGHT, AND STOCKTON CHAUTAUGUS COUNTY, NEW YORK
CLIENT: CASSADAGA WIND LLC
DRAWING TITLE: COLLECTION LINE PLAN AND PROFILE

DATE: APRIL 22, 2016
SCALE: AS NOTED
EDR JOB#: 14048
DRAWN BY: AW, CB, ZR
CHECKED BY: TD
FILE NAME: 14048_Working_SE.dwg
DRAWING NUMBER: SE-203




1 COLLECTION LINE PLAN VIEW - ALTERNATE ROUTE TO T37
204 Scale: 1"=200'

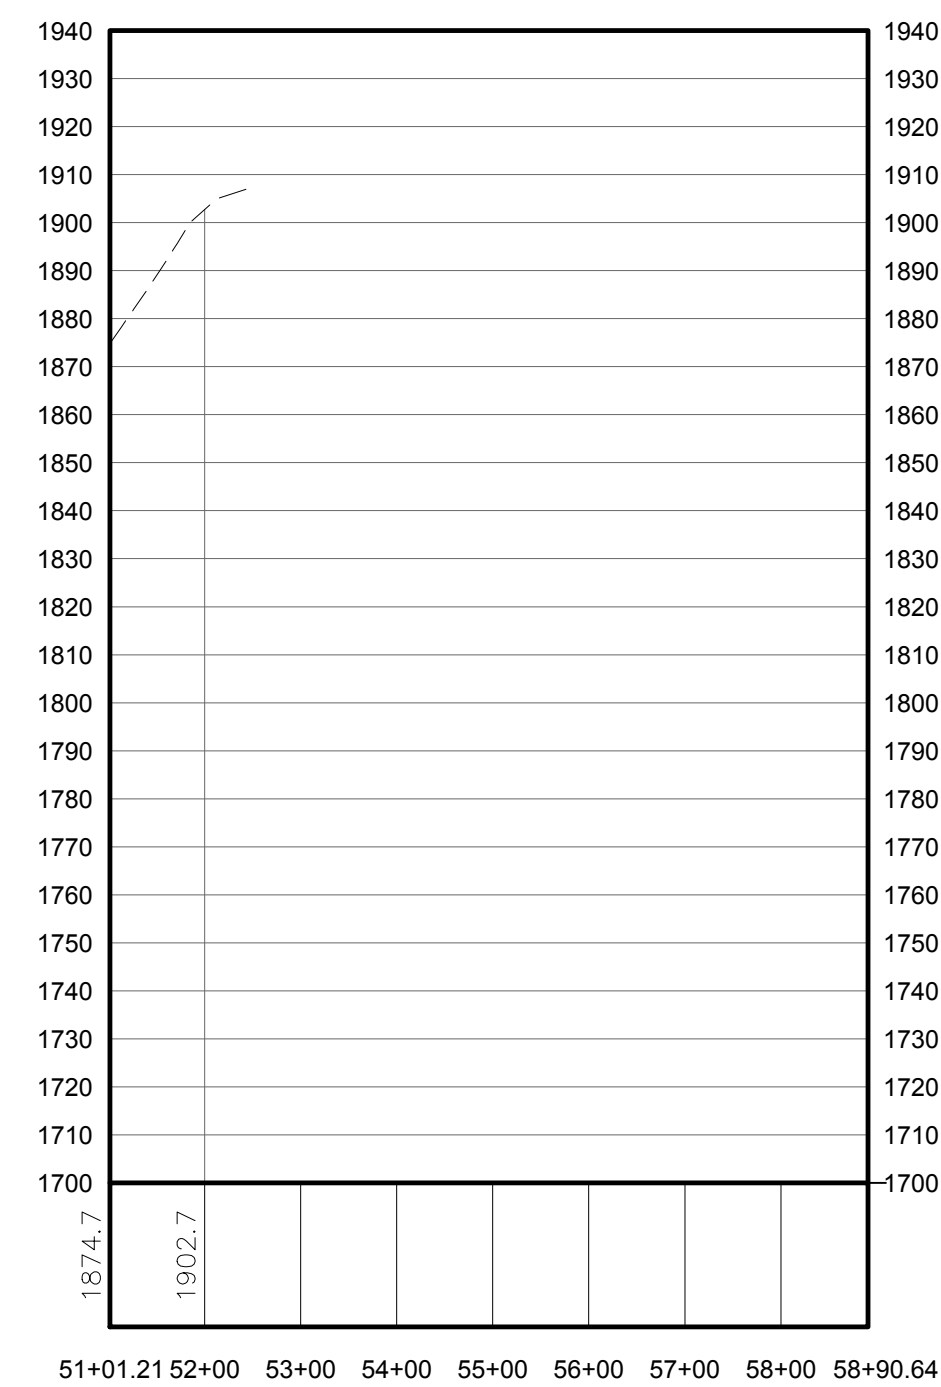

2 COLLECTION LINE PROFILE
204 Scale: H:1"=200' V:1"=40'


LEGEND	
ITEM	SYMBOL
DRAWING SHEET	
MATCH LINE	---
WIND TURBINE DESIGNATION	T53
PARCEL BOUNDARY	---
115 kV OVERHEAD GENERATOR LEAD LINE	---
115 kV OVERHEAD GENERATOR LEAD LINE POLE	⊖
UNDERGROUND COLLECTION LINE	---
OVERHEAD COLLECTION LINE	---
EXISTING CONTOUR (2' INTERVAL)	---
EXISTING CONTOUR - INDEX (2' INTERVAL)	---
PERMANENT ACCESS ROAD EDGE	---
PERMANENT ACCESS ROAD CENTERLINE	---
STORM PIPE / CULVERT	---
NYSDEC WETLAND	---
WETLAND BOUNDARY	---
STREAM BOUNDARY	---
APPROXIMATE WETLAND BOUNDARY	---
APPROXIMATE STREAM BOUNDARY	---
ENVIRONMENTALLY SENSITIVE AREA - RESTRICTED ACCESS	---
ENVIRONMENTALLY SENSITIVE AREA	---
WIND TURBINE CONSTRUCTION SITE	---
ROTOR LAYDOWN	---
WIND TURBINE	---
GRAVEL PAD	---
WORK AREA	---
CRANE PAD	---

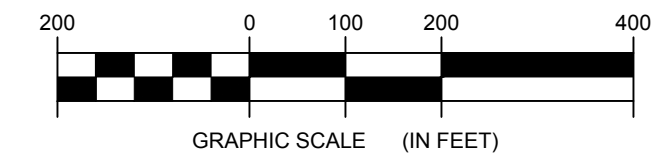

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PROFILE LEGEND	
ITEM	SYMBOL
EXISTING ELEVATION (FT)	1845.3
EXISTING GRADE	---


NOTE: ELEVATIONS IN USGS DATUM.

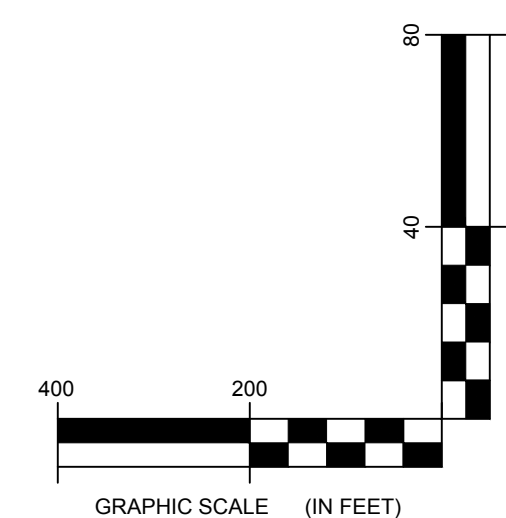

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NO.	DATE	REVISION

PROJECT TITLE:	CASSADAGA WIND PROJECT
PROJECT LOCATION:	TOWNS OF CHARLOTTE, CHERRY CREEK, ARKWRIGHT, AND STOCKTON CHAUTAUQUA COUNTY, NEW YORK
CLIENT:	CASSADAGA WIND LLC
DRAWING TITLE:	COLLECTION LINE PLAN AND PROFILE

DATE:	APRIL 22, 2016
SCALE:	AS NOTED
JOB NO.:	14048
DRAWN BY:	AW, CB, ZR
CHECKED BY:	TD
FILE NAME:	14048_Working_SE.dwg
DRAWING NUMBER:	SE-204
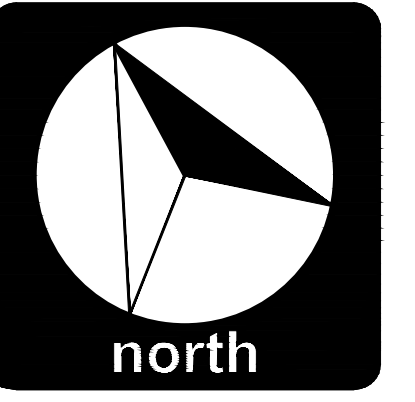
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